CITY OF ALBUQUERQUE



June 23, 2016

Clint Wilsey 66Architect, LLC 2041 South Plaza St., NW Albuquerque, NM 87104

Re: Advanced Auto

10026 Central SE

Traffic Circulation Layout

Engineer's/Architect's Stamp dated 5-19-16 (L20-D056A)

Dear Mr. Clint Wilsey,

The TCL submittal received 6-23-16 is approved for Building Permit. A copy of the stamped and signed plan will be needed for each of the building permit plans. Please keep the original to be used for certification of the site for final C.O. for Transportation.

When the site construction is completed and a Certificate of Occupancy (C.O.) is requested, use the original City stamped approved TCL for certification. Redline any minor changes and adjustments that were made in the field. A NM registered architect or engineer must stamp, sign, and date the certification TCL along with indicating that the development was built in "substantial compliance" with the TCL. Submit this certification TCL with a completed <u>Drainage and Transportation Information Sheet</u> to front counter personnel for log in and evaluation by Transportation.

Albuquerque

PO Box 1293

Once verification of certification is completed and approved, notification will be made to Building Safety to issue Final C.O. To confirm that a final C.O. has been issued, call Building Safety at 924-3690.

New Mexico 87103

Sincerely,

www.cabq.gov

Racquel M. Michel, P.E. Traffic Engineer, Planning Dept. Development Review Services

\gs via: email C: CO Clerk, File

Muy






City of Albuquerque


Planning Department

Development & Building Services Division


DRAINAGE AND TRANSPORTATION INFORMATION SHEET (REV 09/2015)

Project Title: Advance Auto - 10026 Central Ave	Building Permit #: City Drainage #: LODO
DRB#: EPC#:	Work Order#:
Legal Description: Lot 1A Block 6 Skyline Heights	
City Address: 10026 Central Ave. SE, Albuquerque, NM 87117	
Engineering Firm:	Contact:
Address:	
Phone#: Fax#:	E-mail:
Owner 10026 Central LLC	
Owner: 10026 Central, LLC Address: 3535 Princeton Dr. NE, Albuquerque NM 87107	Contact: John Triandafilidis
Dhone#: 702 218 6000 For#:	F-mail:
FINITION 102-210-0333 FAX#.	E-mail:
Architect: 66Architect, LLC	Contact: Clint Wilsey
Address: 2041 South Plaza St. NW Albuquerque, NM 871-4	
Phone#: 505-280-0043 Fax#:	E-mail: clint.wilsey@gmall.com
Other Contact:	Contact:
Addrogg	
	E-mail:
Check all that Apply:	
DEPARTMENT:	CHECK TYPE OF APPROVAL/ACCEPTANCE SOUGHT:
HYDROLOGY/ DRAINAGE	× BUILDING PERMIT APPROVAL
* TRAFFIC/ TRANSPORTATION MS4/ EROSION & SEDIMENT CONTROL	CERTIFICATE OF OCCUPANCY
TYPE OF SUBMITTAL:	PRELIMINARY PLAT APPROVAL
ENGINEER/ ARCHITECT CERTIFICATION	SITE PLAN FOR SUB'D APPROVAL
CONCERTIAL C & D DI ANI	SITE PLAN FOR BLDG PERMIT APPROVAL
CONCEPTUAL G & D PLAN GRADING PLAN	FINAL PLAT APPROVAL C 6 C V C
DRAINAGE MASTER PLAN	SIA/ RELEASE OF FINANCIAL GUARANTEE
DRAINAGE REPORT	foundation permit approval 2016
CLOMR/LOMR	CO 10 APPROVIAT
	PAVING PERMIT APPROVAL.
x TRAFFIC CIRCULATION LAYOUT (TCL)	GRADING/ PAD CERTIFICATION
TRAFFIC IMPACT STUDY (TIS)	WORK ORDER APPROVAL
EROSION & SEDIMENT CONTROL PLAN (ESC)	CLOMR/LOMR DEPENVED
OTHER (SPECIFY)	PRE-DESIGN MEETING 1
	OTHER (SPECIFY)
IS THIS A RESUBMITTAL?: Yesx No	DOBNE POSKA SSCHON
DATE SUBMITTED: 6-21-16	By: Clint Wilsey Quantum

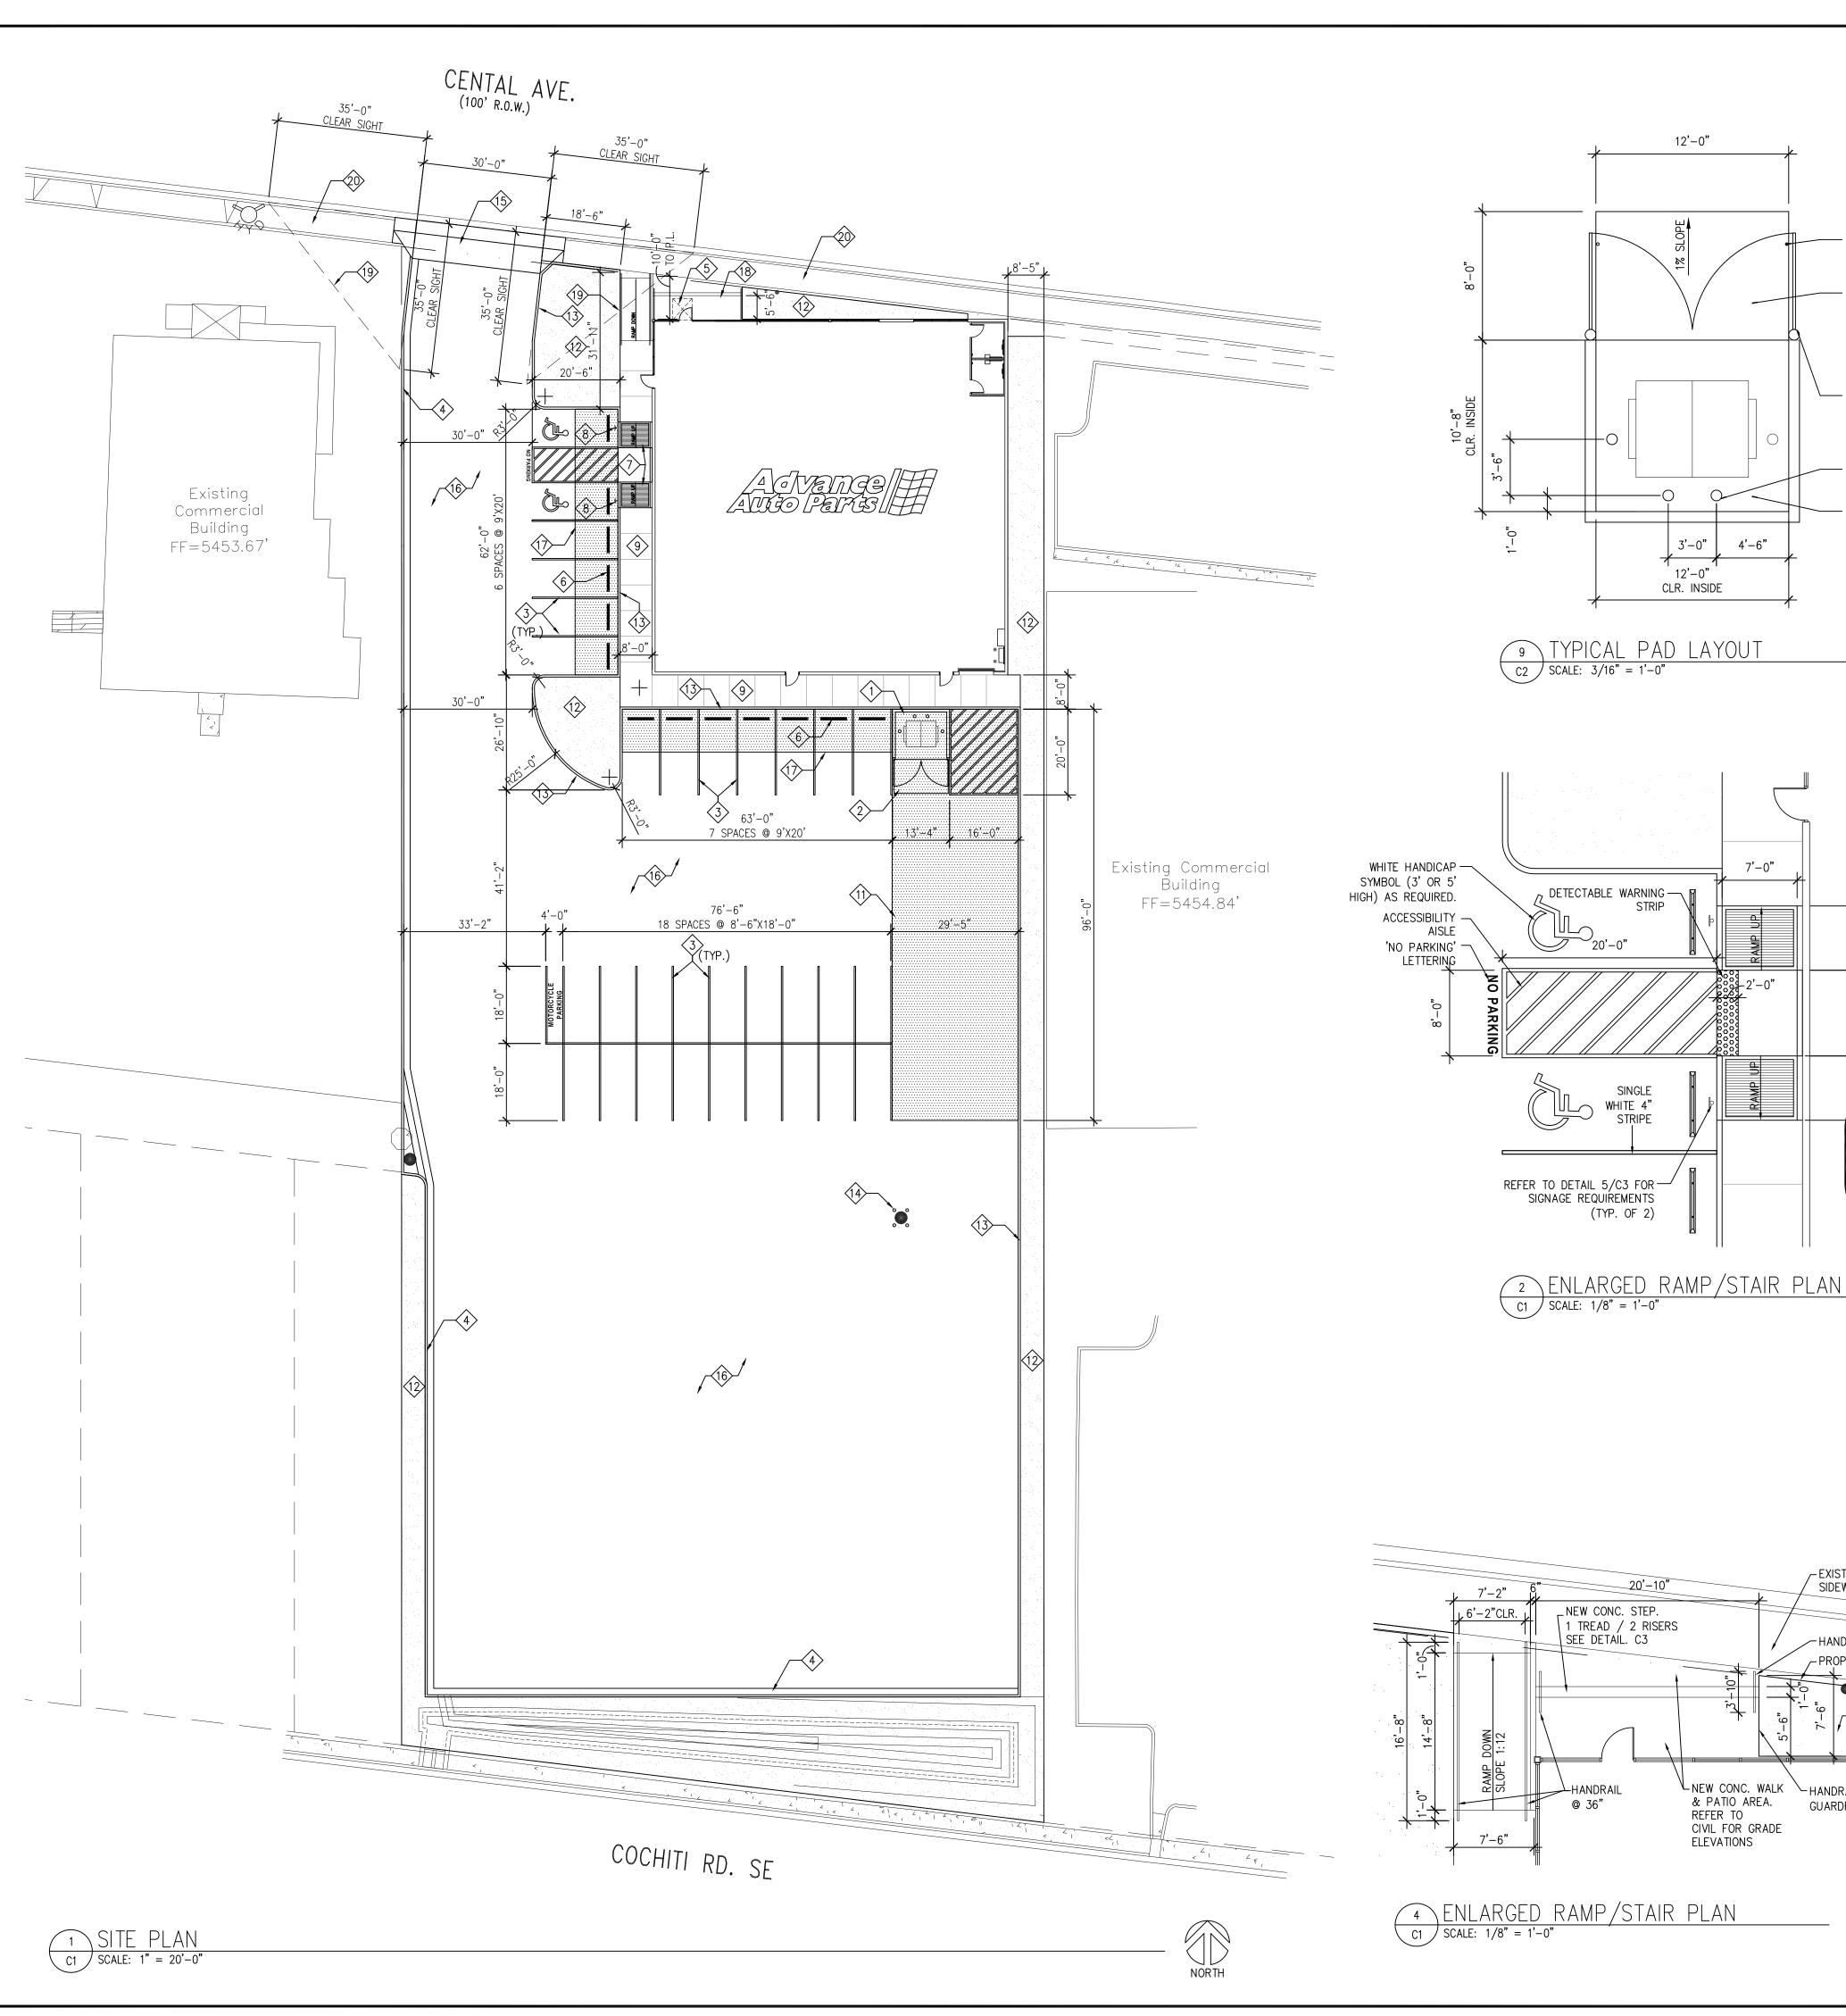

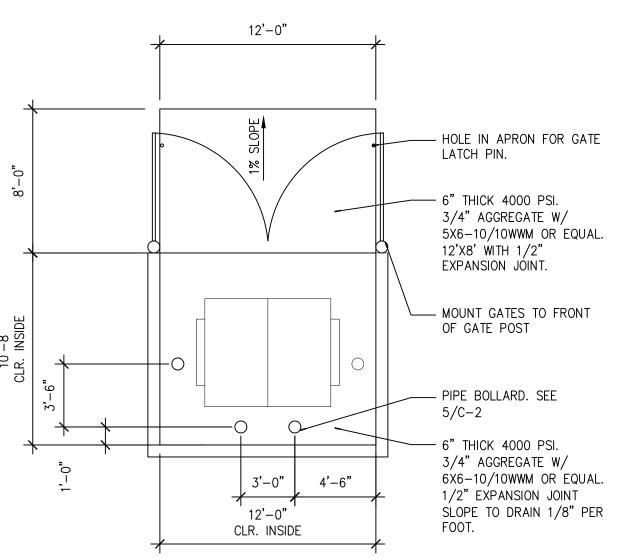

9 TYPICAL PAD LAYOUT C2 | SCALE: 3/16" = 1'-0"

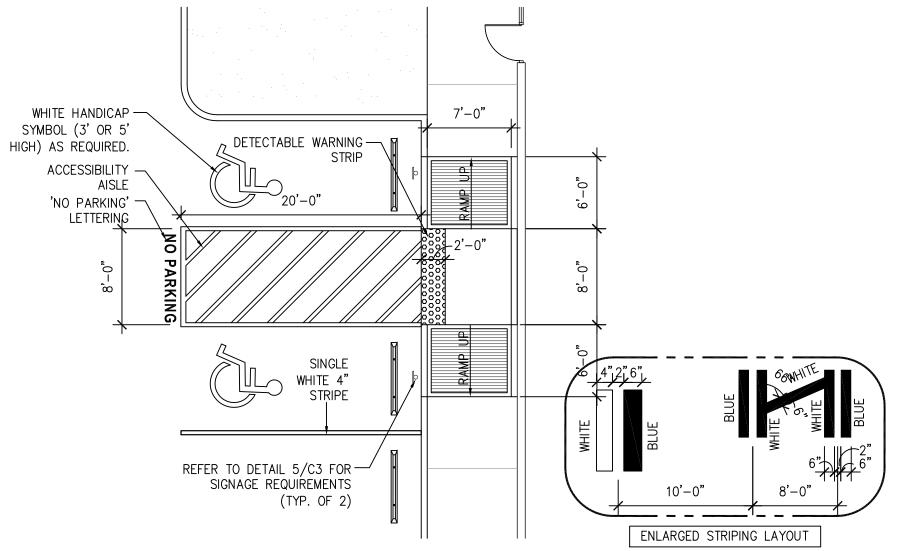

SITE ARCHITECTURAL KEY NOTES: DUMPSTER ENCLOSURE. SEE DETAIL 9/C2

TOTAL PROVIDED

HANDICAP PARKING

MOTORCYCLE PARKING

SITE AREA

BUILDING

PAVEMENT

FRONT

REAR

SIDE

SIDE

GREEN/OPEN SPACE 9,091 SF

INSTALL NEW 6" THICK CONCRETE LOADING PAD OF 4000 PSI BROOM FINISHED CONCRETE W/ 3/4" AGGREGATE W/ 6"x6"x W2.1/2.1 WWM STEEL REINFORCEMENT. SLOPE AWAY FROM BUILDING 1/8" PER FOOT FOR POSITIVE DRAINAGE. REFER TO DETAIL 9/C2. PLACE OVER 4" COMPACTED BASE COURSE OVER 12" OF STRUCTURAL FILL. REFER TO GEOTECHNICAL REPORT.

SITE DATA

TOTAL LOT SQ. FT. = 52,442 SF./CONSTRUCTION AREA = 52,442 SF TOTAL LOT ACRES = 1.20 ACRES/CONSTRUCTION AREA =1.20 ACRES

36,461 SF

REQUIRED

15' MIN

0'-10' MAX

0'-10' MAX

0'-10' MAX

W/10% PARKING REDUCTION FOR PROXIMITY TO BUS STOP

= 31 SPACES REQ'D

31 SPACES

2 SPACES

1 SPACE

MAXIMUM BUILDING HEIGHT 65 FT. MAX

1 PER 200F @ 6889 = 34 SPACES

13% OF TOTAL AREA

69% OF TOTAL AREA

17% OF TOTAL AREA

PROVIDED 0'-10' FT.

±260' FT.

8'-5" FT.

58'-6" FT.

- ASPHALT PAVEMENT PARKING LINES 4" WIDE PAINTED WHITE WITH TWO (2) COATS OF SHERWIN WILLIAMS "HOTLINE" FAST DRYING TRAFFIC MARKING PAINT. HANDICAP PARKING & HANDICAP SYMBOL TO BE PAINTED COLOR & SIZE AS REQUIRED BY THE GOVERNING ACCESSIBILITY CODE. CONCRETE PAVEMENT PARKING LINES FOR ACCESSIBLE SPACES SHALL BE THE SAME AS ABOVE EXCEPT USE BLUE OR YELLOW PAINT. REFER TO DETAILS 1/C3 AND 2/C3 FOR ADDITIONAL INFORMATION.
- (4) CONSTRUCT 6" HIGH CONC. CURB & GUTTER CONTINUOUS AROUND SITE. BACKFILL TO TOP OF CURB. REFER TO DETAIL 3/C2. PROVIDE CATCH & SPILL WHERE APPLICABLE.
- 5 54"X60" CLEAR APPROACH AREA
- (6) ANCHOR DOWN CONCRETE WHEEL STOPS 30" FROM FACE OF CONCRETE WALK/SIDEWALK. REFER TO DETAIL 10/C2.
- PROVIDE HANDICAP RAMP WHEN PAVING IS NOT FLUSH WITH ENTRY SIDEWALK PER FEDERAL & LOCAL ACCESSIBILITY REQUIREMENTS. REFER TO DETAILS ON SHEET C3.
- 8 HANDICAP PARKING SIGN FOR SPACES ADJACENT TO BUILDING ENTRANCE. REFER TO DETAIL 5/C3.
- (9) NEW BROOM FINISHED CONCRETE SIDEWALK SLOPED AWAY FROM BUILDING 1/8"/FT. FOR POSITIVE DRAINAGE.
- (10) NEW CONCRETE ADA ACCESSIBLE RAMP. 1:12 SLOPE MIN. W/ HANDRAILS @ 36" ON EA. SIDE. SEE DETAIL 3&4/C1
- 6" PORTLAND CEMENT CONCRETE OVER 4" COMPACTED BASE COURSE OVER 12" STRUCTURAL FILL. REFER TO GEOTECHNICAL REPORT
- (12) LANDSCAPING
- (13) CONCRETE CURB, REFER TO DETAIL 7/C2 FOR ADDITIONAL INFORMATION.
- PROVIDE BOLLARDS AT ALL EXTERIOR MOUNTED METERING DEVICES. (GAS, WATER, ELECTRIC) AND OVERHEAD UTILITY POLES MIN. (2) TWO AS REQUIRED - SEE DETAIL 5/C2.
- 15 NEW CURB CUT
- (16) ASPHALT/CONCRET PAVEMENT (3" ASPHALTIC CONCRETE OVER 3" AGGREGATE BASE COURSE OVER 12" STRUCTURAL FILL.) REFER TO GEOTECHNICAL SPECIFICATIONS.
- (17) 6" CONCRETE APRON WITH 6" X 6" X 1/8" W.W.F. STEEL REINFORCEMENT. USE 4000 PSI CONCRETE MIX. DO NOT USE SLAG OR FLY ASH FOR CEMENTITIOUS MATERIAL. PLACE OVER 4" COMPACTED BASE COURSE OVER 12" OF STRUCTURAL FILL. REFER TO GEOTECHNICAL SPECIFICATIONS
- (18) NEW CONCRETE STAIRS WITH HANDRAILS AT 36" ON EA. SIDE. SEE DETAIL 2&4/C1
- CLEAR SIGHT TRIANGLE PER CITY OF ABQ DEVELOPMENT PROCESS MANUAL, CHAPTER 23, SECT. 3, PART. D5 INTERSECTION SIGHT DISTANCE. NOTE* LANDSCAPING AND SIGNAGE WILL NOT INTERFERE WITH CLEAR SIGHT REQUIREMENTS. THEREFORE, SIGNS, WALLS, TREES AND SHRUBBERY BETWEEN 3 AND 8 FEET TALL (AS MEASURED FROM GUTTER PAN) WILL NOT BE ACCEPTABLE IN THIS AREA.
- 20 EXISTING 6' PUBLIC SIDEWALK
- 20 EXISTING FIRE HYDRANT



UPC# 102005642750111516 ZONE ATLAS PAGE: L-20-Z ZONING: SU-2 EGC



No.005139 66ARCHITECT, LLC Clint Wilsey, Architect clint.wilsey@gmail.com 505 280-0043

> TRAFFIC CIRCULATION LAYOUT

6,889 SF.

5-19-16

PROJECT # AA 16_002

DRAWN BY: Clint Wilsey CHECK BY: Clint Wilsey

VERSION Q4- 83x83 ALL REPORTS, PLANS, SPECIFICATION FIELD DATA, NOTES AND OTHER

DOCUMENTS, INCLUDING ALL
DOCUMENTS ON ELECTRONIC MEDIA

PREPARED BY THE DESIGN

PROFESSIONAL AS INSTRUMENTS OF SERVICE SHALL REMAIN THE PROPERT

OF THE DESIGN PROFESSIONAL.

WITHOUT PRIOR CONSENT OF THE DESIGN PROFESSIONAL. ALL COMMON

LAW RIGHTS OF COPYRIGHT AND OTHERWISE, ARE HEREBY SPECIFICALLY RESERVED

5-19-16

CLINTON J. WILSEY



GRADE

_LANDSCAPE AREA ←NEW CONC. WALK — HANDRAIL/ & PATIO AREA. GUARDRAIL @ 36" REFER TO CIVIL FOR GRADE ELEVATIONS

EXISTING PUBLIC

-HANDRAIL @ 36'

-PROPERTY LINE

SIDEWALK

4 ENLARGED RAMP/STAIR PLAN

_NEW CONC. STEP.

SEE DETAÍL. C3

1 TREAD / 2 RISERS

HANDICAP SIGNAGE C3 $\int SCALE$: 1" = 1'-0"