CITY OF ALBUQUERQUE



January 26, 2017

Clint Wilsey, RA 66 Architect, LLC 3535 Princeton NE Albuquerque, NM 87107

Re:

Advance Auto, 10026 Central Ave. SE

Request for Certificate of Occupancy- Transportation Development

Engineer's/Architect's Stamp dated 05-19-17 (L20-D056A)

Certification dated 01-19-17

Dear Mr. Wilsey

Based upon the information provided in your submittal received 01-20-17, Transportation Development has no objection to the issuance of a <u>Permanent Certificate of Occupancy</u>. This letter serves as a "green tag" from Transportation Development for a <u>Permanent Certificate of Occupancy</u> to be issued by the Building and Safety Division.

PO Box 1293

If you have any questions, please contact me at (505) 924-3630.

Albuquerque

Sincerely,

New Mexico 87103

Logan Patz

Senior Engineer, Planning Dept. Development Review Services

Loyar Pot

www.cabq.gov

LWP via: email C: CO Clerk, File



City of Albuquerque

Planning Department

Development & Building Services Division

DRAINAGE AND TRANSPORTATION INFORMATION SHEET (REV 09/2015)

Project Title:		Building Permit #:	City Drainage #:	
DRB#:	EPC#:		k Order#:	
Legal Description:				
City Address:				
Engineering Firm:		Cont	act:	
Address:				
Phone#:	Fax#:	E-ma	ail:	
Owner:		Cont	act:	
Address:				
Phone#:	Fax#:	E-ma	ail:	
Architect:		Cont	act:	
Address:				
Phone#:	Fax#:	E-ma	ail:	
Other Contact:		Cont	act:	
Address:				
Phone#:	Fax#:	E-ma	ail:	
Check all that Apply: DEPARTMENT: HYDROLOGY/ DRAINAGE			ROVAL/ACCEPTANCE SOUGHT:	
TRAFFIC/ TRANSPORTATION			BUILDING PERMIT APPROVAL	
MS4/ EROSION & SEDIMENT CO	NTROL	CERTIFICATE OF	OCCUPANCY	
TYPE OF SUBMITTAL:		PRELIMINARY PI	AT APPROVAL	
ENGINEER/ ARCHITECT CERTIFIC	CATION		SITE PLAN FOR SUB'D APPROVAL	
		SITE PLAN FOR B	LDG. PERMIT APPROVAL	
CONCEPTUAL G & D PLAN		FINAL PLAT APPROVAL		
GRADING PLAN		SIA/ RELEASE OF	SIA/ RELEASE OF FINANCIAL GUARANTEE	
DRAINAGE MASTER PLAN		FOUNDATION PE	FOUNDATION PERMIT APPROVAL	
DRAINAGE REPORT		GRADING PERMI	GRADING PERMIT APPROVAL	
CLOMR/LOMR		SO-19 APPROVAL	SO-19 APPROVAL	
		PAVING PERMIT		
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TRAFFIC IMPACT STUDY (TIS) EROSION & SEDIMENT CONTRO	L PLAN (ESC)	PAVING PERMIT GRADING/ PAD C WORK ORDER APP CLOMR/LOMR PRE-DESIGN MEET	APPROVAL ERTIFICATION ROVAL ING	
TRAFFIC IMPACT STUDY (TIS) EROSION & SEDIMENT CONTRO	L PLAN (ESC)	PAVING PERMIT GRADING/ PAD C WORK ORDER APP CLOMR/LOMR PRE-DESIGN MEET	APPROVAL ERTIFICATION ROVAL	
TRAFFIC IMPACT STUDY (TIS) EROSION & SEDIMENT CONTRO OTHER (SPECIFY)	L PLAN (ESC)	PAVING PERMIT GRADING/ PAD C WORK ORDER APP CLOMR/LOMR PRE-DESIGN MEET OTHER (SPECIFY	APPROVAL ERTIFICATION ROVAL ING	

COA STAFF: ELECTRONIC SUBMITTAL RECEIVED: ____


66Architect


January 19, 2017


2041 S. Plaza St. NW Albuquerque, NM 87104 Ph. 505.280.0043 clint.wilsey@gmail.com

TRAFFIC CERTIFICATION


I,Clinton J. Wilsey FIRM66Architect, LLC	, NMPE OR <u>NMRA</u> _	005139, OF TH	ΗE
FIRM66Architect, LLC	, HEREBY CERTIFY	THAT THIS PROJECT IS I	IN
SUBSTANTIAL COMPLIANCE	WITH AND IN ACCORD	DANCE WITH THE DESIG	Νί
INTENT OF THE APPROVED PL			
INFORMATION EDITED ONTO	THE ORIGINAL DESIGNATION	GN DOCUMENT HAS BEE	ΞN
OBTAINED BYClint Wilsey_	OF THE FIRM66Ar	chitect, LLC	
I FURTHER CERTIFY THAT I I	HAVE PERSONALLY VISI	ITED THE PROJECT SITE C	N
_January 12, 2017 A	ND HAVE DETERMINE	D BY VISUAL INSPECTION	NC
THAT THE SURVEY DATA F	ROVIDED IS REPRESEN	NTATIVE OF ACTUAL SIT	ΓΕ
CONDITIONS AND IS TRUE AN	D CORRECT TO THE BES	ST OF MY KNOWLEDGE AN	۱D
BELIEF. THIS CERTIFICATION	N IS SUBMITTED IN SU	PPORT OF A REQUEST FO	ЭR
certificate of occupancy			
Revisions that occurred during con			
side of the building (adjacent the	building) to the south sid	le row of parking (adjacent t	the
building). Total parking count did			
THE RECORD INFORMATIO			
COMPLETE AND INTENDED			
THE TRAFFIC ASPECTS OF T	THIS PROJECT. THOSE	RELYING ON THE RECOR	RD
DOCUMENT ARE ADVISED	TO OBTAIN INDEPENDI	ENT VERIFICATION OF I	TS
ACCURACY BEFORE USING IT	FOR ANY OTHER PURPO	OSE.	
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menternal			
	ENGINEER'S OR	ARCHITECT'S STAMP	
Signature of Engineer or Architect			
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_1-19-17	9 ULINT	on J. 16	
Date	IZ WILS	EY L	

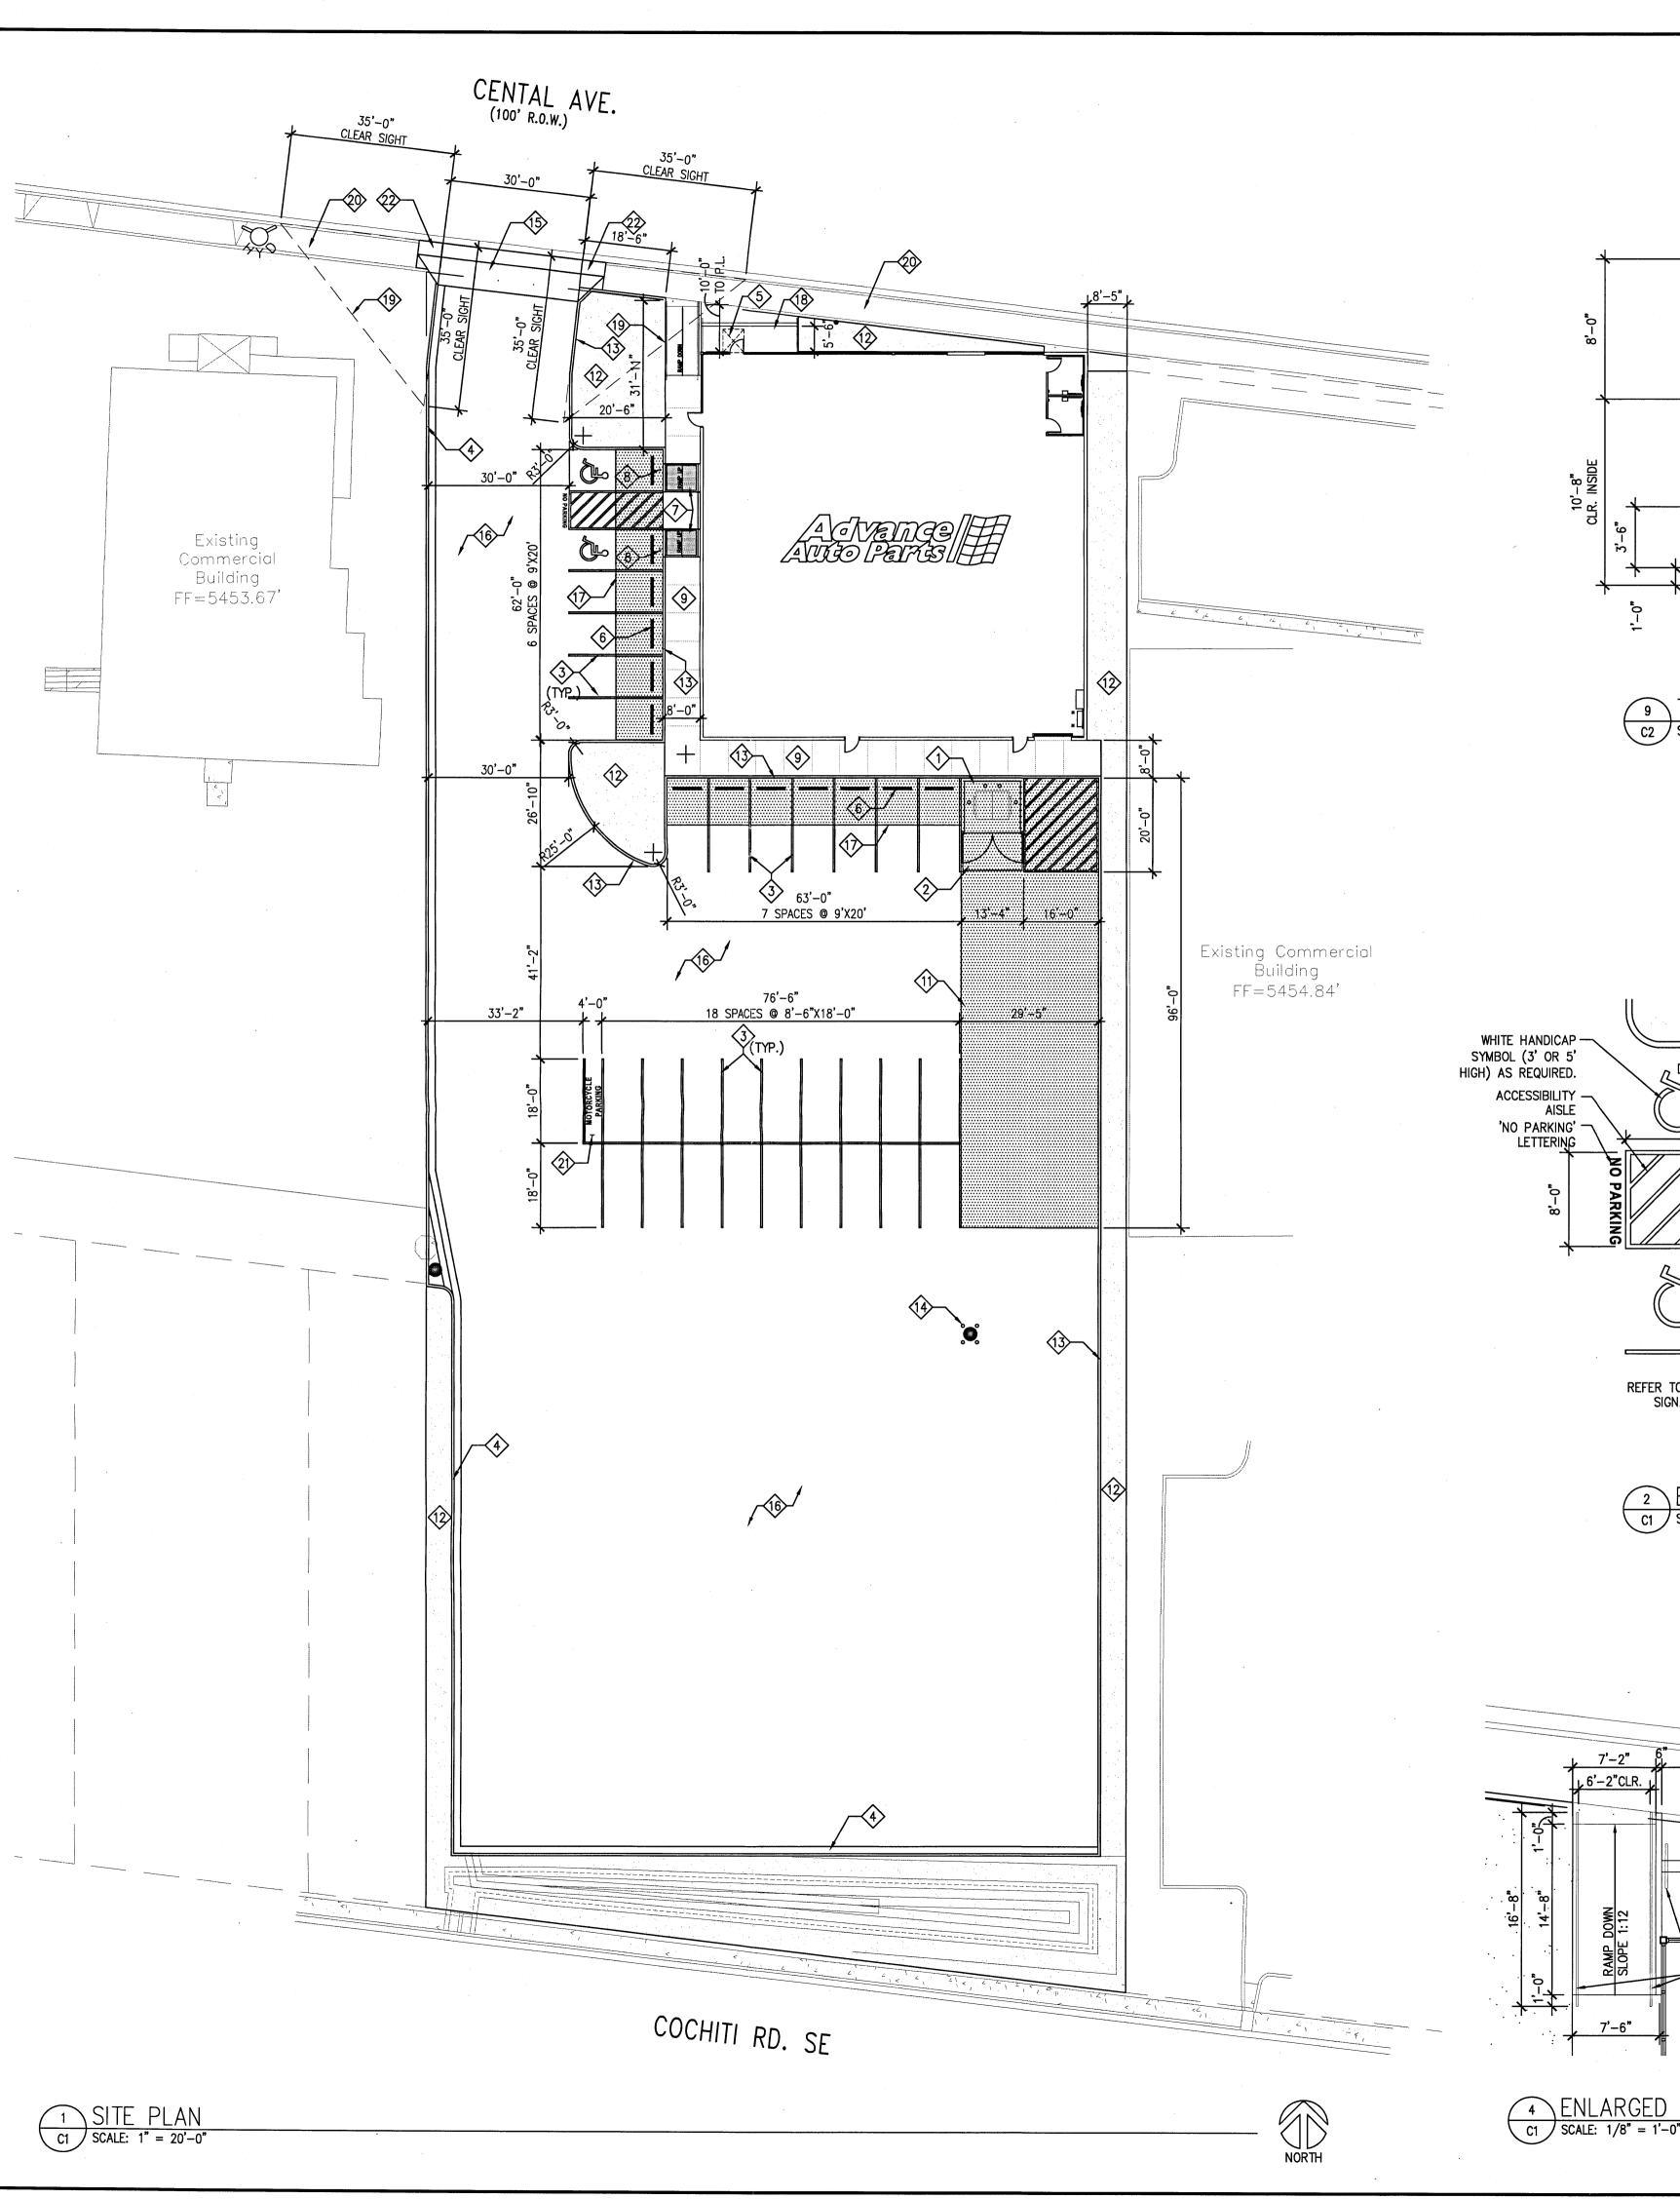

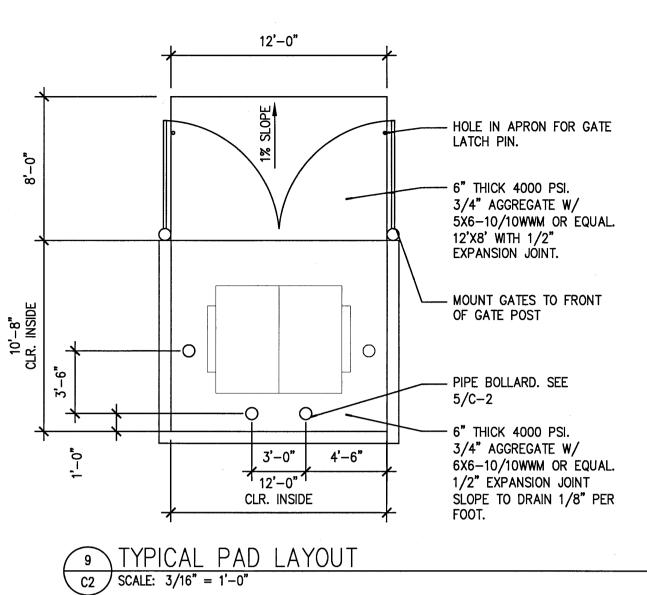

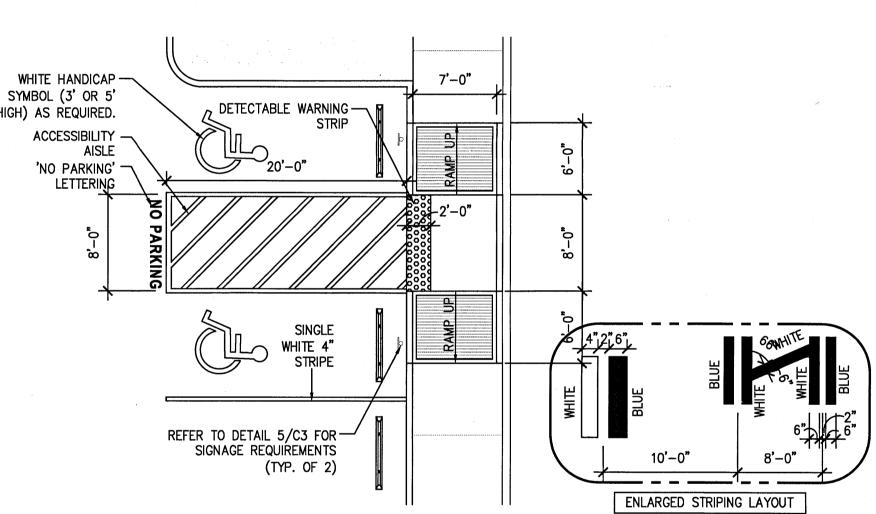


2 ENLARGED RAMP/STAIR PLAN c1 scale: 1/8" = 1'-0"

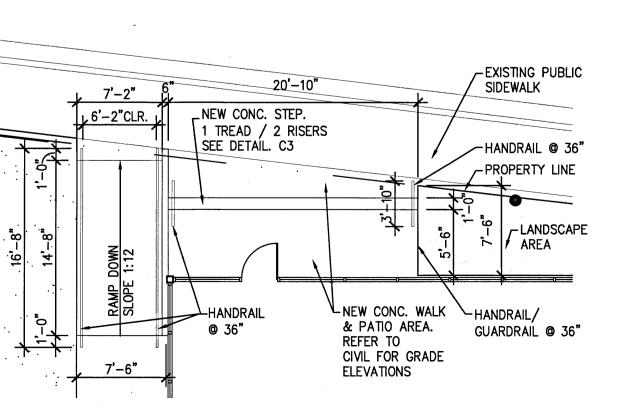


ENLARGED RAMP/STAIR PLAN

SCALE: 1/8" = 1'-0"

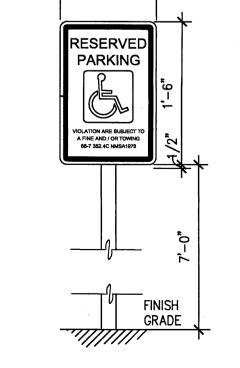


C3 SCALE: 1" = 1'-0"

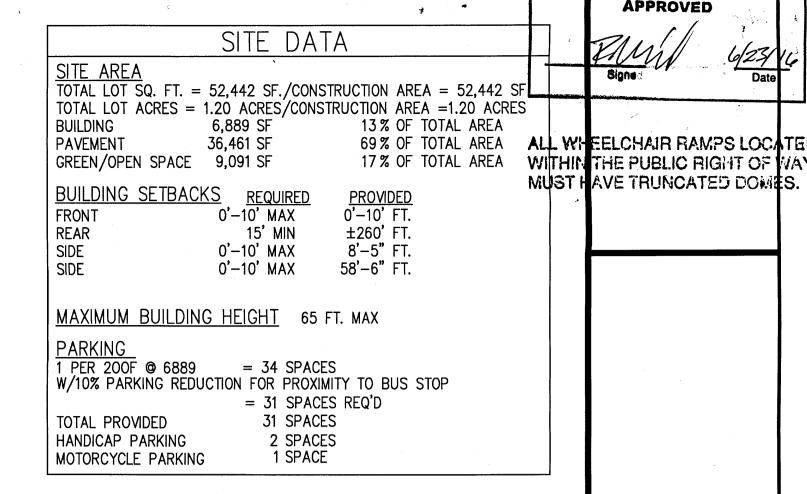

SITE ARCHITECTURAL KEY NOTES:

- DUMPSTER ENCLOSURE. SEE DETAIL 9/C2
- INSTALL NEW 6" THICK CONCRETE LOADING PAD OF 4000 PSI BROOM FINISHED CONCRETE W/ 3/4" AGGREGATE W/ 6"x6"x W2.1/2.1 WWM STEEL REINFORCEMENT. SLOPE AWAY FROM BUILDING 1/8" PER FOOT FOR POSITIVE DRAINAGE. REFER TO DETAIL 9/C2. PLACE OVER 4" COMPACTED BASE COURSE OVER 12" OF STRUCTURAL FILL. REFER TO GEOTECHNICAL REPORT.
- ASPHALT PAVEMENT PARKING LINES 4" WIDE PAINTED WHITE WITH TWO (2) COATS OF SHERWIN WILLIAMS "HOTLINE" FAST DRYING TRAFFIC MARKING PAINT. HANDICAP PARKING & HANDICAP SYMBOL TO BE PAINTED COLOR & SIZE AS REQUIRED BY THE GOVERNING ACCESSIBILITY CODE. CONCRETE PAVEMENT PARKING LINES FOR ACCESSIBLE SPACES SHALL BE THE SAME AS ABOVE EXCEPT USE BLUE OR YELLOW PAINT. REFER TO DETAILS 1/C3 AND 2/C3 FOR ADDITIONAL INFORMATION.
- CONSTRUCT 6" HIGH CONC. CURB & GUTTER CONTINUOUS AROUND SITE. BACKFILL TO TOP OF CURB. REFER TO DETAIL 3/C2. PROVIDE CATCH & SPILL WHERE APPLICABLE.
- 5 54"X60" CLEAR APPROACH AREA
- 6 ANCHOR DOWN CONCRETE WHEEL STOPS 30" FROM FACE OF CONCRETE WALK/SIDEWALK. REFER TO DETAIL 10/C2.
- PROVIDE HANDICAP RAMP WHEN PAVING IS NOT FLUSH WITH ENTRY SIDEWALK PER FEDERAL & LOCAL ACCESSIBILITY REQUIREMENTS. REFER TO DETAILS ON SHEET C3.
- (8) HANDICAP PARKING SIGN FOR SPACES ADJACENT TO BUILDING ENTRANCE. REFER TO DETAIL 5/C3.
- 9 NEW BROOM FINISHED CONCRETE SIDEWALK SLOPED AWAY FROM BUILDING 1/8"/FT. FOR POSITIVE DRAINAGE.
- (10) NEW CONCRETE ADA ACCESSIBLE RAMP. 1:12 SLOPE MIN. W/ HANDRAILS @ 36" ON EA. SIDE. SEE DETAIL 3&4/C1
- 6" PORTLAND CEMENT CONCRETE OVER 4" COMPACTED BASE COURSE OVER 12" STRUCTURAL FILL. REFER TO GEOTECHNICAL REPORT
- 12 LANDSCAPING
- (13) CONCRETE CURB, REFER TO DETAIL 7/C2 FOR ADDITIONAL INFORMATION.
- PROVIDE BOLLARDS AT ALL EXTERIOR MOUNTED METERING DEVICES. (GAS, WATER, ELECTRIC) AND OVERHEAD UTILITY POLES MIN. (2) TWO AS REQUIRED — SEE DETAIL 5/C2.
- (15) NEW CURB CUT & DRIVE PAD. REFER TO COA STANDARD DWG. 2425
- ASPHALT/CONCRET PAVEMENT (3" ASPHALTIC CONCRETE OVER 3" AGGREGATE BASE COURSE OVER 12" STRUCTURAL FILL.) REFER TO GEOTECHNICAL SPECIFICATIONS.
- 6" CONCRETE APRON WITH 6" X 6" X %" W.W.F. STEEL REINFORCEMENT. USE 4000 PSI CONCRETE MIX. DO NOT USE SLAG OR FLY ASH FOR CEMENTITIOUS MATERIAL. PLACE OVER 4" COMPACTED BASE COURSE OVER 12" OF STRUCTURAL FILL. REFER TO GEOTECHNICAL SPECIFICATIONS
- 18 NEW CONCRETE STAIRS WITH HANDRAILS AT 36" ON EA. SIDE. SEE DETAIL 2&4/C1
- (19) CLEAR SIGHT TRIANGLE PER CITY OF ABQ DEVELOPMENT PROCESS MANUAL, CHAPTER 23, SECT. 3, PART. D5 INTERSECTION SIGHT DISTANCE. NOTE* LANDSCAPING AND SIGNAGE WILL NOT INTERFERE WITH CLEAR SIGHT REQUIREMENTS. THEREFORE, SIGNS, WALLS, TREES AND SHRUBBERY BETWEEN 3 AND 8 FEET TALL (AS MEASURED FROM GUTTER PAN) WILL NOT BE ACCEPTABLE IN THIS AREA.
- ② EXISTING 6' PUBLIC SIDEWALK
- 20 EXISTING FIRE HYDRANT
- 21> 'MOTORCYCLE PARKING ONLY' SIGN
- ACCESSIBLE SIDEWALK RAMP AT NEW DRIVE PAD. REFER TO COA STANDARD DRAWING 2425

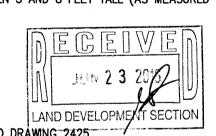



5-19-16 CLINTON J. WILSEY No.005139 66ARCHITECT, LLC Clint Wilsey, Architect clint.wilsey@gmail.com

5-19-16

PROJECT# AA 16_002

DRAWN BY: Clint Wilsey CHECK BY: Clint Wilsey

VERSION Q4-83x83 ALL REPORTS, PLANS, SPECIFICATION: FIELD DATA, NOTES AND OTHER DOCUMENTS, INCLUDING ALL
DOCUMENTS ON ELECTRONIC MEDIA,

PREPARED BY THE DESIGN
PROFESSIONAL AS INSTRUMENTS OF

OF THE DESIGN PROFESSIONAL

DISSEMINATION MAY NOT BE MADE WITHOUT PRIOR CONSENT OF THE

LAW RIGHTS OF COPYRIGHT AND THERWISE, ARE HEREBY SPECIFICALL RESERVED.

APPROVED

505 280-0043 TRAFFIC **CIRCULATION** LAYOUT