

3105

 $Q_{pA} = 1.87$

 $Q_{pB} = 2.60$

6211 10%

52792 | 85%

11498 SF

Weighted E =

Weighted E =

90% STORM "FIRST FLUSH" RETENTION:

 V_{rr} = AREA OF %D X 0.34"/12

 $V_{FF} = 52,792 \text{ SF } \times 0.34^{\circ}/12 = 1,496 \text{ CF}$

TOTAL PONDING PROVIDED = 1,520 CF > REQUIRED.

 $E_A = 0.66$

 $E_{\rm B} = 0.92$

 $E_{\rm C} = 1.29$

 $E_{\rm D} = 2.36$

 $A_A + A_B + A_C + A_D$

 $Q_{pC} = 3.45$

 $Q_{pD} = 5.02$

DESCRIPTION Discharges to Bell Ave

6.8 CFS

DESCRIPTION Discharges to Trumbull thru sdwk culvert

INV=72.5

LAND TREATMENT

C = 10%

LAND TREATMENT

5%

A = 0.0%

C = 10%

 $\mathbf{B} =$

0%

5%

Weighted E = $E_A A_A + E_B A_B + E_C A_C + E_D A_D$

1.56 in. Developed E = 2.18 in.

8061 CF Developed V = 11288 CF

5.5 CFS | Developed Q = 1.5

Sub-basin Weighted Excess Precipitation (see formula above)

Sub-basin Weighted Excess Precipitation (see formula above)

Sub-basin Volume of Runoff (see formula above)

ub-basin Peak Discharge Rate: (see formula above)

ub-basin Volume of Runoff (see formula above)

Sub-basin Peak Discharge Rate: (see formula above)

EXISTING CONDITIONS: THE EXISTING SITE WAS FORMERLY A SCHOOL BUS YARD. THERE IS SOME CONCRETE REMAINING FROM OLD BUILDING FOUNDATIONS. THE SITE SLOPES FROM THE SOUTHEAST TO THE NORTHWEST AT APPROXIMATELY 1.5%.
ONSITE STORM WATER OF 5.5 CFS DISCHARGES TO BELL AVE
OVER THE SIDEWALK. THE ADJACENT HALF OF EUBANK BLVD
DRAINS ONTO THE PROPERTY.

BUILDING (SOUTH). CURB IS ADDED ALONG THE ADJOINING EDGE OF EUBANK, WHICH WILL REDIRECT OFFSITE FLOW TO THE NORTH. THE SITE DISCHARGES 5.5 CFS TO BELL AVE FROM THE NORTHWEST DRIVEPAD AND 1.3 CSF TO TRUMBULL AVE FROM A 2' WIDE SIDEWALK CULVERT.

LEGEND

EXISTING CONTOUR PROPOSED CONTOUR PROPOSED SPOT ELEVATION FLOW ARROW FF = 6881.0FINISH FLOOR ELEVATION TW=99.0 BW=95.0 GROUND AT TOP OF RETAINING WALL ELEVATION GROUND AT BASE OF RETAINING WALL

INVERT ELEVATION

- SITE DI AINAGE ALBUQI

AZA & DR, K SE,

INNOVA PLAZ GRADING & I 401 EUBANK S

REVISION DATE

NOV 1 4 2014 LAND DEVELOPMENT SECTION

NOVEMBER 13, 2014

Nov 13,2014

SHEET NUMBER

CG-101

ISAACSON & ARFMAN, P.A. Consulting Engineering Associates

128 Monroe Street N.E. Albuquerque, New Mexico 87108 Ph. 505-268-8828 www.iacivil.com

2055 CG-101.dwg

2. THE CONTRACTOR SHALL ABIDE BY ALL STATE, LOCAL, AND FEDERAL LAWS, CODES, RULES AND REGULATIONS WHICH APPLY TO THE CONSTRUCTION OF THESE IMPROVEMENTS. INCLUDING EPA AND ADA REQUIREMENTS.

- 3. ALL SUBGRADE, OVEREXCAVATION, BACKFILL, AND FILL SHALL BE PLACED AND / OR COMPACTED PER THE GEOTECHNICAL REPORT AND CITY OF ALBUQUERQUE SPECIFICATIONS.
- 4. THE CONTRACTOR SHALL OBTAIN ALL REQUIRED PERMITS FOR THE PROJECT PRIOR TO COMMENCING CONSTRUCTION. OR PRIOR TO OCCUPANCY, AS APPROPRIATE, IF PERMITS ARE DELAYED OR ISSUED WITH CONDITIONS, THE CONTRACTOR SHALL NOTIFY THE OWNER AND ARCHITECT IMMEDIATELY.
- 5. COORDINATE WORK WITH SITE PLAN, UTILITY PLAN, DEMOLITION PLAN, AND LANDSCAPE PLAN.
- 6. IT IS THE CONTRACTOR'S RESPONSIBILITY TO FIELD VERIFY HORIZONTAL AND VERTICAL LOCATIONS OF ALL EXISTING OBSTRUCTIONS. AND CONDITION OF ALL EXISTING INFRASTRUCTURE PRIOR TO CONSTRUCTION. REPORT ALL DISCREPANCIES TO THE ARCHITECT / ENGINEER AND VERIFY THE ARCHITECT / ENGINEER'S INTENT BEFORE PROCEEDING.
- 7. THE CONTRACTOR SHALL BE SOLELY RESPONSIBLE FOR SITE SAFETY.
- 8. THE CONTRACTOR SHALL MAINTAIN RECORD DRAWINGS ON SITE AT ALL TIMES. THE CONTRACTOR SHALL NOT SCALE DRAWINGS. ONLY WRITTEN DIMENSIONS OR KEYED NOTES SHALL BE USED.
- 9. CONTRACTOR SHALL OBTAIN ALL REQUIRED INSPECTIONS OF THE WORK. CONTRACTOR SHALL REGULARLY UPDATE OWNER AND ARCHITECT REGARDING THE STATUS OF THE
- 10. CONSTRUCTION ACTIVITY SHALL BE LIMITED TO THE PROPERTY AND/OR PROJECT LIMITS. ANY DAMAGE TO ADJACENT STRUCTURES RESULTING FROM THE CONSTRUCTION PROCESS SHALL BE REPAIRED OR REPLACED. AT THE CONTRACTOR'S EXPENSE. CONTRACTOR SHALL BE RESPONSIBLE FOR DOCUMENTING EXISTING CONDITIONS PRIOR TO CONSTRUCTION.
- 11. CONSTRUCTION EQUIPMENT SHALL NOT OBSTRUCT DRIVEWAYS. EQUIPMENT SHALL ONLY OBSTRUCT DESIGNATED TRAFFIC LANES IF APPROPRIATE BARRICADING PERMITS HAVE BEEN OBTAINED. THE CONTRACTOR SHALL NOT STORE ANY EQUIPMENT OR MATERIAL IN THE RIGHT-OF-WAY.
- 12. THE CONTRACTOR SHALL PROVIDE A CONSTRUCTION TRAFFIC CONTROL AND SIGNING PLAN THAT CONFORMS TO THE LATEST EDITION OF THE "MANUAL OF UNIFORM TRAFFIC CONTROL DEVICES" (MUTCD) AND LOCAL REQUIREMENTS. THE CONTRACTOR SHALL OBTAIN BARRICADING PERMITS FROM THE APPROPRIATE AUTHORITIES PRIOR TO ANY

CONSTRUCTION WORK ON OR ADJACENT TO EXISTING


STREETS.

- 13. THE CONTRACTOR SHALL MAINTAIN ALL BARRICADING AND CONSTRUCTION SIGNING AT ALL TIMES. THE CONTRACTOR SHALL VERIFY THE PROPER LOCATION OF ALL BARRICADING AT THE END AND BEGINNING OF EACH DAY.
- 14. EXISTING UTILITY LINES ARE SHOWN IN AN APPROXIMATE MANNER ONLY AND MAY BE INCOMPLETE OR OBSOLETE. SUCH LINES MAY OR MAY NOT EXIST WHERE SHOWN OR NOT SHOWN. CONTRACTOR SHALL CONTACT NM-811 FOR UTILITY LINE SPOTS TWO WORKING DAYS PRIOR TO CONDUCTING SITE FIELD WORK. CONTRACTOR SHALL FIELD VERIFY AND LOCATE ALL UTILITIES PRIOR TO COMMENCEMENT OF ANY CONSTRUCTION. CONTRACTOR IS FULLY RESPONSIBLE FOR ANY AND ALL DAMAGE CAUSED BY ITS FAILURE TO LOCATE, IDENTIFY AND PRESERVE ANY AND ALL EXISTING UTILITIES, PIPELINES, AND UNDERGROUND UTILITY LINES. THE CONTRACTOR SHALL BE RESPONSIBLE FOR COORDINATION OF NECESSARY DRY UTILITY ADJUSTMENTS.
- 15. SOIL TESTING AND INSPECTION SERVICES DURING EARTHWORK OPERATIONS ARE REQUIRED. CONTRACTOR SHALL ALLOW TESTING LABS TO INSPECT AND APPROVE COMPACTED SUBGRADES, BACKFILL, AND FILL LAYERS BEFORE FURTHER CONSTRUCTION WORK IS DONE. SHOULD COMPACTION TESTS INDICATE INADEQUATE DENSITY. CONTRACTOR SHALL PROVIDE ADDITIONAL COMPACTION AND TESTING AT THE CONTRACTOR'S SOLE EXPENSE.
- 16. CONTRACTOR SHALL PROVIDE ALL OTHER CONSTRUCTION STAKING. CONTRACTOR SHALL LOCATE AND PRESERVE ALL BOUNDARY CORNERS AND REPLACE ANY LOST OR DISTURBED CORNERS AT CONTRACTOR'S SOLE EXPENSE. PROPERTY CORNERS SHALL ONLY BE RESET BY A REGISTERED LAND SURVEYOR.
- 17. CONTRACTOR SHALL COMPLY WITH LOCAL REGULATIONS FOR RESEEDING OF DISTURBED AREAS.
- 18. A CURRENT STORMWATER CONTROL PERMIT, INCLUDING AN EROSION SEDIMENT CONTROL PLAN (E.S.C.)FOR EROSION AND SEDIMENT CONTROL IS REQUIRED FOR ALL CONSTRUCTION, DEMOLITION CLEARING, AND GRADING OPERATIONS THAT DISTURB THE SOIL ON ONE ACRE OR MORE OF LAND. OWNER WILL COORDINATE.
- 19. POST-CONSTRUCTION MAINTENANCE FOR PRIVATE STORMWATER FACILITIES WILL BE THE RESPONSIBLITY OF THE FACILITIES OWNER. PERIODIC INSPECTION AND CERTIFICATIONS OF THE FACILITIES MAY BE REQUIRED BY THE CITY ENGINEER.
- 20. ALL SITE PREPARATION, GRADING OPERATIONS, FOUNDATION CONSTRUCTION, AND PAVEMENT INSTALLATION WORK SHALL BE CONSTRUCTED IN ACCORDANCE WITH THE GEOTECHNICAL REPORT, WHICH WILL BE PROVIDED BY THE OWNER OR ARCHITECT. ALL OTHER WORK SHALL, UNLESS OTHERWISE NOTED IN THE PLANS, BE CONSTRUCTED IN ACCORDANCE WITH THE PROJECT SPECIFICATION (FIRST PRIORITY), AND/OR NMDOT STANDARD SPECIFICATIONS FOR PUBLIC WORK (SECOND PRIORITY.)

GRADING GENERAL NOTES

- 1. PAVEMENT GRADES IN MARKED HANDICAPPED PARKING AREAS SHALL NOT EXCEED 2.0% IN ANY DIRECTION. FOR ALL ACCESSIBLE ROUTES, MAXIMUM ALLOWABLE CROSS SLOPE IS 2.0% AND MAXIMUM LONGITUDINAL SLOPE WITHOUT RAMP IS 5.0% FOLLOW ALL ADA ACCESSIBILITY GUIDELINES OR CITY CODES, WHICHEVER IS MORE STRINGENT.
- 2. ALL TRASH, DEBRIS, & SURFACE VEGETATION SHALL BE CLEARED AND LEGALLY DISPOSED OF OFFSITE.
- 3. PROPOSED SPOT AND CONTOUR ELEVATIONS SHOWN REPRESENT TOP OF FINISH MATERIAL (I.E. TOP OF CONCRETE, TOP OF CONCRETE BUILDING PAD, TOP OF PAVEMENT MATERIAL, TOP OF LANDSCAPING MATERIAL, ETC.). CONTRACTOR SHALL GRADE, COMPACT SUBGRADE AND DETERMINE EARTHWORK ESTIMATES BASED ON ELEVATIONS SHOWN MINUS FINISH MATERIAL THICKNESSES.
- 4. IF FIELD GRADE ADJUSTMENTS ARE REQUIRED, THE CONTRACTOR SHALL NOTIFY THE ARCHITECT/ENGINEER.
- 5. MINIMUM SLOPES SHALL BE 1% UNLESS OTHERWISE NOTED.
- 6. STORMWATER CONTROL MEASURES SHOWN ON THIS PLAN ARE REQUIRED TO PROVIDE MANAGEMENT OF 'FIRST FLUSH' (DEFINED AS THE 90TH PERCENTILE STORM EVENT OR 0.44" OF STORMWATER WHICH DISCHARGES DIRECTLY TO A PUBLIC STORM DRAINAGE SYSTEM).
- MEASURES REQUIRED FOR EROSION AND SEDIMENT CONTROL SHALL BE INCIDENTAL TO THE PROJECT COST.
- 8. ADJUST ANY RIMS OF EXISTING UTILITY FEATURES AS NECESSARY TO MATCH NEW GRADES, UTILITIES IN PAVED AREAS SHALL BE HS-25 TRAFFIC RATED.
- 9. ALL NEW PAVEMENT SURFACES SHALL BE CONSTRUCTED WITH POSITIVE SLOPE AWAY FROM BUILDINGS AND POSITIVE SLOPE TOWARD EXISTING AND/OR PROPOSED DRAINAGE PATHS. PAVING AND ROADWAY GRADES SHALL BE ±0.1' FROM PLAN ELEVATIONS. BUILDING PAD ELEVATION SHALL BE ±0.05' FROM PLAN ELEVATION.
- 10. WHERE GRADES BETWEEN NEW AND EXISTING ARE SHOWN AS 'MATCH' OR '±', TRANSITIONS SHALL BE SMOOTH.
- 11. ALL FRACTURED FACE ROCK (F.F. ROCK) TO BE 6" AVG. DIA. ANGULAR FACED ROCK PLACED OVÉR GEOTEX 501 NON-WOVEN GEOTEXTILE (O.E.). NOTE: PERMANENT TURF REINFORCEMENT MATERIAL (LANDLOK TRM 450 O.E.) MAY BE SUBSTITUTED AT ALL AREAS REFERENCING F.F. ROCK EROSION PROTECTION.
- 12. ENGINEER RECOMMENDS THAT OWNER MAINTAIN EROSION PROTECTION ELEMENTS. ENGINEER RECOMMENDS THAT OWNER INSPECT SITE YEARLY AND AFTER EACH RAINFALL TO IDENTIFY NEW AREAS OF EROSION AND INSTALL ADDITIONAL EROSION PROTECTION AS NEEDED BASED ON ACTUAL OCCURRENCES.
- 13. GRADING SHALL BE PERFORMED AT THE ELEVATIONS AND IN ACCORDANCE WITH THE DETAILS SHOWN ON THIS PLAN.


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GENERAL NOTES

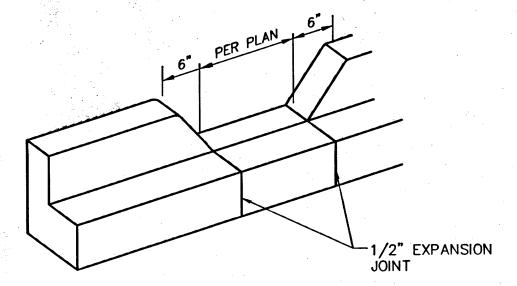1. EDGES NOT SPECIFICALLY DIMENSIONED SHALL BE SHAPED WITH A 3/8" EDGING TOOL.






GENERAL NOTES

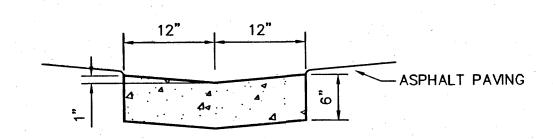- 1. EDGES SHALL BE SHAPED WITH A 3/8" EDGING TOOL.
- 2. CONSTRUCTION CONTROL JOINTS AT 6' O.C. MAX. 3. 1/2" EXPANSION JOINTS 48' O.C., CURB RETURNS AND EACH
- SIDE OF DRIVES. SEAL WITH _____ 4. EDGE OF ASPHALT PAVING TO BE 3" ABOVE EDGE OF CONCRETE (TYP).

CONCRETE ALLEY GUTTER

SCALE: N.T.S.

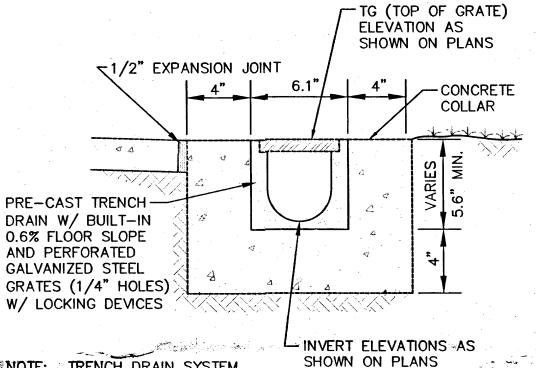

NOTE: TRENCH DRAIN SYSTEM BY ACO POLYMER PRODUCTS,

TRENCH DRAIN THROUGH SIDEWALK

SCALE: N.T.S.

%" TOOLED GROOVE-BETWEEN PIPES 8" O.C.

PIPES THROUGH WALK SCALE: N.T.S.

REVISION DATE

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ISAACSON & ARFMAN, P.A. Consulting Engineering Associates 128 Monroe Street N.E.

Albuquerque, New Mexico 87108 Ph. 505-268-8828 www.iacivil.com


Aug 26,2014


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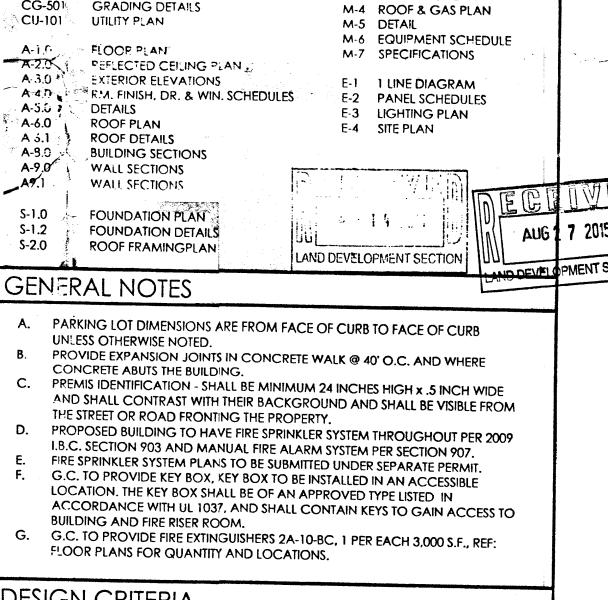
NOVEMBER 13, 2014


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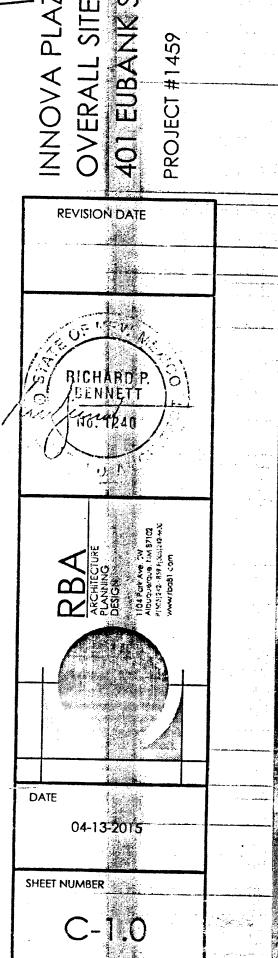
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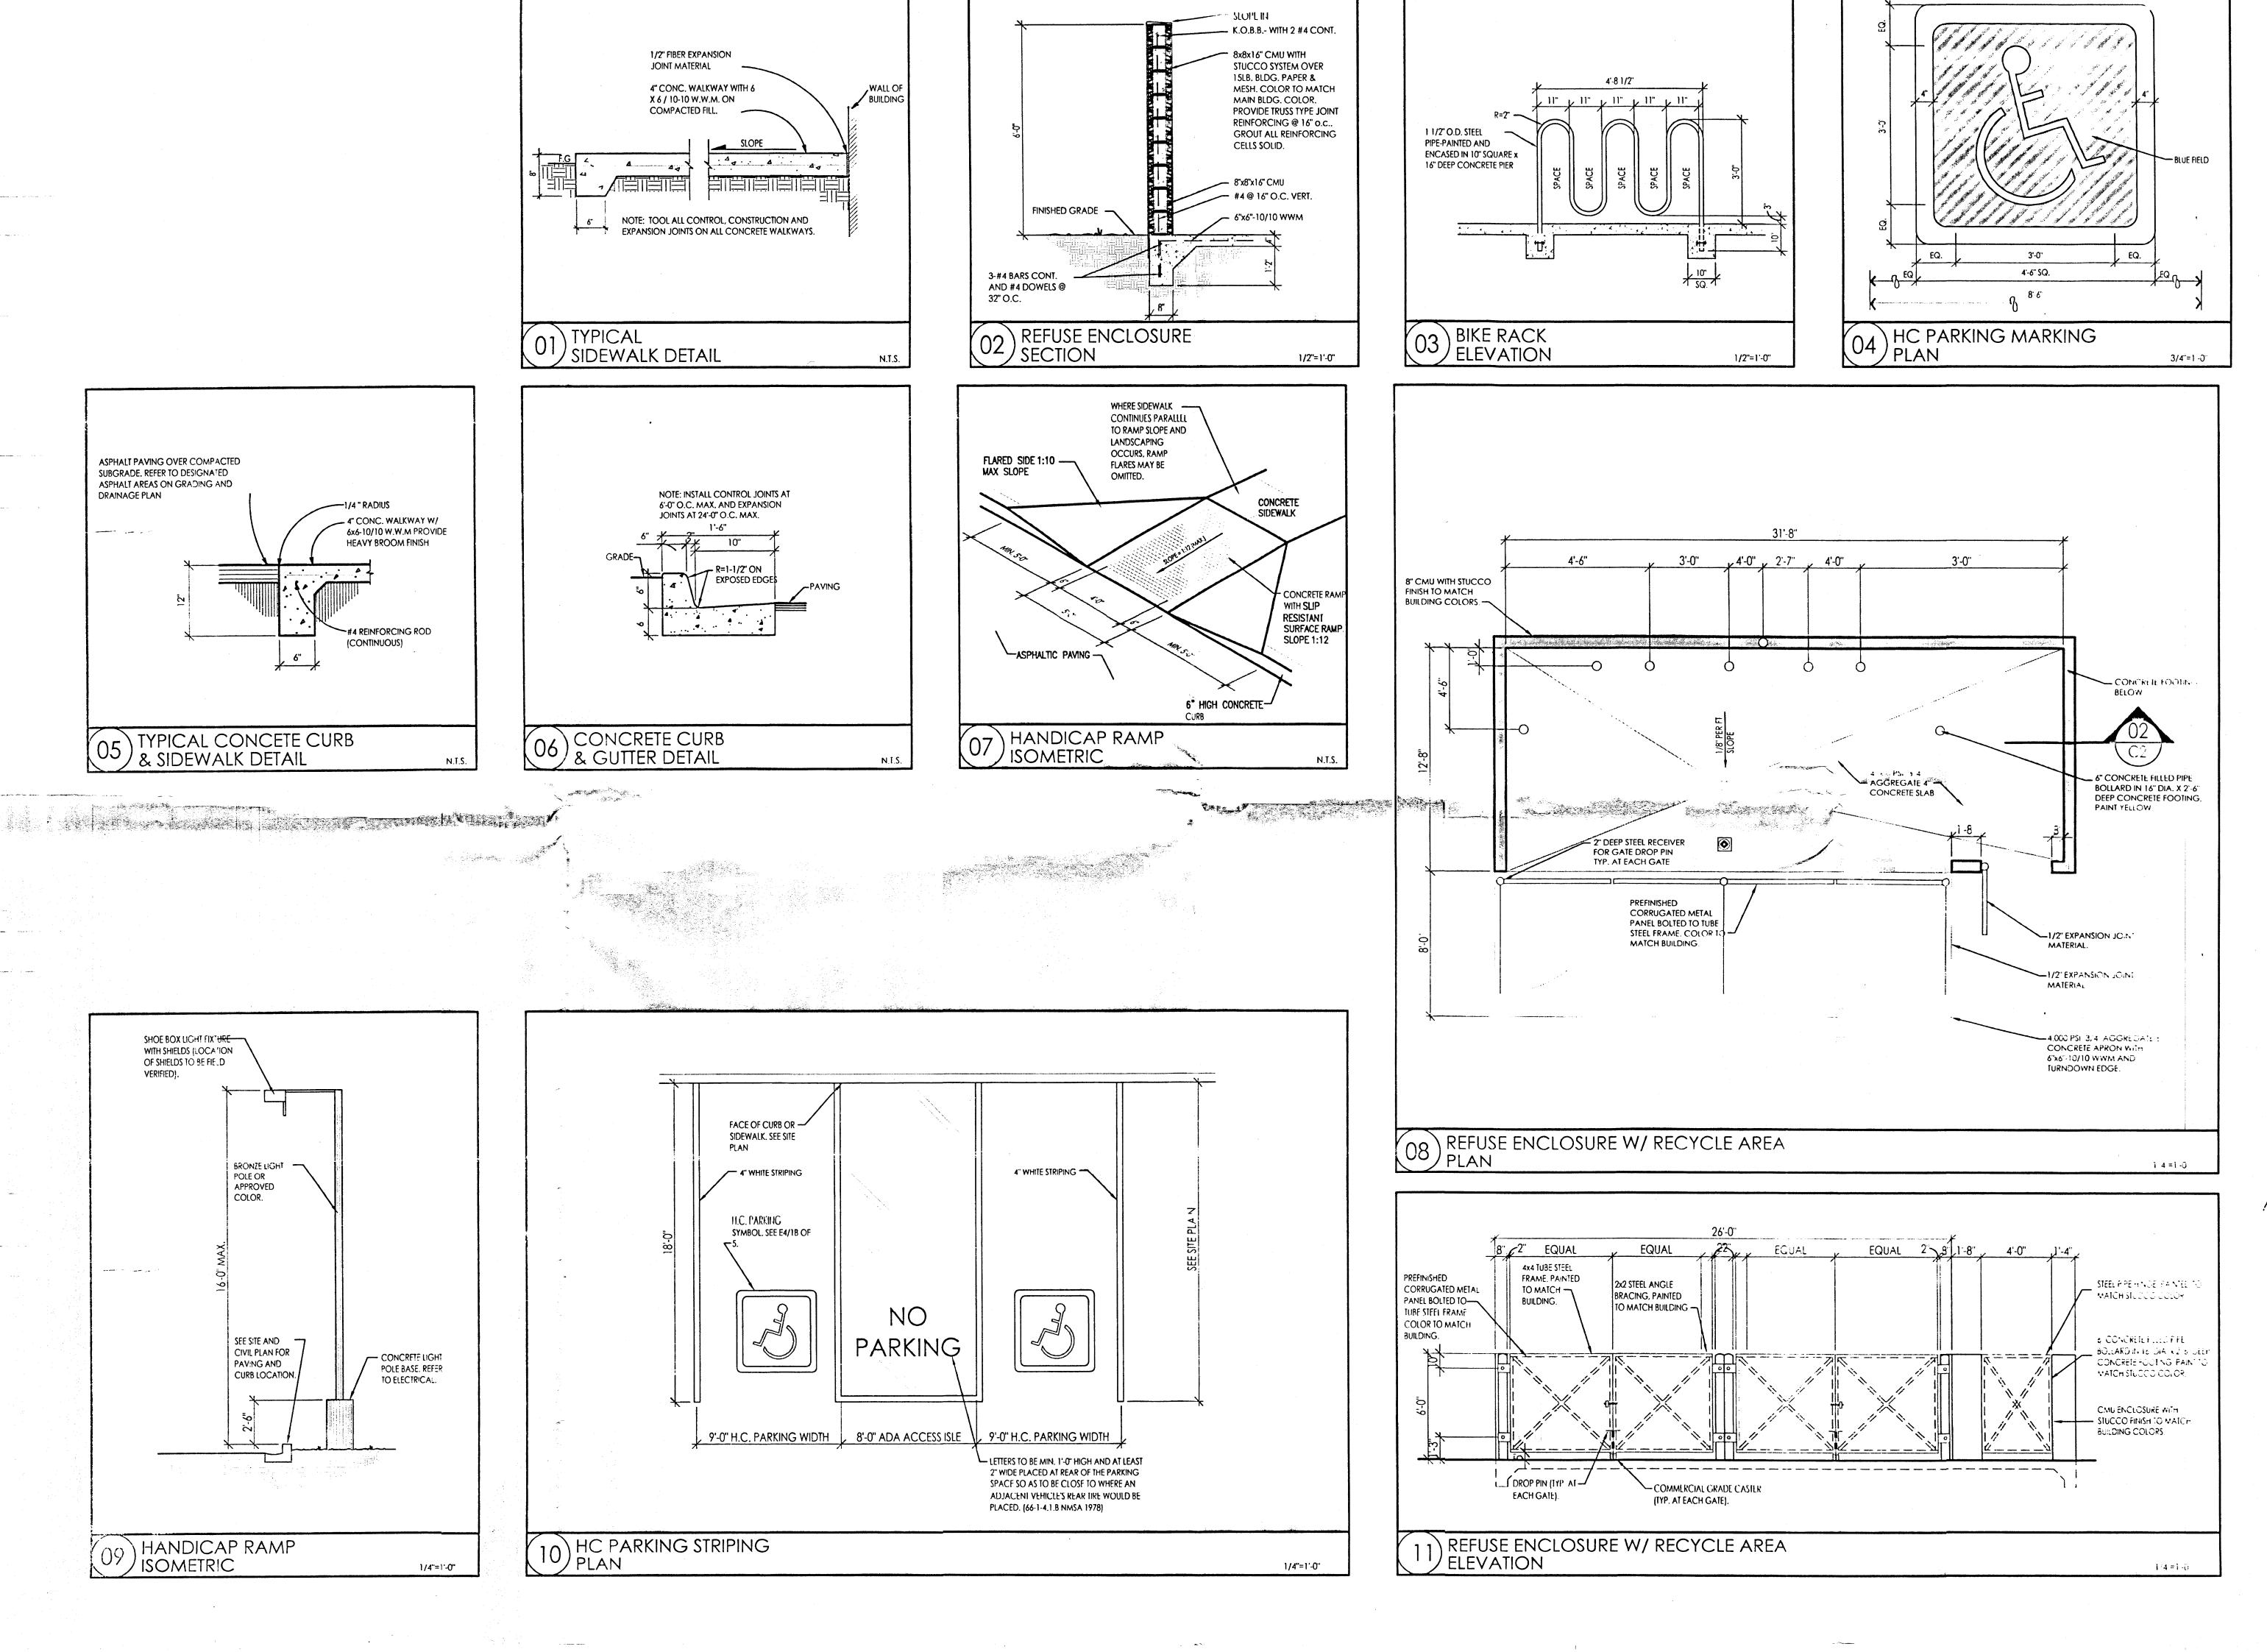






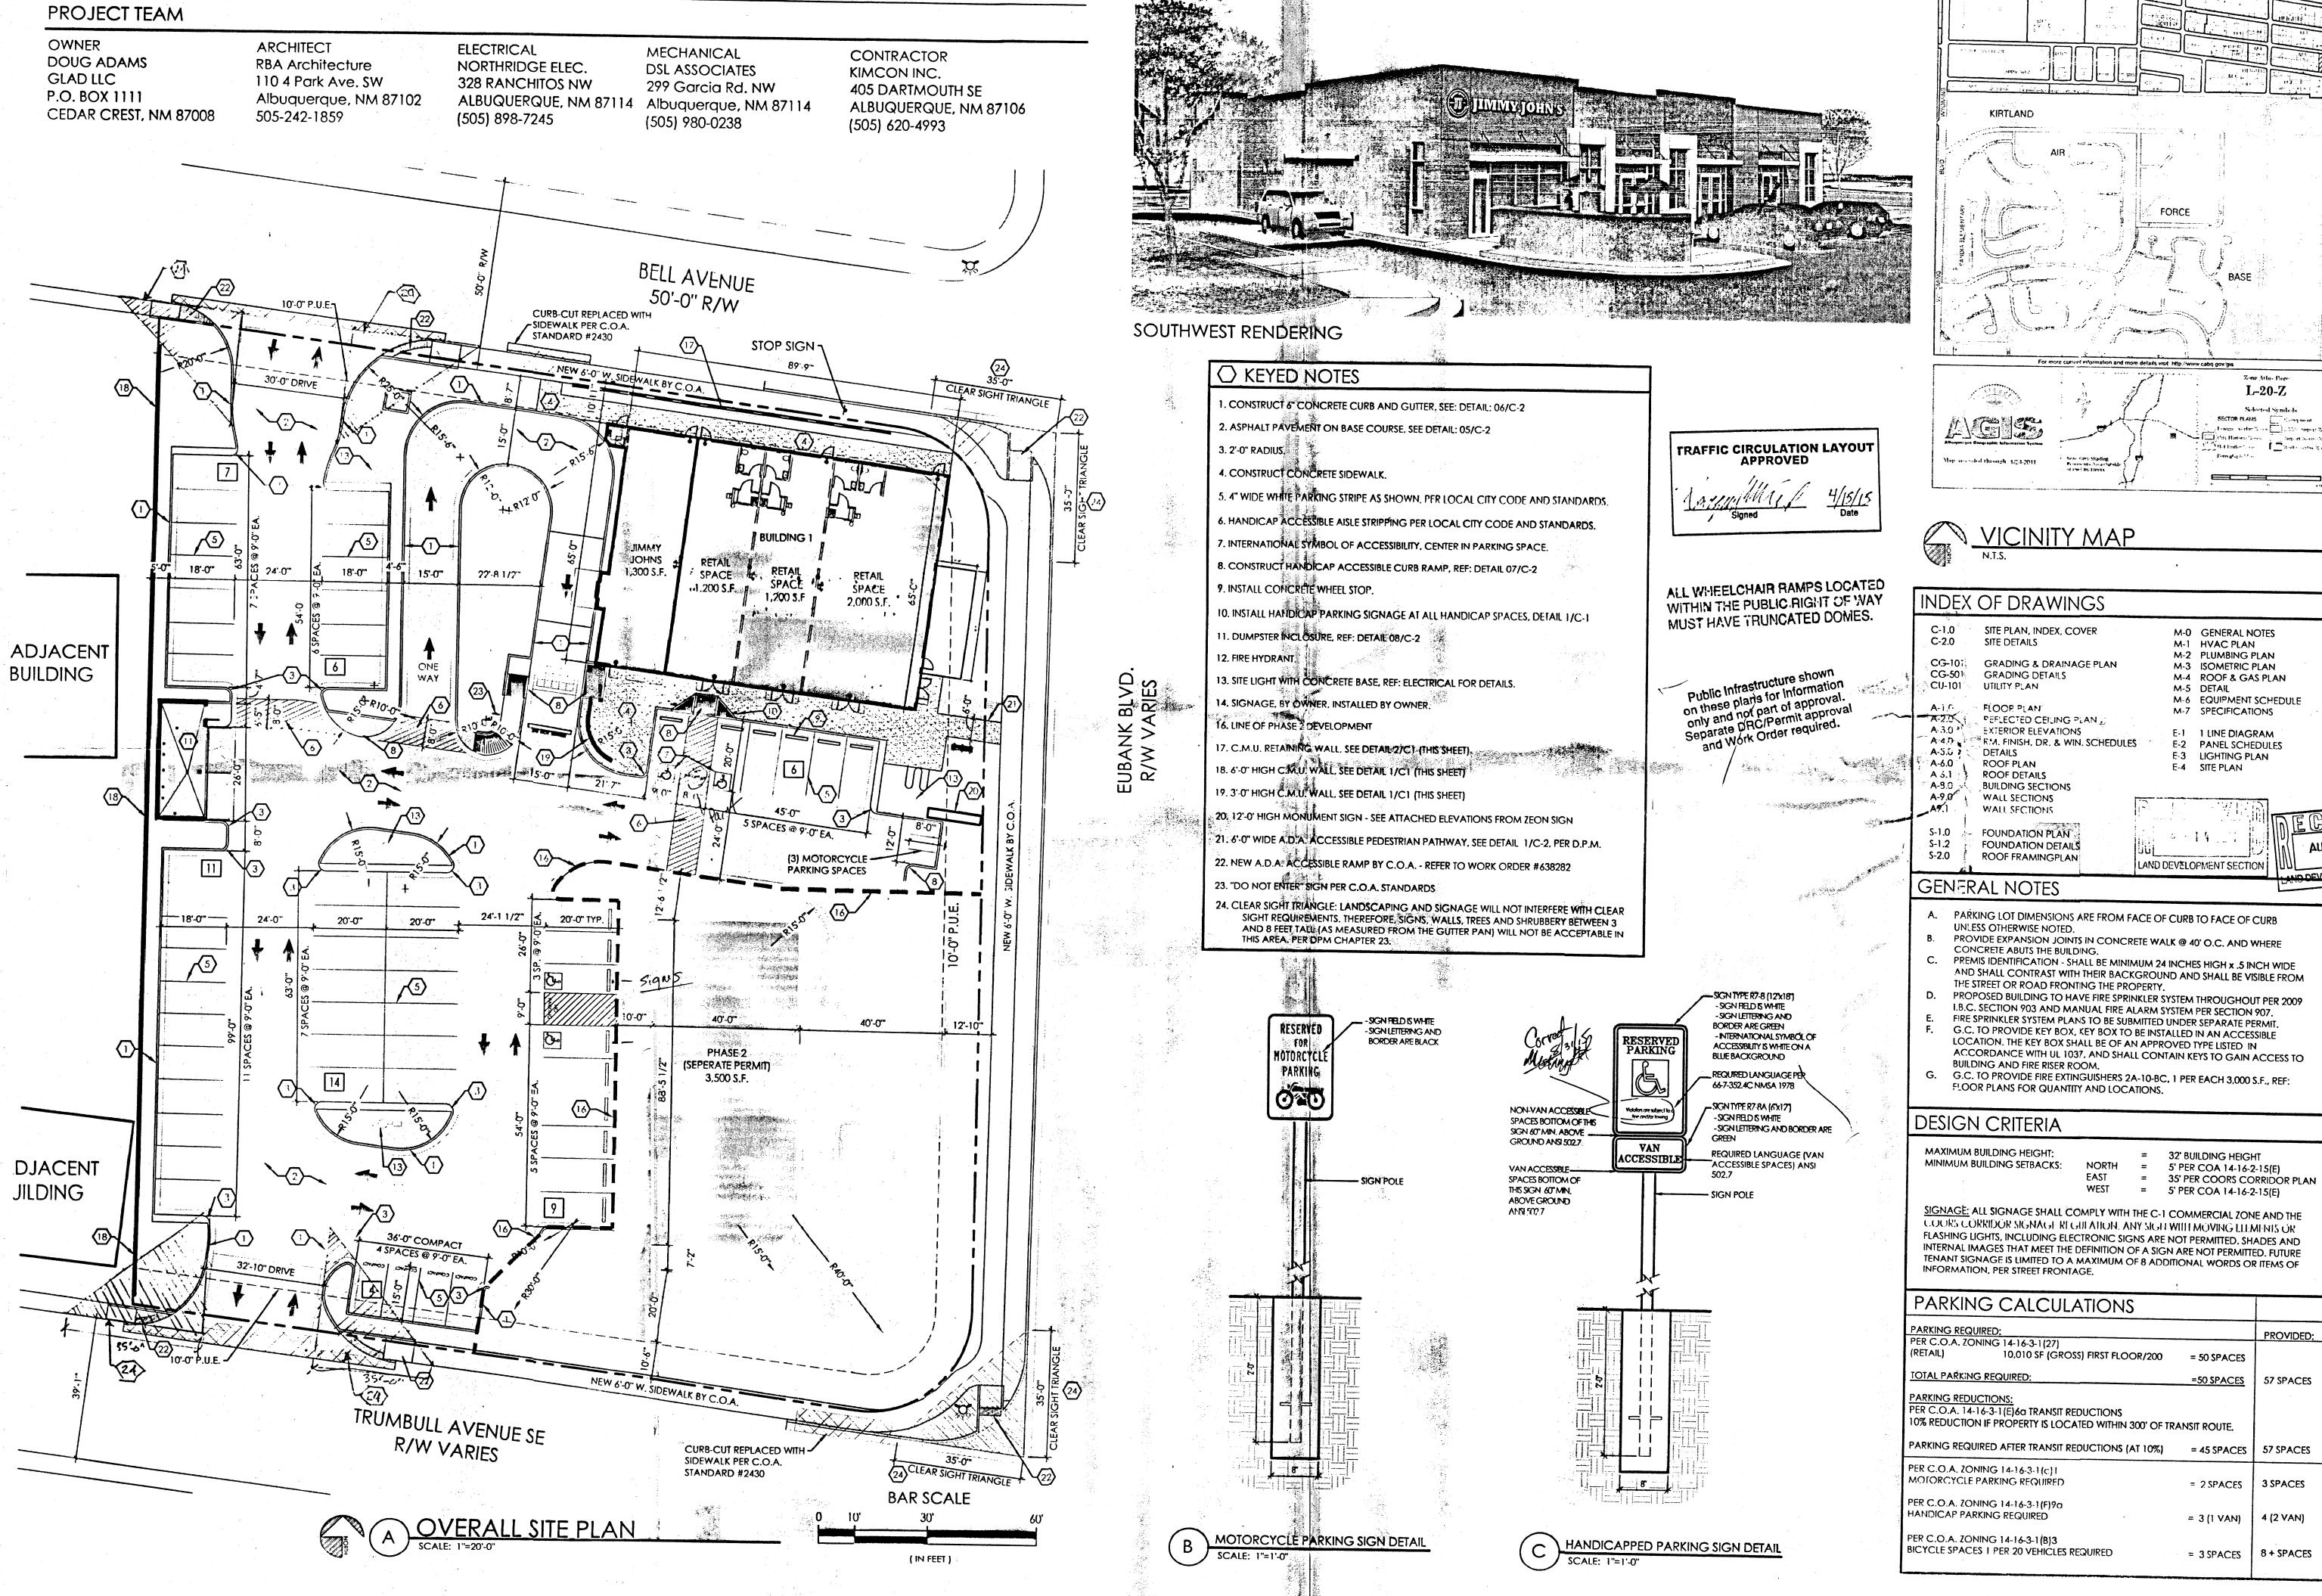

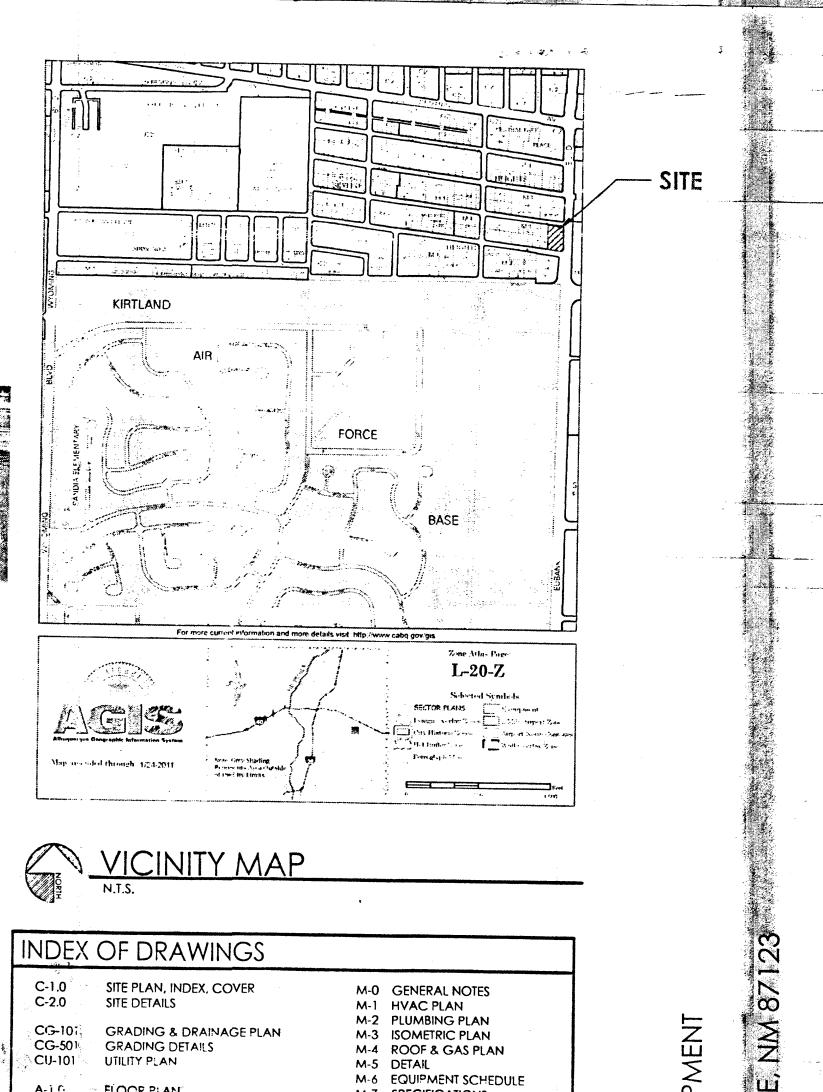

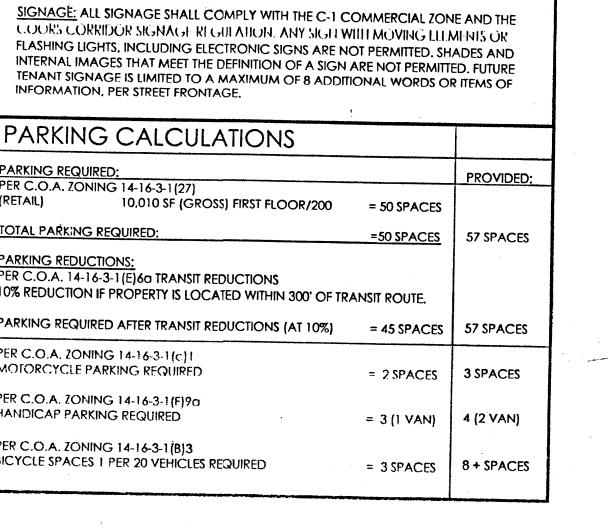

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REVISION DATE

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04-13-2015

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Vicinity Map Zone Atlas L-20-Z

1. FIELD SURVEY PERFORMED IN SEPTEMBER 2013. ALL DISTANCES ARE GROUND DISTANCES: U.S. SURVEY FOOT. THE BASIS OF BEARINGS REFERENCES RECORD ROTATED TO NEW MEXICO STATE PLANE COORDINATES (NAD83-GRID).

4. LOT LINES BEING ELIMÎNATED BY PLAT ARE SHOWN AS THUS.........

Free Consent

THE SUBDIVISION HEREON DESCRIBED IS WITH THE FREE CONSENT AND AND IN ACCORDANCE WITH THE DESIRES OF THE UNDERSIGNED OWNER(S) AND/OR PROPRIETOR(S) THEREOF AND GRANT ALL UTILITY EASEMENTS SHOWN HEREON INCLUDING THE RIGHT TO CONSTRUCT, OPERATE, INSPECT, MAINTAIN FACILITIES THEREIN; AND ALL PUBLIC UTILITIES EASEMENTS SHOWN HEREON FOR THE COMMON AND JOINT USE OF GAS, ELECTRICAL POWER AND COMMUNICATION DERVICE FOR BURIED DISTRIBUTION LINES, CONDUCTS AND PIPES FOR UNDERGROUND UTILITIES WHERE SHOWN OR INDICATED, AND INCLUDING THE RIGHT OF INGRESS AND EGRESS FOR CONSTRUCTION AND MAINTENANCE, AND THE RIGHT TO TRIM INTERFERING TREES AND SHRUBS. SAID OWNER(S) AND/OR PROPRIETOR(S) DO HEREBY CONSENT TO ALL OF THE FOREGOING AND DO HEREBY CERTIFY THAT THIS SUBDIVISION IS THEIR FREE ACT AND DEED. SAID OWNER(S) WARRANT THAT THEY HOLD AMONG THEM COMPLETE AND INDEFEASIBLE TITLE IN FEE SIMPLE TO THE LAND

DOUGLÁS A. ADAMS, MANAGING MEMBER

Acknowledgment

STATE OF NEW MEXICO

THIS INSTRUMENT WAS ACKNOWLEDGED BEFORE ME ON _____ 2014 BY: GLAD, LLC, DOUGLAS A. ADAMS, MANAGING MEMBER

OFFICIAL SEAL

CHARLES CALDERON

Notary Public

State of New Mexico

MY COMMISSION EXPIRES NOTARY PUBLIC

Indexing Information

Section 29, Township 10 North, Range 4 East, N.M.P.I Subdivision: Skyline Heights Subdivision Owner: Doug Adams UPC #: Lot 1: 102005651239810718 Lol 2: 10200565193971071 Lot 6: 102005652338310713 Lot 7: 102005651938410712 Lot 8: 102005651238510711

Purpose of Plat

SUBDIVIDE AS SHOWN HEREON. GRANT EASEMENT AS SHOWN HEREON. 3. SHOW VACATED EASEMENTS.

Subdivision Data

RIGHT-OF-WAY DEDICATION TO THE CITY OF ALBUQUERQUE. . . . D.0000 ACRES DATE OF SURVEY. SEPTEMBER 2013

Legal

AND DESIGNATED ON THE PLAT OF BLOCKS 37 TO 52, INCLUSIVE, FILED IN THE OFFICE OF THE ONE-HALF OF GLORIETA STREET SE. LYING ADJACENT TO AND BEING APPURTENANT TO THE ABOVE DESCRIBED REAL ESTATE, VACATED BY COMMISSION ORDINANCE NO. 1231, ADOPTED JUNE 4. 1957. LESS AND EXCEPTING THEREFROM THAT PORTION DEEDED TO THE CITY OF ALBUQUERQUE BY THAT CERTAIN DOCUMENT RECORDED OCTOBER 2, 2013 AS DOCUMENT NUMBER 2013-109954 RECORDS OF BERNALILLO COUNTY, NEW MEXICO.

WITH A BATHEY MARKER WITH CAP "LS 14271", WHENCE A TIE TO ACS MONUMENT "4-L22"

THENCE, FROM THE POINT OF BEGINNING, 40.50 FEET ALONG A CURVE TO THE RIGHT, HAVING A RADIUS OF 28.00, A DELTA OF 82°52'51", A CHORD OF S 40°52'59" E, A DISTANCE OF 37.06 FEET, BEING A POINT ON THE WESTERLY RIGHT OF WAY OF EUBANK BOULEVARD SE, BEING MARKED BY BATHEY MARKER WITH CAP "IS 14271";

THENCE, COINCIDING SAID WESTERLY RIGHT OF WAY OF EUBANK BOULEVARD SE. S 00'33'26" W, A DISTANCE OF 227.45 FEET TO A POINT OF CURVATURE, BEING MARKED WITH A BATHEY MARKER WITH CAP "LS 14271".

THENCE, 27.13 FEET ALONG A CURVE TO THE RIGHT, HAVING A RADIUS OF 16.00, A DELTA OF 97'08'22", A CHORD OF S 49'07'37" W, A DISTANCE OF 23.99 FEET, BEING A POINT ON THE NORTHERLY RIGHT OF WAY OF TRUMBULL AVENUE SE. BEING MARKED WITH A BATHEY MARKER WITH CAP "LS 14271";

THENCE, COINCIDING WITH THE SAID NORTHERLY RIGHT OF WAY OF TRUMBULL AVENUE SE. N 821812" W, A DISTANCE OF 215.56 FEET, BEING MARKED WITH A 1/2 INCH REBAR WITH CAP

THENCE, LEAVING SAID NORTHERLY RIGHT OF WAY OF TRUMBULL SE, N 00°57'43" E. A DISTANCE OF 269.99 FEET, TO A POINT ON THE SOUTHERLY RIGHT OF WAY OF BELL AVENUE SE, BEING MARKED BY A 1/2 INCH REBAR;

THENCE, S 82'19'25" E, A DISTANCE OF 207.04 FEET, TO THE POINT OF BEGINNING, CONTAINING 1.4282 ACRES (62,211 SQ. FT.) MORE OR LESS.

Solar Collection Note

PER SECTION 14-14-4-7 OF THE SUBDIVISION ORDINANCE:

NO PROPERTY WITHIN THE AREA OF REQUESTED FINAL ACTION SHALL AT ANY TIME BE SUBJECT TO A DEED RESTRICTION, COVENANT, OR BUILDING AGREEMENT PROHIBITING SOLAR COLLECTORS FROM BEING INSTALLED ON BUILDINGS OR ERECTED ON THE LOTS OR PARCELS WITHIN THE AREA OF PROPOSED PLAT, THE FOREGOING REQUIREMENT SHALL BE A CONDITION TO APPROVAL OF

Plat for

Lot 1-A, Block 48 Skyline Heights Subdivision Being Comprised of

Lots 1-3, 6-8 and Portions of Lots 4 & 5, Block 48 n and the E'ly 1/2 of Vacated Glorieta Street SE Section 29, Township 10 North, Range 4 East

New Mexico Principal Meridian City of Albuquerque Bernalillo County, New Mexico June 2014

Approved and Accepted by: APPROVAL AND CONDITIONAL ACCEPTANCE AS SPECIFIED BY THE ALBUQUERQUE SUBDIVISION ORDINANCE, CHAPTER 14 ARTICLE 14 OF THE REVISED ORDINANCES OF ALBUQUERQUE, NEW MEXICO, 1994

_1009920 Project Number Application Number 14-70223

Plat apprgvals: 7-16-14 7-16-14

Jomessi	Date
y approvals:	6-23-14
City Surveyor	Dote
Traffic Engineer	8-26-14 Date
Mu Peta,	08 20/14
ABCWUA	Date
Carel S. Dupront Parks and Recreation, Department	8-20-14 Date
Centra C. Crem	20-14
AMAFCA	Date
Cent. a. Cher	E-20-M
City Engineer	Date

Surveyor's Certificate

DRB/Chairperson, Planning Department


"I, DAVID J. THOMPSON, A DULY QUALIFIED REGISTERED PROFESSIONAL LAND SURVEYOR UNDER THE LAWS OF THE STATE OF NEW MEXICO, DO HEREBY CERTIFY THAT THIS PLAT AND DESCRIPTION WERE PREPARED BY ME OR UNDER MY SUPERVISION, SHOWS ALL EASEMENTS AS SHOWN ON THE PLAT OF RECORD OR MADE KNOWN TO ME BY THE OWNERS AND/OR PROPRIETORS OF THE SUBDIVISION SHOWN HEREON, THE UTILITY COMPANIES OR OTHER INTERESTED PARTIES AND MEETS THE MINIMUM REQUIREMENTS FOR MONUMENTATION AND SURVEYS OF THE ALBUQUERQUE SUBDIVISION ORDINANCE, AND FURTHER MEETS THE MINIMUM STANDARDS FOR LAND SURVEYING IN THE STATE OF NEW MEXICO AND IS TRUE AND CORRECT TO THE BEST OF MY KNOWLEDGE AND BELIEF."

N.M.R.P.S. No. 12657

P.O. BOX 44414 RIO RANCHO, N.M. 87174

Phone (505) 896-3050 Fax (505) 891-0244

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DATE

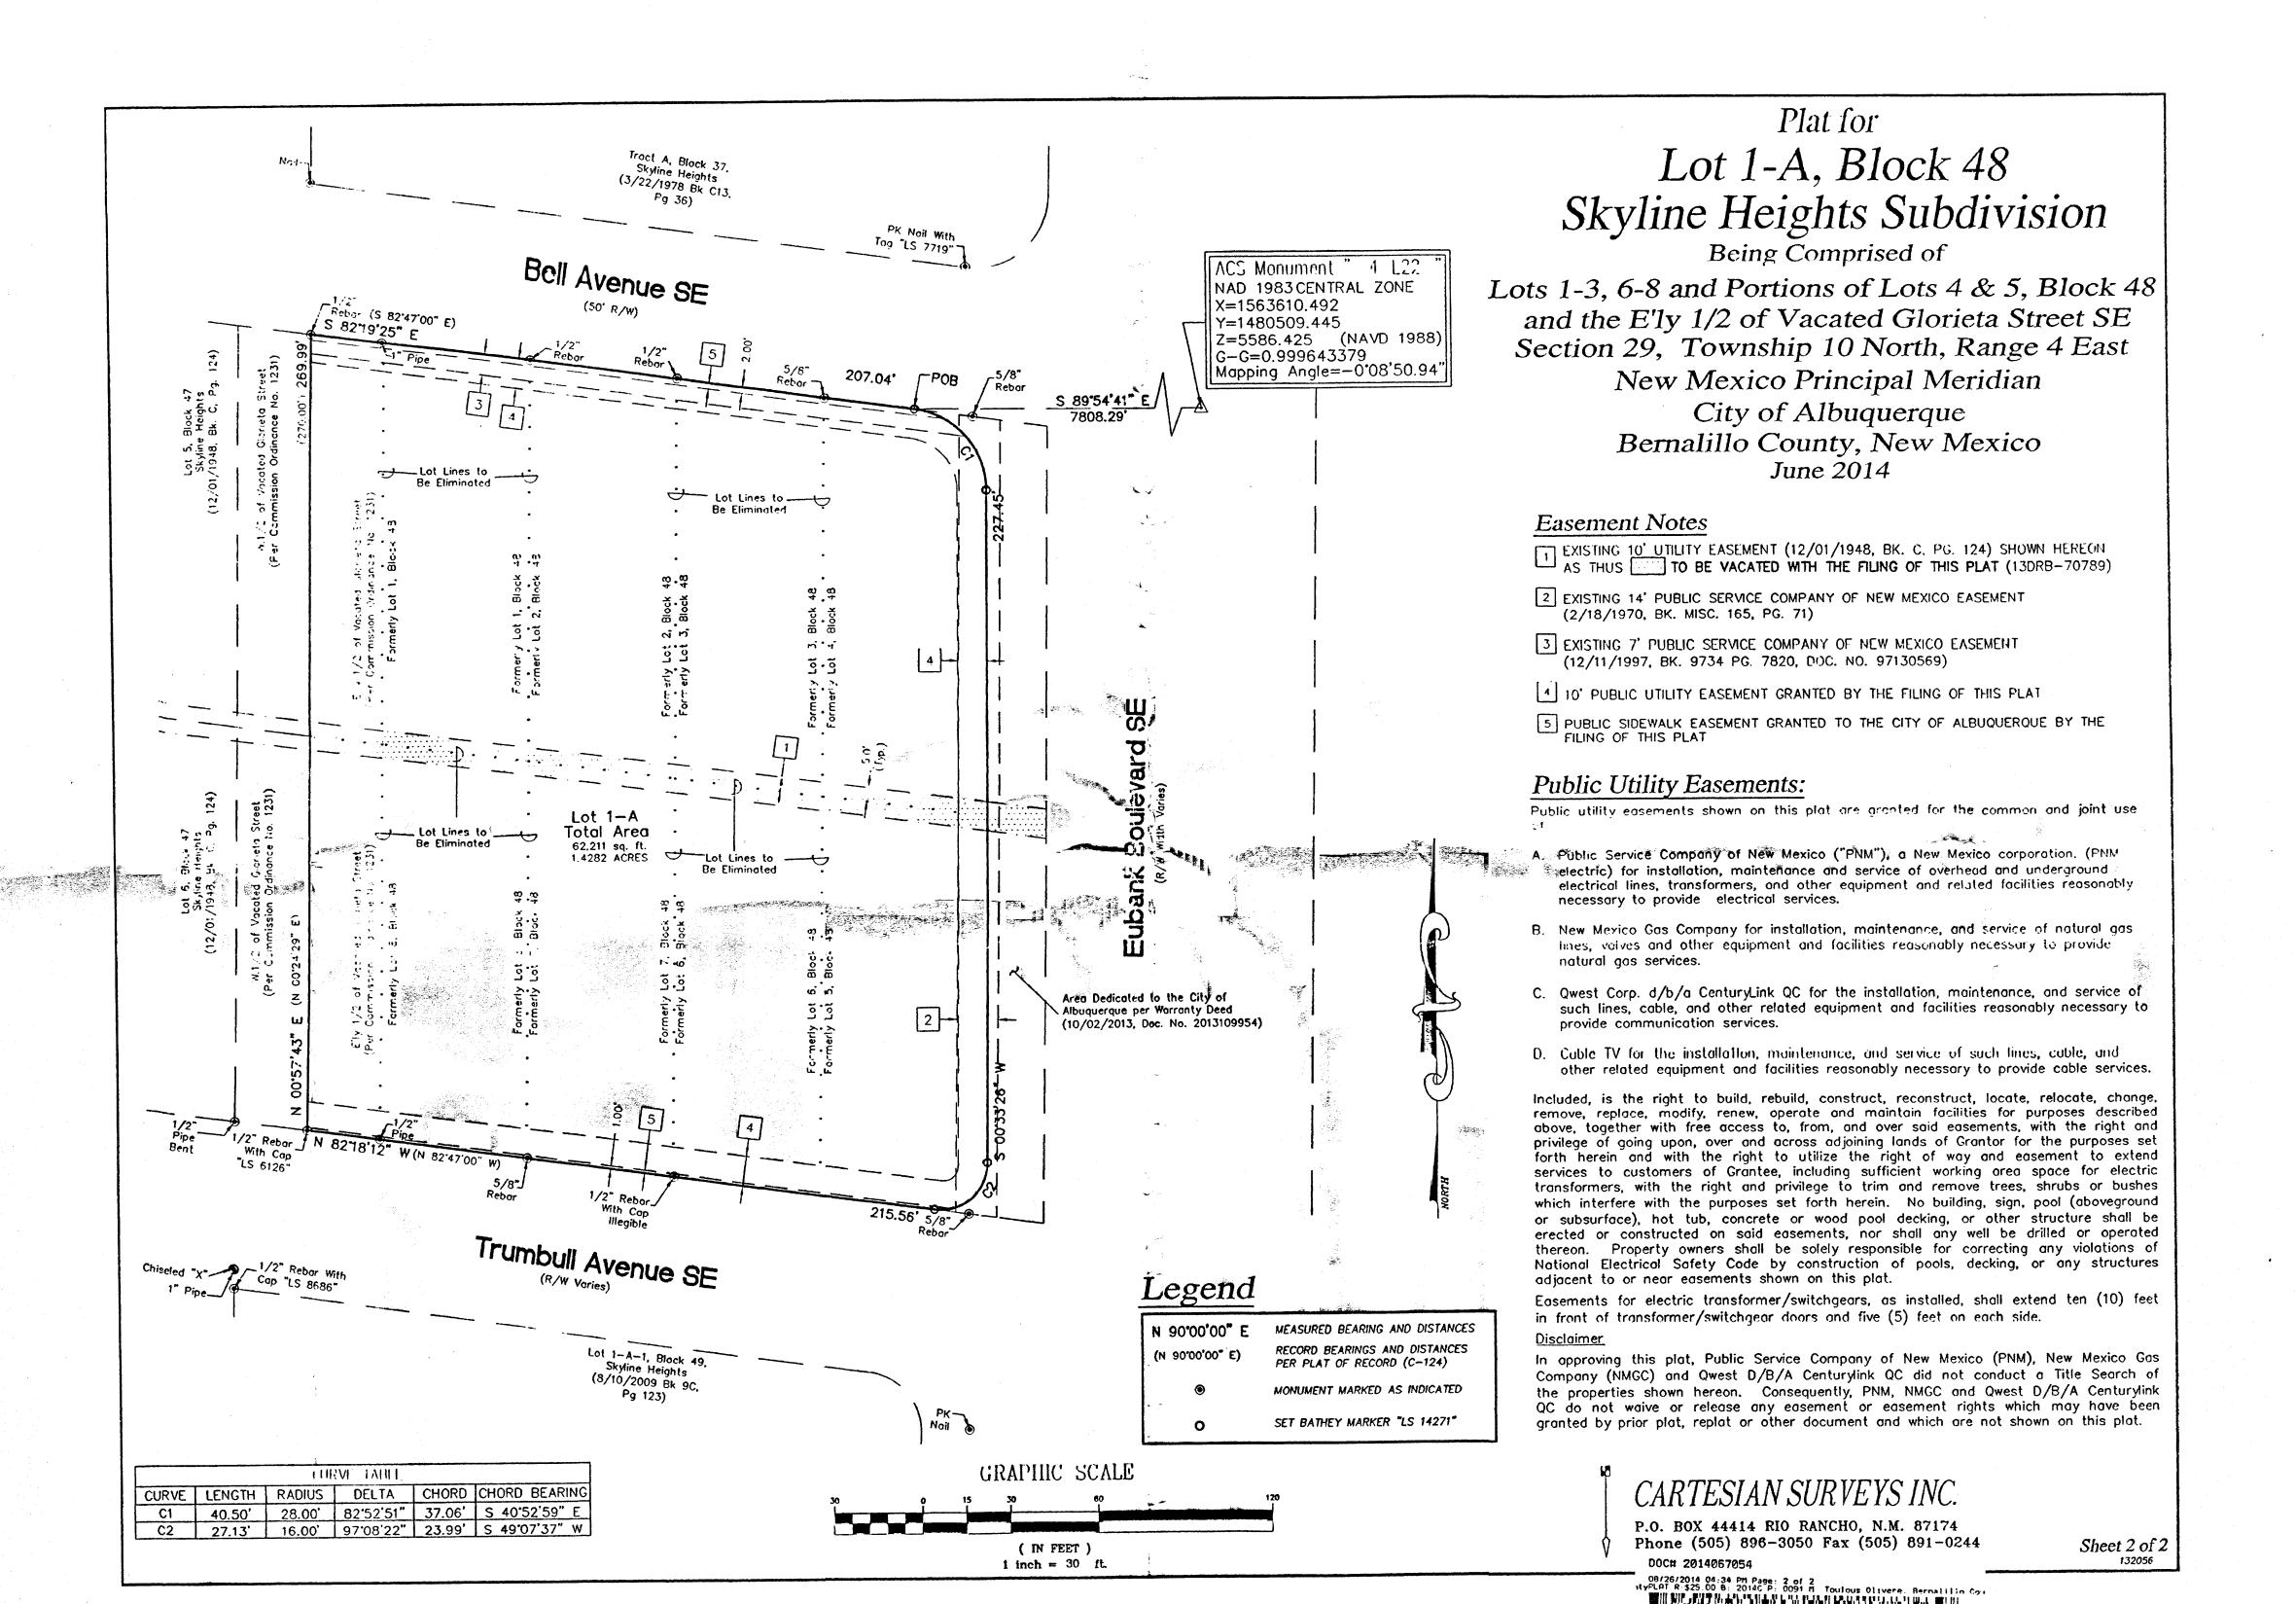SHEET NUMBER

04-13-2015

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Petroglyph Mon.

INNOVA PLAZA

PROJECT TEAM

OWNER DOUG ADAMS GLAD LLC P.O. BOX 1111 CEDAR CREST, NM 87008

ARCHITECT RBA Architecture 110 4 Park Ave. SW Albuquerque, NM 87102 505-242-1859

ELECTRICAL NORTHRIDGE ELEC. 328 RANCHITOS NW (505) 898-7245

MECHANICAL DSL ASSOCIATES 299 Garcia Rd. NW ALBUQUERQUE, NM 87114 Albuquerque, NM 87114 (505) 980-0238


BELL AVENUE 50'-0" R/W

STOP SIGN-

CURB-CUT REPLACED WITH

-SIDEWALK PER C.O.A. STANDARD #2430

CONTRACTOR KIMCON INC. 405 DARTMOUTH SE ALBUQUERQUE, NM 87106 (505) 620-4993

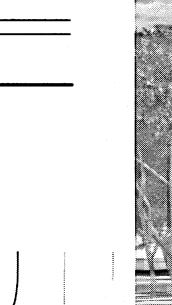



SOUTHWEST RENDERING

KEYED NOTES

1. CONSTRUCT 6" CONCRETE CURB AND GUTTER, SEE: DETAIL: 06/C-2

2. ASPHALT PAVEMENT ON BASE COURSE, SEE DETAIL: 05/C-2

3. 2'-0" RADIUS

4. CONSTRUCT CONCRETE SIDEWALK.

5. 4" WIDE WHITE PARKING STRIPE AS SHOWN, PER LOCAL CITY CODE AND STANDARDS.

9. INSTALL CONCRETE WHEEL STOP.

10. INSTALL HANDICAP PARKING SIGNAGE AT ALL HANDICAP SPACES, DETAIL 1/C-1

11. DUMPSTER INCLOSURE, REF: DETAIL 08/C-2

12. FIRE HYDRANT.

13. SITE LIGHT WITH CONCRETE BASE, REF: ELECTRICAL FOR DETAILS

14. SIGNAGE, BY OWNER, INSTALLED BY OWNER.

16. LINE OF PHASE 2 DEVELOPMENT

17. C.M.U. RETAINING WALL, SEE DETAIL 2/C1 (THIS SHEET)

18. 6'-0" HIGH C.M.U. WALL, SEE DETAIL 1/C1 (THIS SHEET)

19. 3'-0" HIGH C.M.U. WALL, SEE DETAIL 1/C1 (THIS SHEET)


20. 12'-0' HIGH MONUMENT SIGN - SEE ATTACHED ELEVATIONS FROM ZEON SIGN

21. 6'-0" WIDE A.D.A. ACCESSIBLE PEDESTRIAN PATHWAY, SEE DETAIL 1/C-2, PER D.P.M.


22. NEW A.D.A. ACCESSIBLE RAMP BY C.O.A. - REFER TO WORK ORDER #638282

23. "DO NOT ENTER" SIGN PER C.O.A. STANDARDS

24. CLEAR SIGHT TRIANGLE: LANDSCAPING AND SIGNAGE WILL NOT INTERFERE WITH CLEAR SIGHT REQUIREMENTS. THEREFORE, SIGNS, WALLS, TREES AND SHRUBBERY BETWEEN 3 AND 8 FEET TALL (AS MEASURED FROM THE GUTTER PAN) WILL NOT BE ACCEPTABLE IN THIS AREA. PER DPM CHAPTER 23.

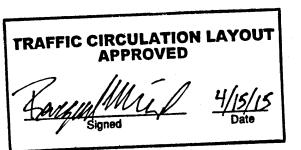

ALL WHEELCHAIR RAMPS LOCATED WITHIN THE PUBLIC RIGHT OF WAY MUST HAVE TRUNCATED DOMES.

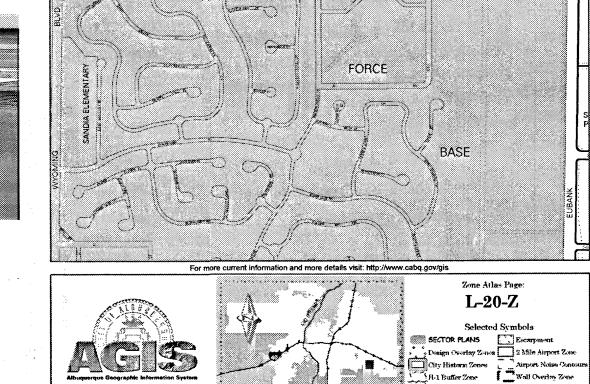



INDEX OF DRAWINGS SITE PLAN, INDEX, COVER M-0 GENERAL NOTES M-1 HVAC PLAN SITE DETAILS M-2 PLUMBING PLAN M-3 ISOMETRIC PLAN **GRADING & DRAINAGE PLAN GRADING DETAILS** M-4 ROOF & GAS PLAN CU-101 UTILITY PLAN M-5 DETAIL M-6 EQUIPMENT SCHEDULE M-7 SPECIFICATIONS REFLECTED CEILING PLAN *A-3.0 EXTERIOR ELEVATIONS E-1 1 LINE DIAGRAM E-3 LIGHTING PLAN **ROOF PLAN** E-4 SITE PLAN A 3.1 **ROOF DETAILS** BUILDING SECTIONS A-9.0 WALL SECTIONS WALL SECTIONS APR 1 4 2015 FOUNDATION PLAN FOUNDATION DETAILS S-1.2 ROOF FRAMINGPLAN **S-2.0** LAND DEVELOPMENT SECTION

GENERAL NOTES

A. PARKING LOT DIMENSIONS ARE FROM FACE OF CURB TO FACE OF CURB UNLESS OTHERWISE NOTED.

B. PROVIDE EXPANSION JOINTS IN CONCRETE WALK @ 40' O.C. AND WHERE CONCRETE ABUTS THE BUILDING.

C. PREMIS IDENTIFICATION - SHALL BE MINIMUM 24 INCHES HIGH x .5 INCH WIDE AND SHALL CONTRAST WITH THEIR BACKGROUND AND SHALL BE VISIBLE FROM

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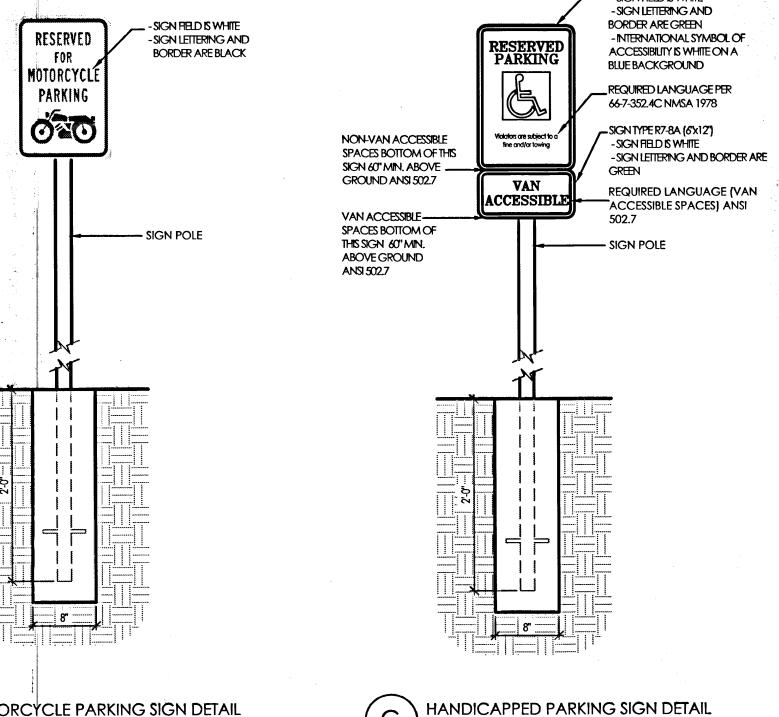
DESIGN CRITERIA


MAXIMUM BUILDING HEIGHT: MINIMUM BUILDING SETBACKS:


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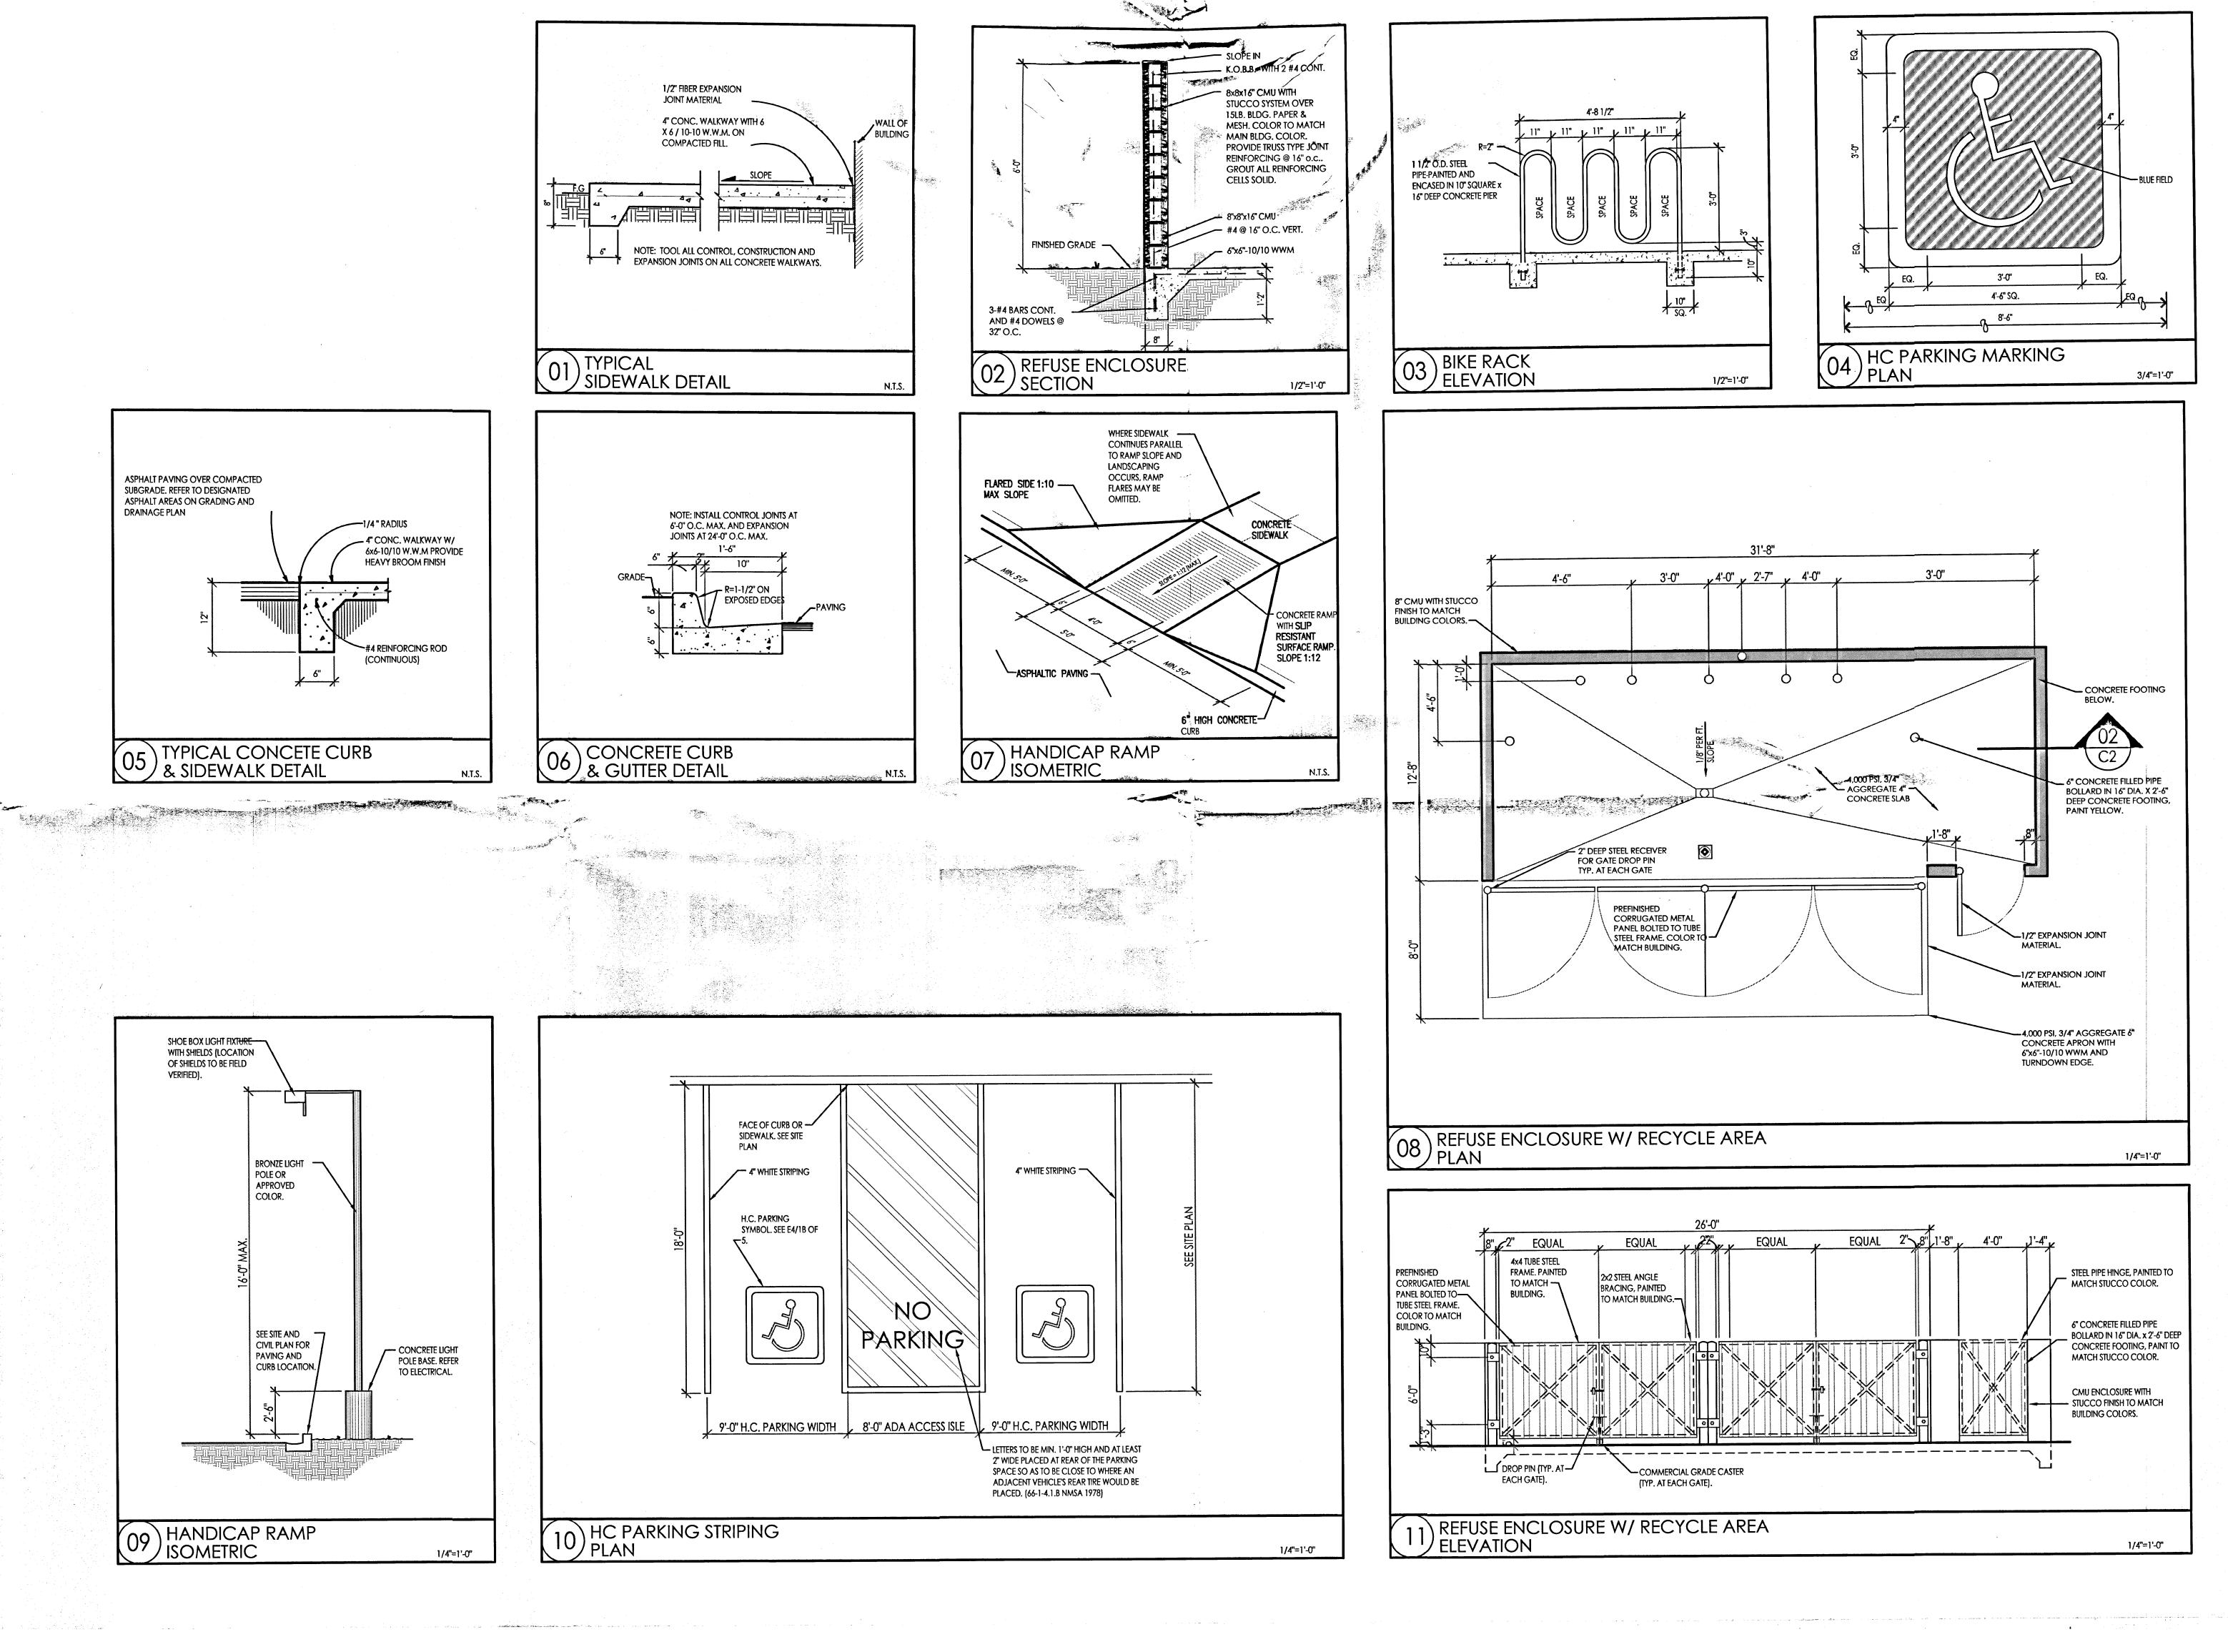
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INNOVA PLAZA - SITE DEVELOPMENT SITE DETAILS 401 EUBANK SE, ALBUQUERQUE, NM 87123


RBA ARCHITECTURE TO STATE THE DETAILS SITE DETAILS SITE DETAILS SITE DETAILS SESSON TO STATE THE PLANNING DESIGN TO STATE THE PROJECT #1459

DATE

SHEET NUMBER

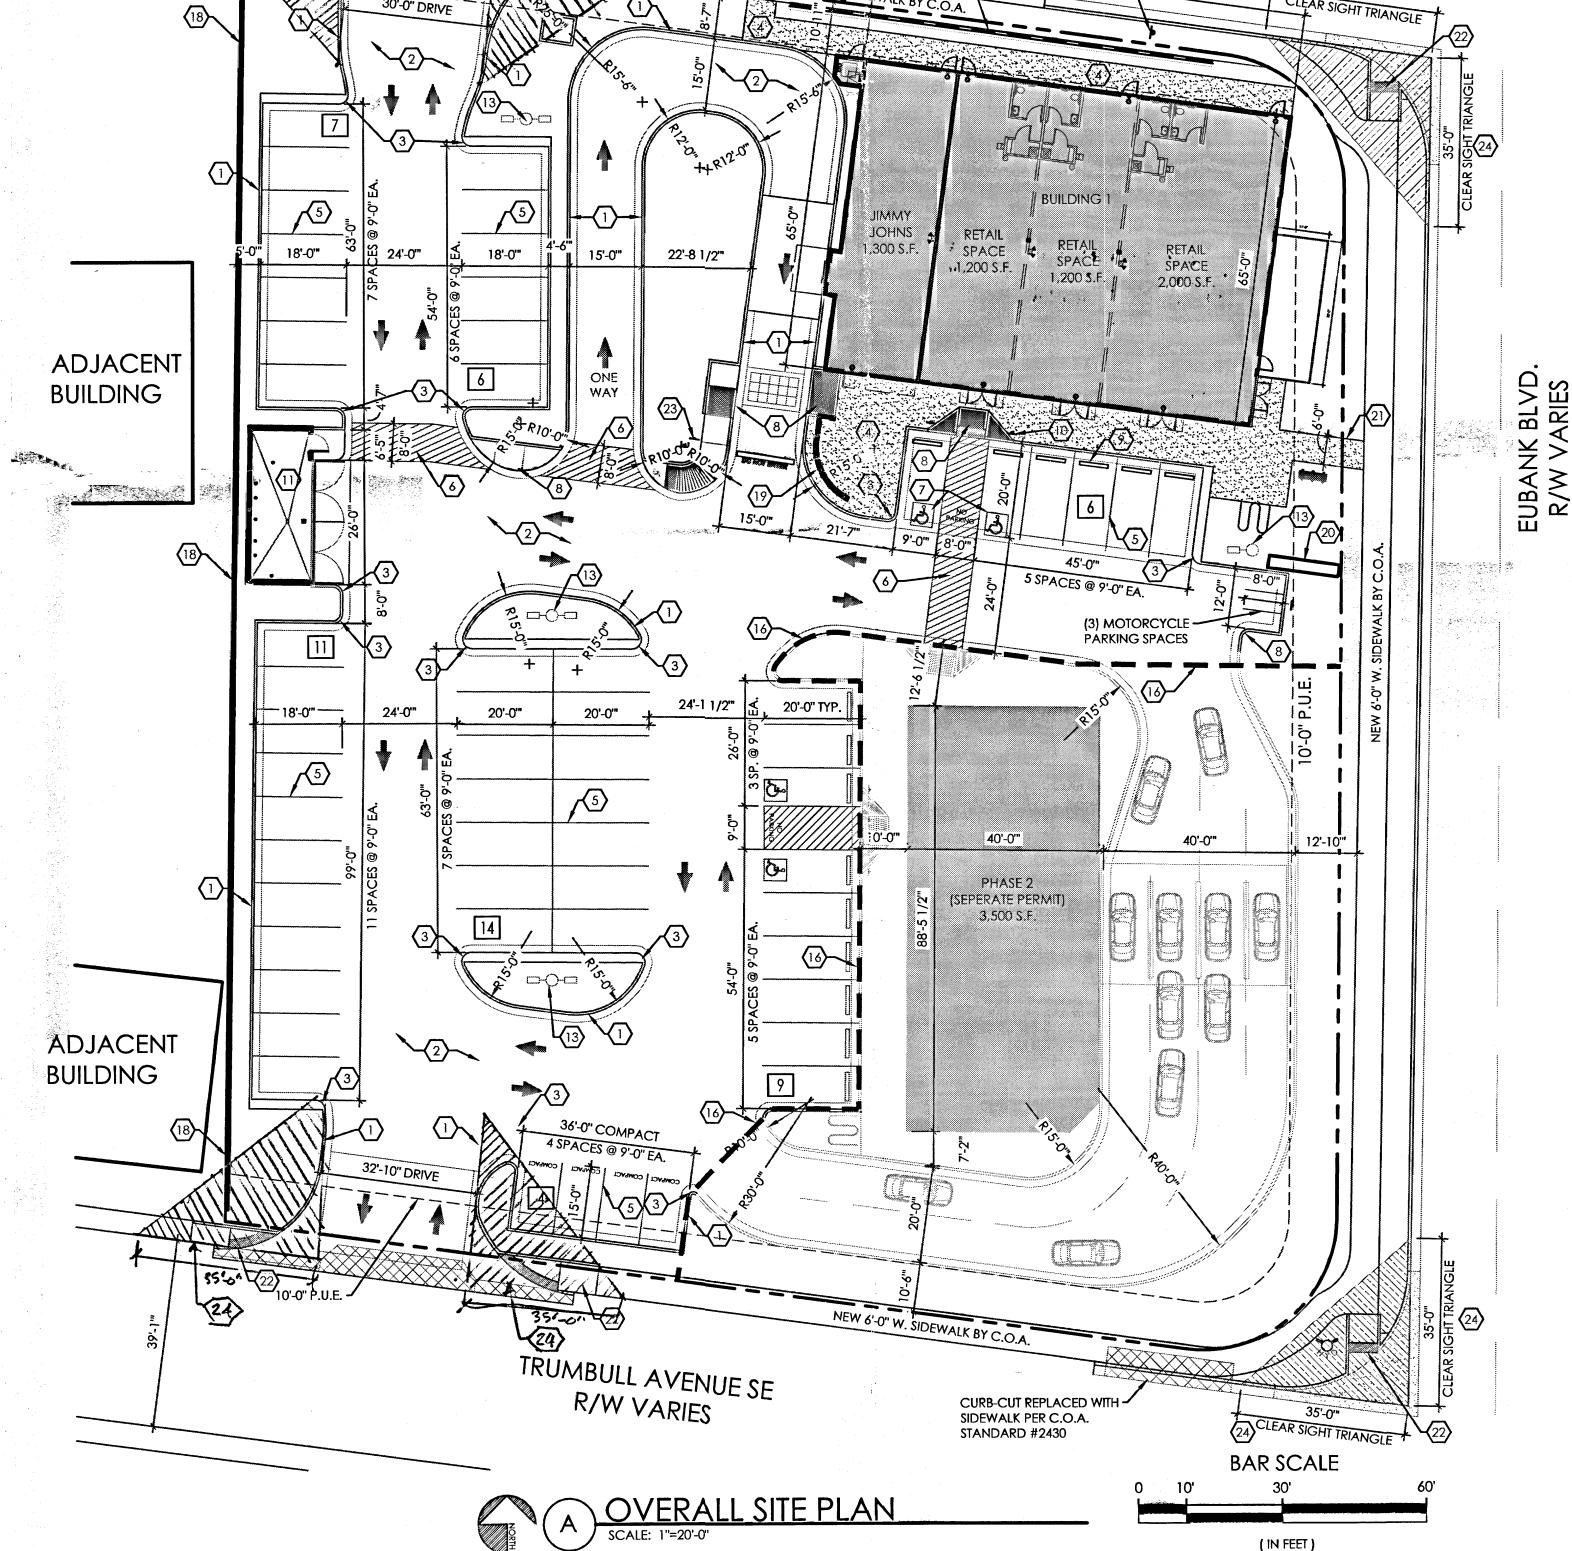04-13-2015

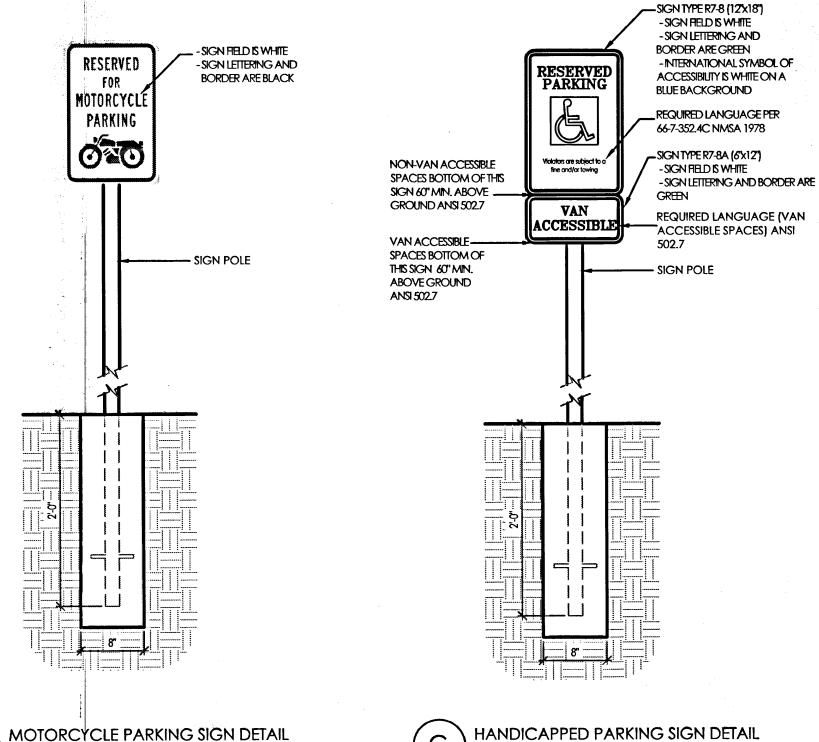C-2.0

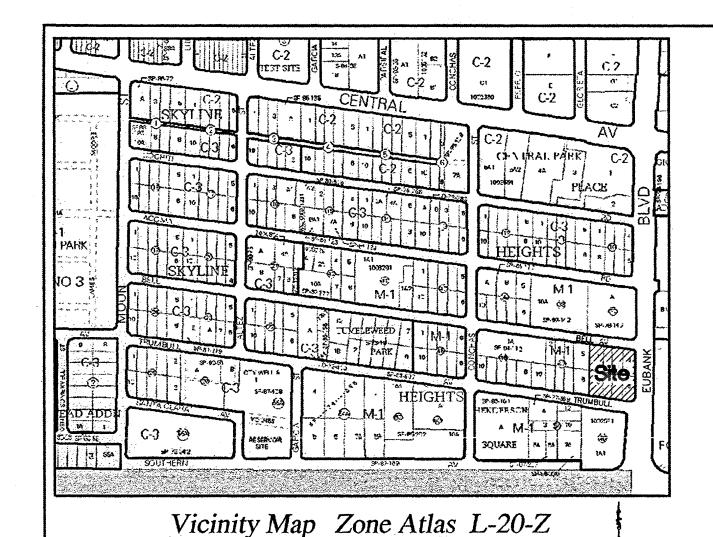

1. FIELD SURVEY PERFORMED IN SEPTEMBER 2013.
2. ALL DISTANCES ARE GROUND DISTANCES: U.S. SURVEY FOOT.

3. THE BASIS OF BEARINGS REFERENCES RECORD ROTATED TO NEW MEXICO STATE PLANE COORDINATES (NAD83-GRID). 4. LOT LINES BEING ELIMINATED BY PLAT ARE SHOWN AS THUS.........

Free Consent

THE SUBDIVISION HEREON DESCRIBED IS WITH THE FREE CONSENT AND AND IN ACCORDANCE WITH THE DESIRES OF THE UNDERSIGNED OWNER(S) AND/OR PROPRIETOR(S) THEREOF AND GRANT ALL UTILITY EASEMENTS SHOWN HEREON INCLUDING THE RIGHT TO CONSTRUCT, OPERATE, INSPECT, MAINTAIN FACILITIES THEREIN; AND ALL PUBLIC UTILITIES EASEMENTS SHOWN HEREON FOR THE COMMON AND JOINT USE OF GAS, ELECTRICAL POWER AND COMMUNICATION SERVICE FOR BURIED DISTRIBUTION LINES. CONDUITS AND PIPES FOR UNDERGROUND UTILITIES WHERE SHOWN OR INDICATED, AND INCLUDING THE RIGHT OF INGRESS AND EGRESS FOR CONSTRUCTION AND MAINTENANCE, AND THE RIGHT TO TRIM INTERFERING TREES AND SHRUBS. SAID OWNER(S) AND/OR PROPRIETOR(S) DO HEREBY CONSENT TO ALL OF THE FOREGOING AND DO HEREBY CERTIFY THAT THIS SUBDIVISION IS THEIR FREE ACT AND DEED. SAID OWNER(S) WARRANT THAT THEY HOLD AMONG THEM COMPLETE AND INDEFEASIBLE TITLE IN FEE SIMPLE TO THE LAND SUBDIMDED.

DOUGLAS A. ADAMS, MANAGING MEMBER

Acknowledgment

STATE OF NEW MEXICO COUNTY OF

20th of Jun. 2014 THIS INSTRUMENT WAS ACKNOWLEDGED BEFORE ME ON

OFFICIAL SEAL

CHARLES CALDERON

Notary Public

State of New Mexico

My Comm. Expires 6-11-1

BY: GLAD, LLC, DOUGLAS A. ADAMS, MANAGING MEMBER

_ 650 _ MY COMMISSION EXPIRES NOTARY PUBLIC

Indexing Information Section 29, Township 10 North, Range 4 East, N.M.P.I Subdivision: Skyline Heights Subdivision Owner: Doug Adams UPC #: Lot 1: 102005651239810718 Lot 2: 102005651939710717 Lot 3: 102005652339610716 Lot 4: 102005653139510715 Lot 6: 102005652338310713 Lot 7: 102005651938410712 Lot 8: 10200565123851071

Purpose of Plat

SUBDIVIDE AS SHOWN HEREON. GRANT EASEMENT AS SHOWN HEREON. SHOW VACATED EASEMENTS.

Subdivision Data

DATE OF SURVEY. SEPTEMBER 2013

Legal

ALL OF BLOCK FORTY-EIGHT (48) OF SKYLINE HEIGHTS SUBDIVISION, AS THE SAME IS SHOWN AND DESIGNATED ON THE PLAT OF BLOCKS 37 TO 52, INCLUSIVE, FILED IN THE OFFICE OF THE COUNTY CLERK OF BERNALILLO COUNTY, NEW MEXICO ON DECEMBER 1, 1948, AND THE EASTERL' ONE-HALF OF GLORIETA STREET SE, LYING ADJACENT TO AND BEING APPURTENANT TO THE ABOVE DESCRIBED REAL ESTATE. VACATED BY COMMISSION ORDINANCE NO. 1231, ADOPTED JUNE 4, 1957, LESS AND EXCEPTING THEREFROM THAT PORTION DEEDED TO THE CITY OF ALBUQUERQUE BY THAT CERTAIN DOCUMENT RECORDED OCTOBER 2, 2013 AS DOCUMENT NUMBER 2013-109954, RECORDS OF BERNALILLO COUNTY. NEW MEXICO.

BEGINNING AT A POINT ON THE SOUTHERLY RIGHT OF WAY OF BELL AVENUE SE, BEING MARKED WITH A BATHEY MARKER WITH CAP "LS 14271", WHENCE A TIE TO ACS MONUMENT "4-L22" WHICH BEARS S 89'54'41" E, A DISTANCE OF 7808.29 FEET;

THENCE, FROM THE POINT OF BEGINNING, 40.50 FEET ALONG A CURVE TO THE RIGHT, HAVING A RADIUS OF 28.00, A DELTA OF 82°52'51", A CHORD OF S 40°52'59" E, A DISTANCE OF 37.06 FEET, BEING A POINT ON THE WESTERLY RIGHT OF WAY OF EUBANK BOULEVARD SE, BEING MARKED BY BATHEY MARKER WITH CAP "LS 14271":

THENCE, COINCIDING SAID WESTERLY RIGHT OF WAY OF EUBANK BOULEVARD SE, S 00'33'26" W, A DISTANCE OF 227.45 FEET TO A POINT OF CURVATURE, BEING MARKED WITH A BATHEY MARKER WITH CAP "LS 14271":

THENCE, 27.13 FEET ALONG A CURVE TO THE RIGHT, HAVING A RADIUS OF 16.00, A DELTA OF 97'08'22". A CHORD OF S 49'07'37" W. A DISTANCE OF 23.99 FEET, BEING A POINT ON THE NORTHERLY RIGHT OF WAY OF TRUMBULL AVENUE SE, BEING MARKED WITH A BATHEY MARKER WITH CAP "LS 14271":

THENCE, COINCIDING WITH THE SAID NORTHERLY RIGHT OF WAY OF TRUMBULL AVENUE SE, N 821812" W. A DISTANCE OF 215.56 FEET, BEING MARKED WITH A 1/2 INCH REBAR WITH CAP

THENCE, LEAVING SAID NORTHERLY RIGHT OF WAY OF TRUMBULL SE, N 00°57'43" E, A DISTANCE OF 269.99 FEET, TO A POINT ON THE SOUTHERLY RIGHT OF WAY OF BELL AVENUE SE, BEING MARKED BY A 1/2 INCH REBAR;

THENCE, S 82'19'25" E, A DISTANCE OF 207.04 FEET, TO THE POINT OF BEGINNING, CONTAINING 1.4282 ACRES (62,211 SQ. FT.) MORE OR LESS.

Solar Collection Note

PER SECTION 14-14-4-7 OF THE SUBDIVISION ORDINANCE:

NO PROPERTY WITHIN THE AREA OF REQUESTED FINAL ACTION SHALL AT ANY TIME BE SUBJECT TO A DEED RESTRICTION, COVENANT, OR BUILDING AGREEMENT PROHIBITING SOLAR COLLECTORS FROM BEING INSTALLED ON BUILDINGS OR ERECTED ON THE LOTS OR PARCELS WITHIN THE AREA OF PROPOSED PLAT, THE FOREGOING REQUIREMENT SHALL BE A CONDITION TO APPROVAL OF

Plat for

Lot 1-A, Block 48 Skyline Heights Subdivision Being Comprised of

Lots 1-3, 6-8 and Portions of Lots 4 & 5, Block 48 PAID ON UPC # 10 OACTES (2013+2014) and the E'ly 1/2 of Vacated Glorieta Street SE PROPERTY OWNER OF RECORD Section 29, Township 10 North, Range 4 East Helweg (2013) (Glas UC (2014)) Section 29, Marian Dringing 1 Marian New Mexico Principal Meridian

City of Albuquerque Bernalillo County, New Mexico June 2014

Approved and Accepted by:

APPROVAL AND CONDITIONAL ACCEPTANCE AS SPECIFIED BY THE ALBUQUERQUE SUBDIVISION ORDINANCE, CHAPTER 14 ARTICLE 14 OF THE REVISED ORDINANCES OF ALBUQUERQUE, NEW MEXICO, 1994.

Application Number 14-70223

Plat approvals:	7-16-14
PNM_Electric, Services	Date
0// EH	7/2/14
New Mexico Gas Company	Date
I rest from	7-16-14
Owest Corporation d/b/a CenturyLink QC	Date
Comcast	- Date
city approvals:	
L): OP Dosta	6-03-14
100011001	- T CO 1/

Date 8-26-14 Traffic Engine Date 08 20/14 ABCWUA Date 8-20-14 Parks and Recreation Department Date 8-20-14 Date Centra Cherr 8-20-M Date

Surveyor's Certificate

"I, DAVID J. THOMPSON, A DULY QUALIFIED REGISTERED PROFESSIONAL LAND SURVEYOR UNDER THE LAWS OF THE STATE OF NEW MEXICO, DO HEREBY CERTIFY THAT THIS PLAT AND DESCRIPTION WERE PREPARED BY ME OR UNDER MY SUPERVISION, SHOWS ALL EASEMENTS AS SHOWN ON THE PLAT OF RECORD OR MADE KNOWN TO ME BY THE OWNERS AND/OR PROPRIETORS OF THE SUBDIVISION SHOWN HEREON, THE UTILITY COMPANIES OR OTHER INTERESTED PARTIES AND MEETS THE MINIMUM REQUIREMENTS FOR MONUMENTATION AND SURVEYS OF THE ALBUQUERQUE SUBDIVISION ORDINANCE. AND FURTHER MEETS THE MINIMUM STANDARDS FOR LAND SURVEYING IN THE STATE OF NEW MEXICO AND IS TRUE AND CORRECT TO THE BEST OF MY KNOWLEDGE AND BELIEF."


N.M.R.P.S. No. 12657

P.O. BOX 44414 RIO RANCHO, N.M. 87174 Phone (505) 896-3050 Fax (505) 891-0244


Sheet 1 of 2

8-26-14


08/26/2014 04:34 PM Page: 1 of 2 RyPLAT R:\$25.00 B: 2014C P 0091 M. Toulous Olivere, Bernalillo Cov

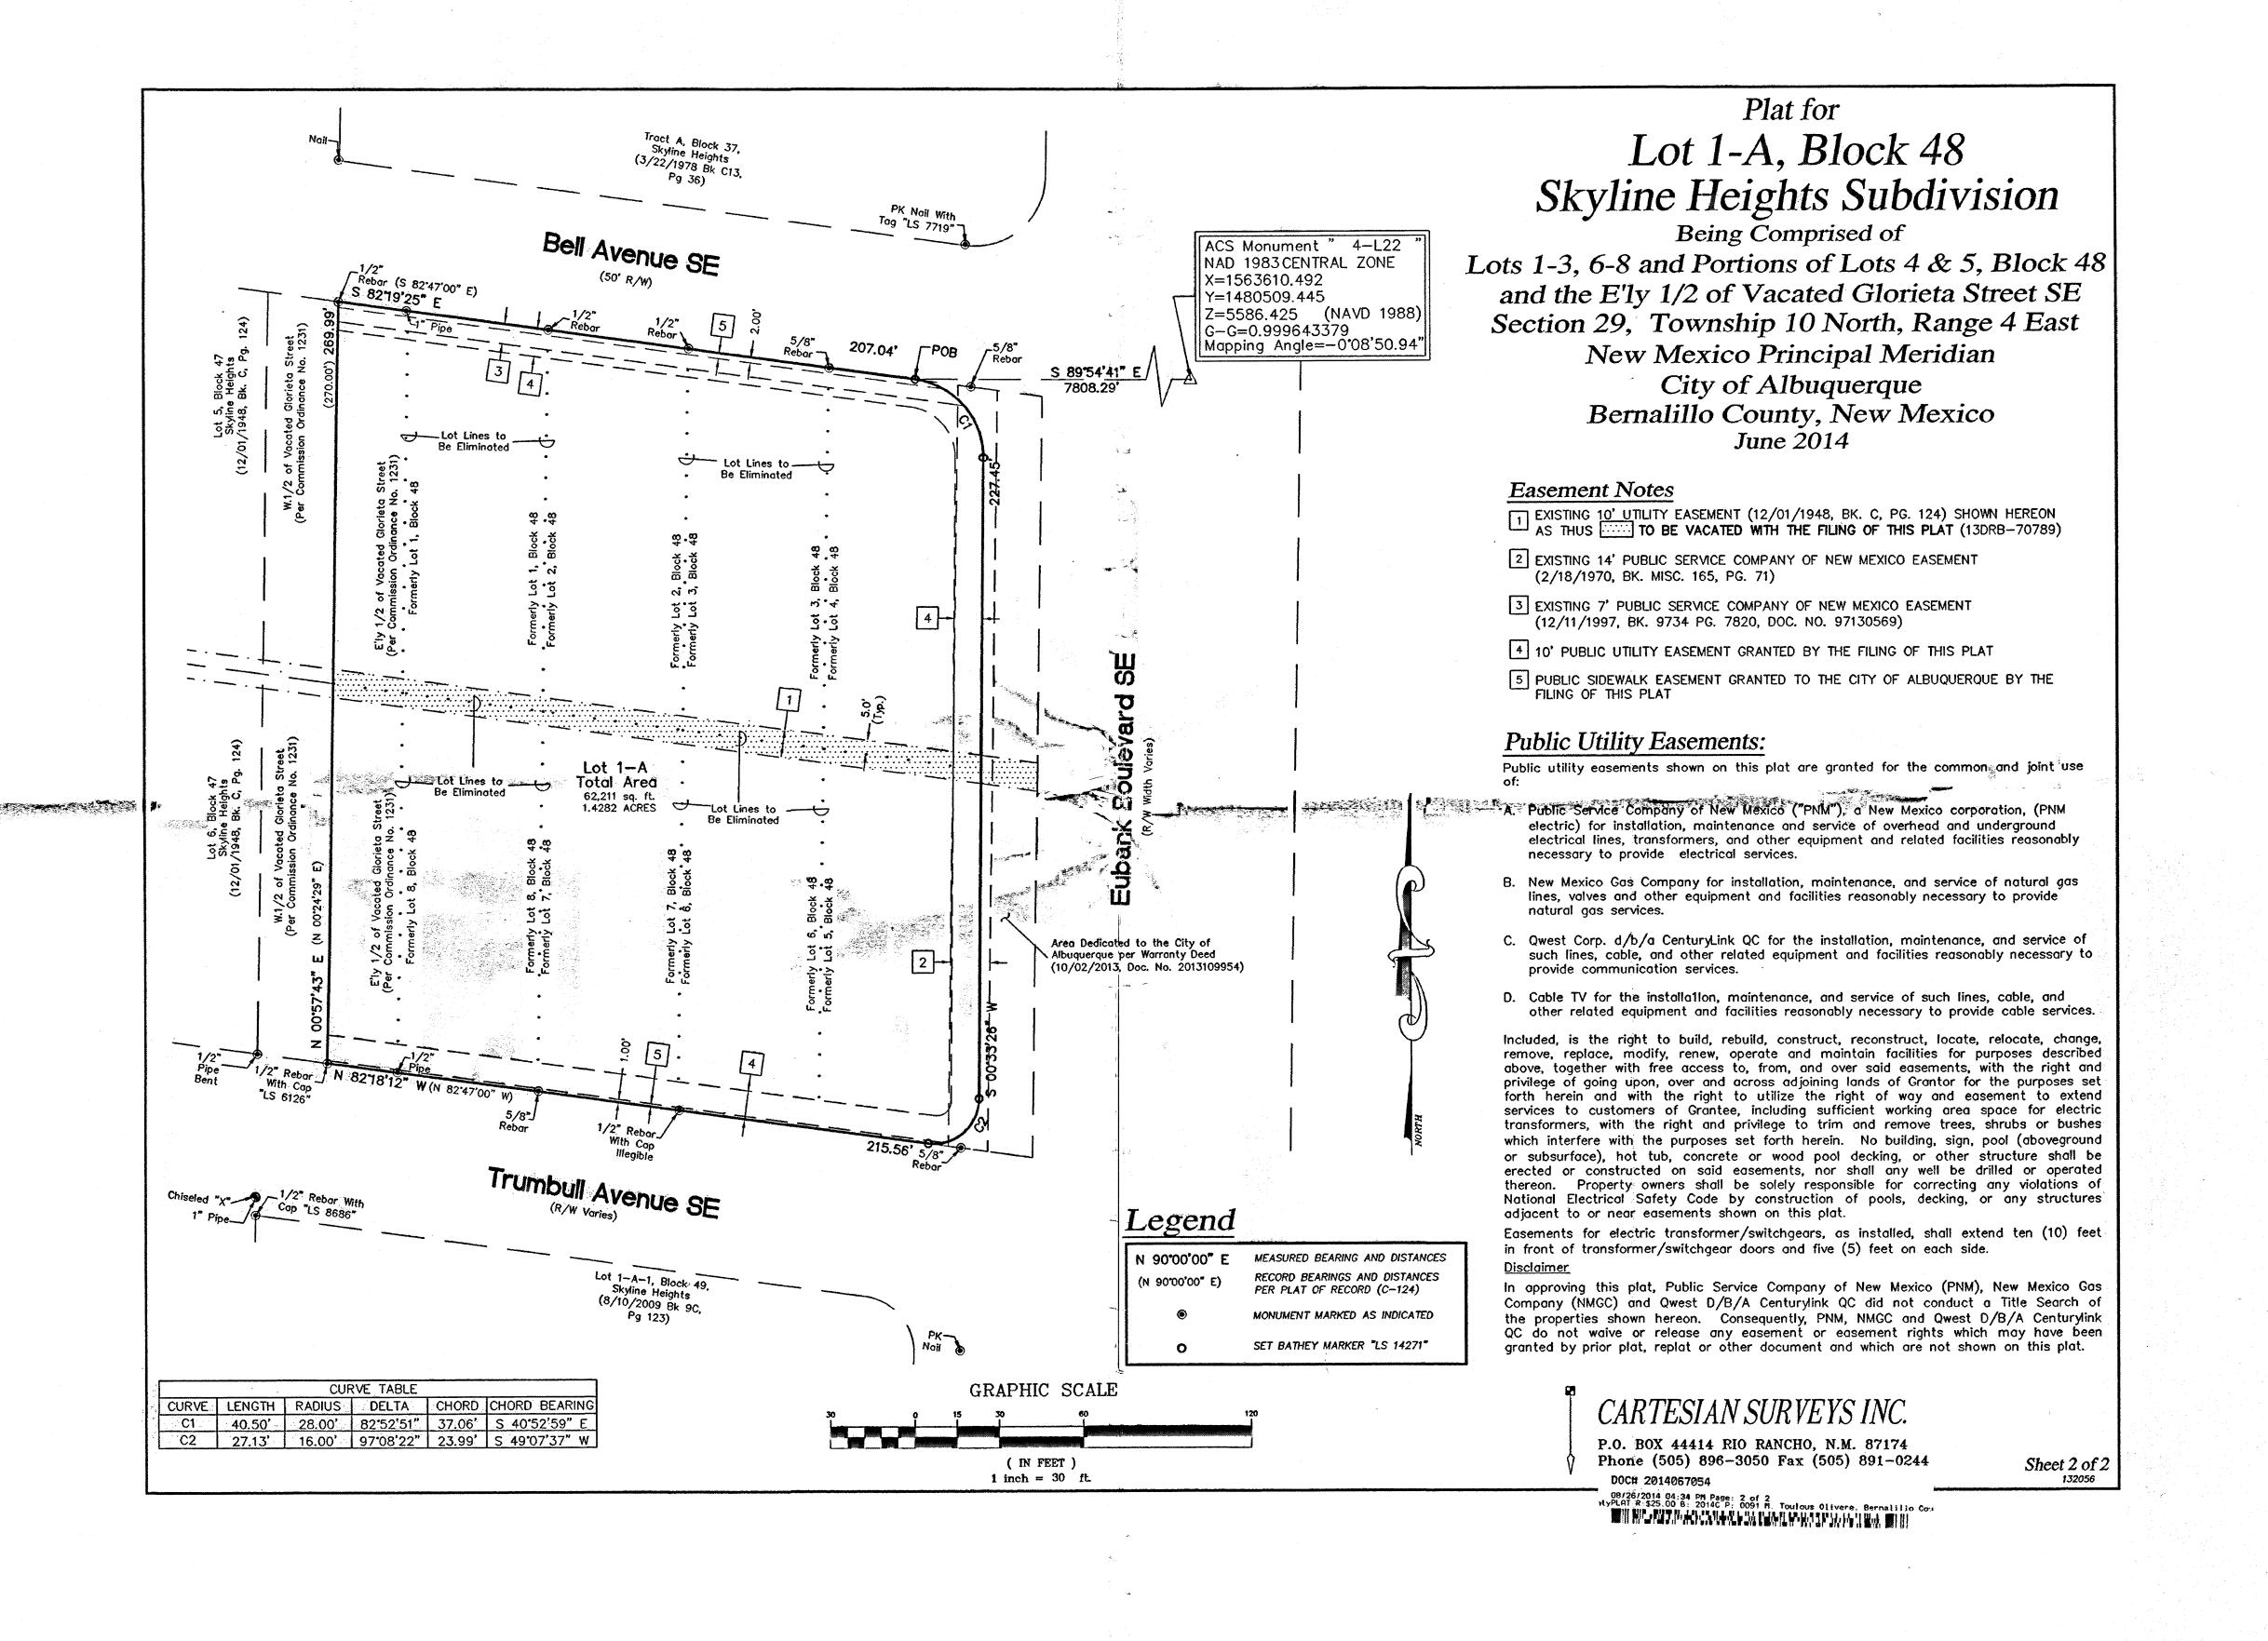



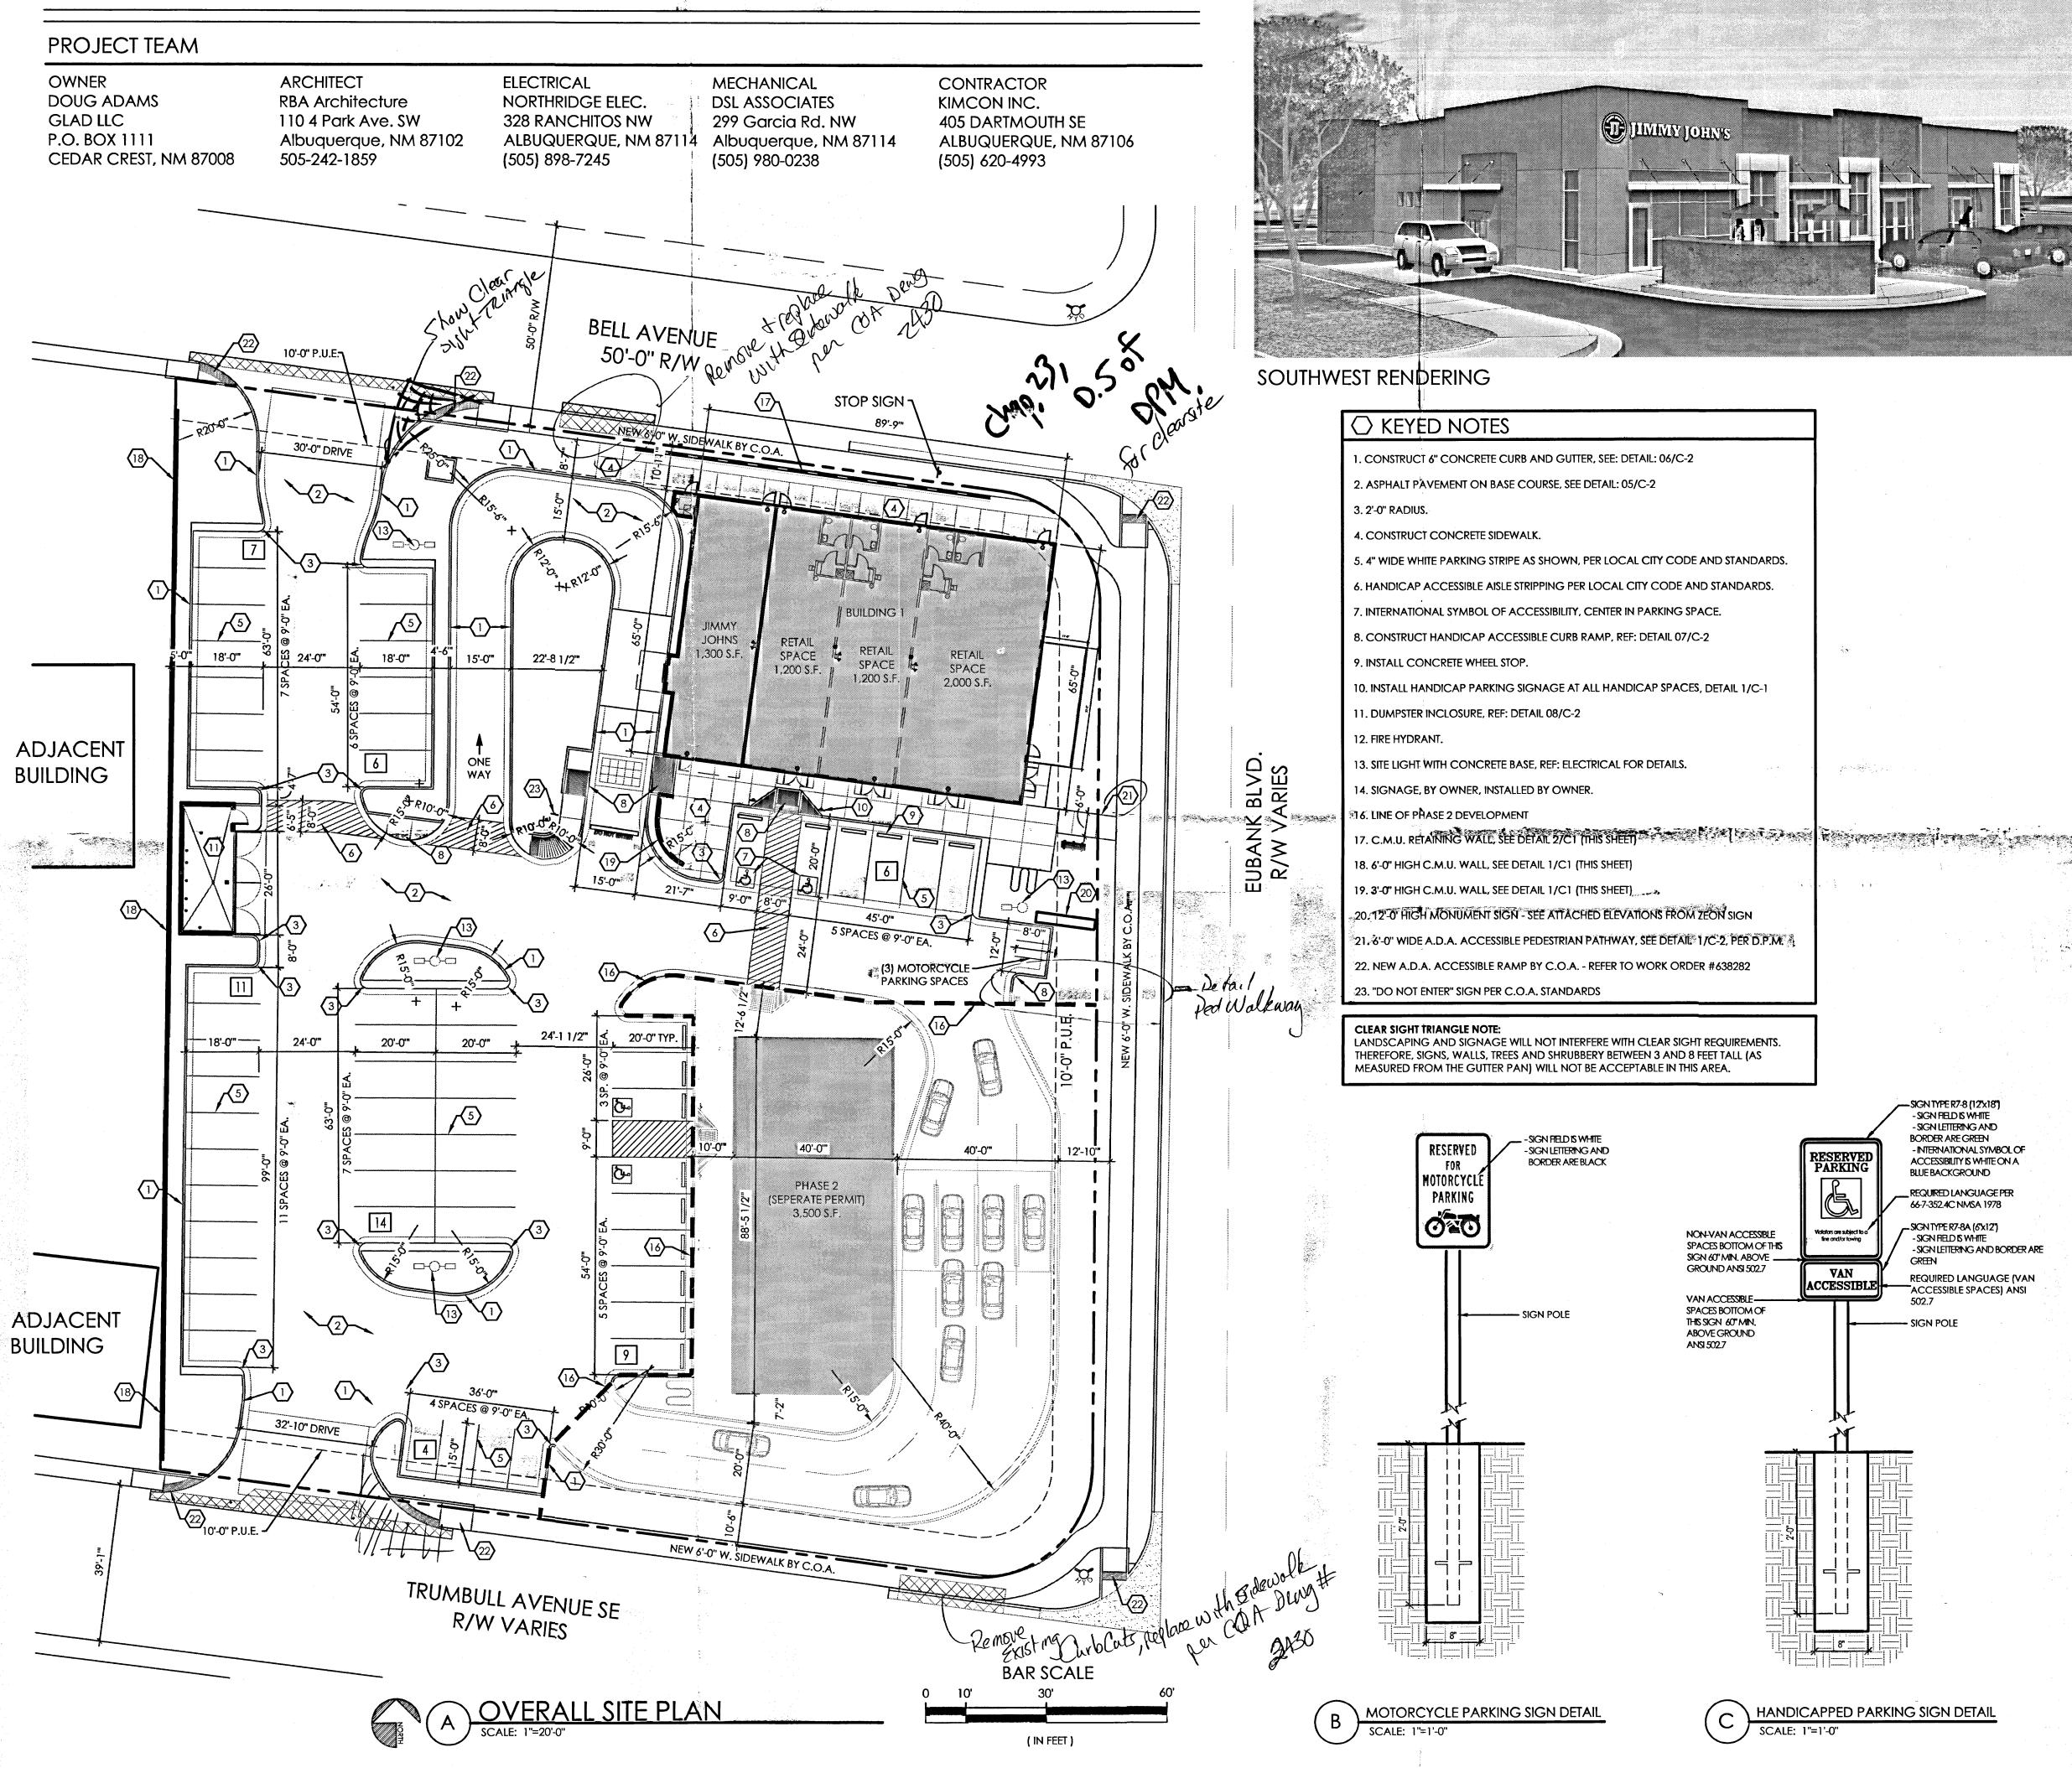



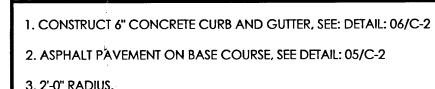


5. 4" WIDE WHITE PARKING STRIPE AS SHOWN, PER LOCAL CITY CODE AND STANDARDS.


10. INSTALL HANDICAP PARKING SIGNAGE AT ALL HANDICAP SPACES, DETAIL 1/C-1


21. 6'-0" WIDE A.D.A. ACCESSIBLE PEDESTRIAN PATHWAY, SEE DETAIL 1/C-2, PER D.P.M.

22. NEW A.D.A. ACCESSIBLE RAMP BY C.O.A. - REFER TO WORK ORDER #638282


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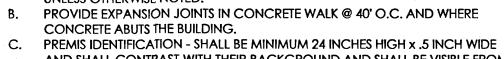


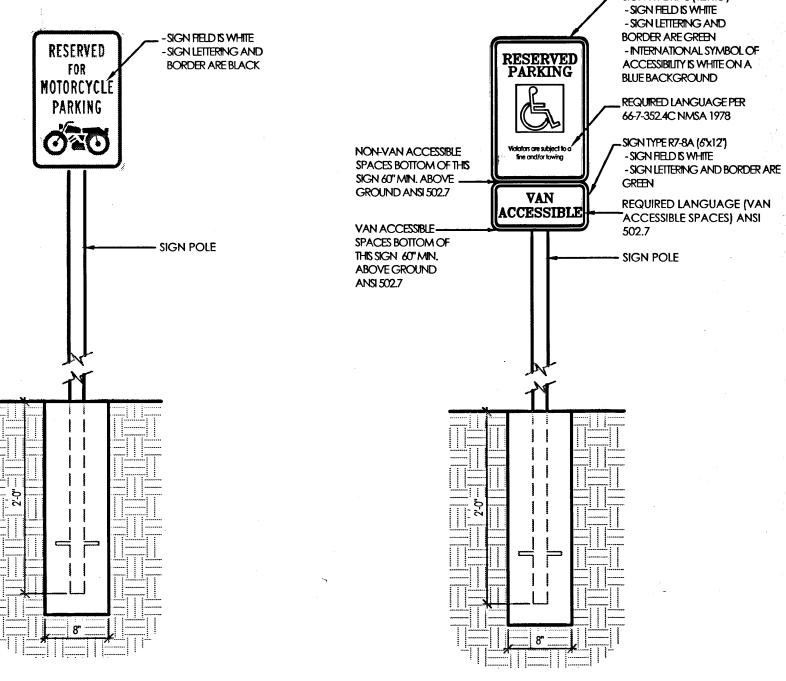

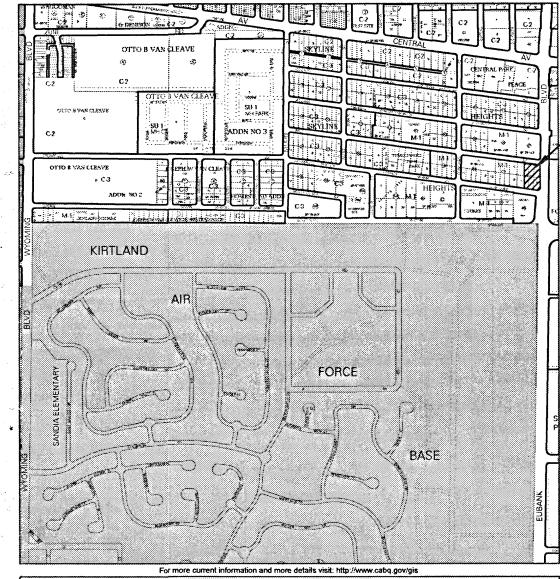

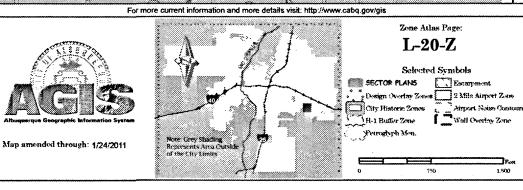



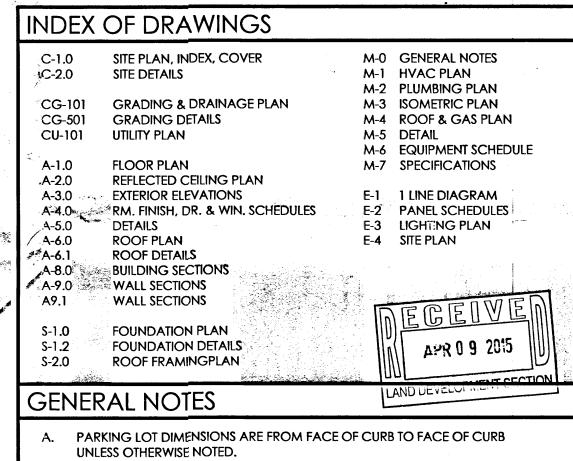

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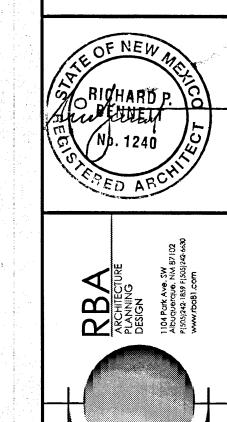
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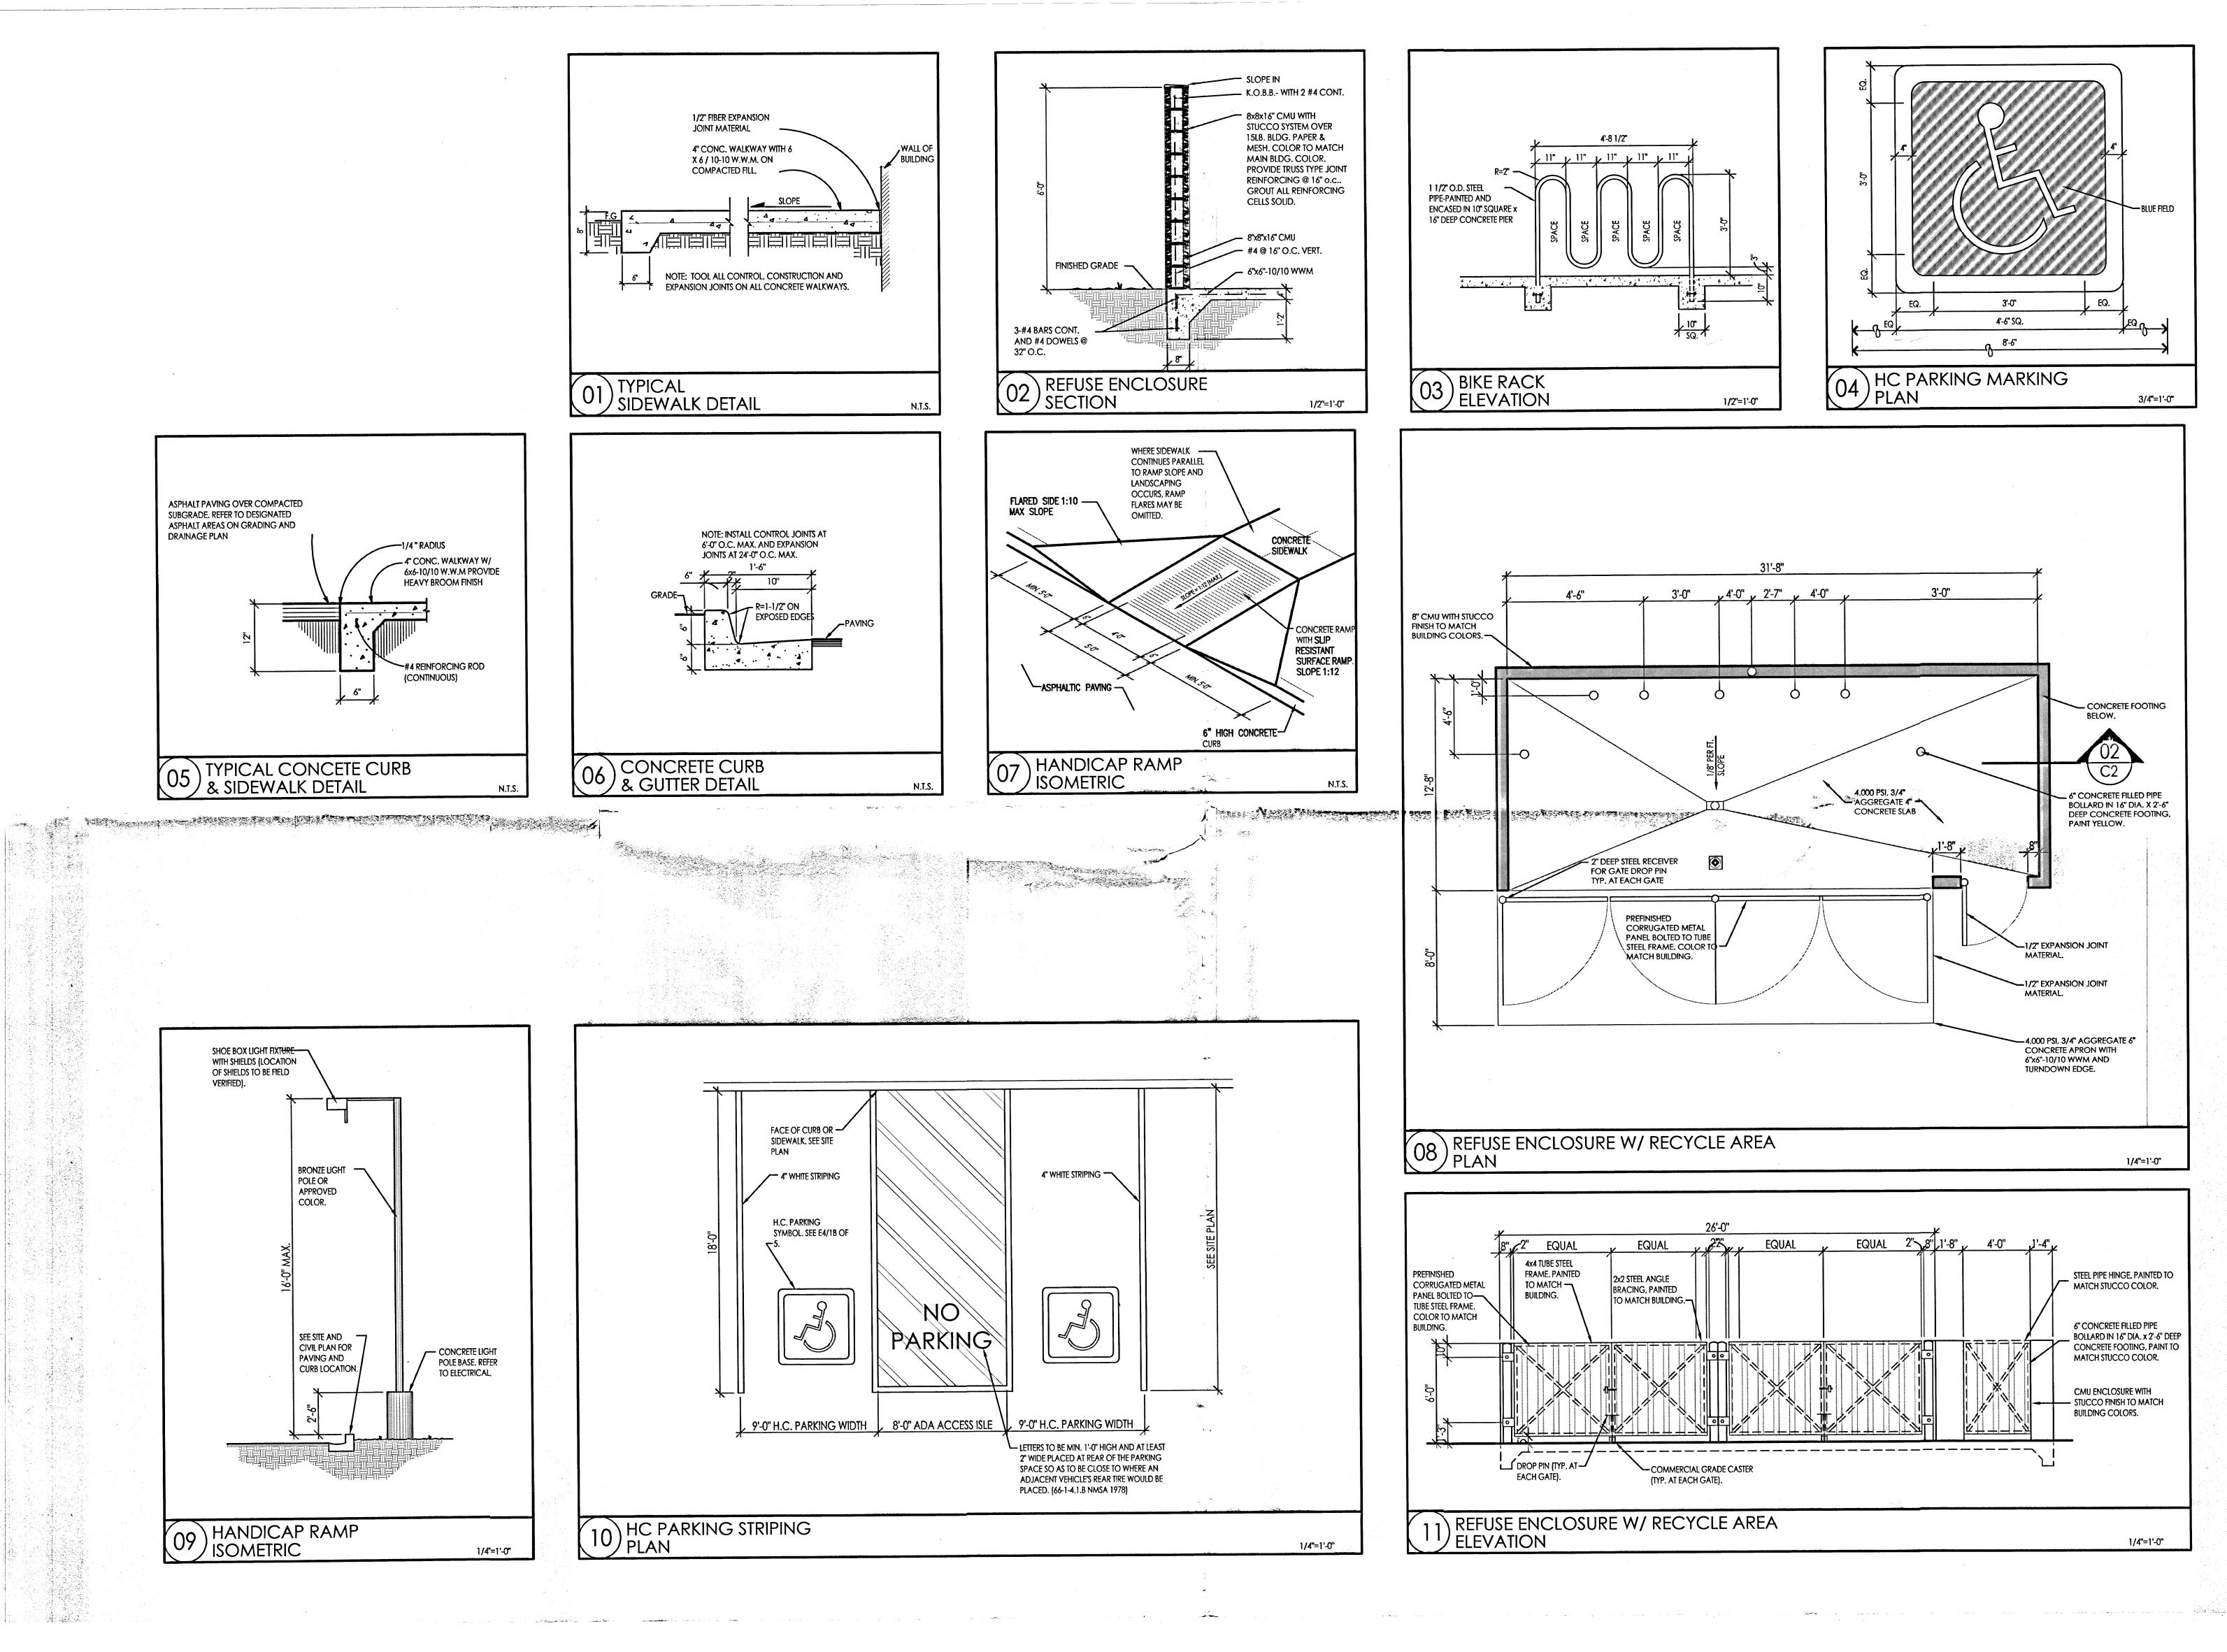


401

REVISION DATE

DATE 04-07-2015 SHEET NUMBER

C-1.0



ASPHALT PAVING OVER COMPACTED SUBGRADE. REFER TO DESIGNATED

& SIDEWALK DETAIL

SHOE BOX LIGHT FIXTURE

BRONZE LIGHT

SEE SITE AND CIVIL PLAN FOR

PAVING AND

HANDICAP RAMP ISOMETRIC

CURB LOCATION

POLE OR APPROVED COLOR.

WITH SHIELDS (LOCATION

OF SHIELDS TO BE FIELD

ASPHALT AREAS ON GRADING AND

DRAINAGE PLAN

UQUERQUE, S **REVISION DATE**

ARCHITE PLANNING DESIGN

DATE

SHEET NUMBER

04-07-2015

C-2.0



REVISION DATE


04-07-2015

C-1.0


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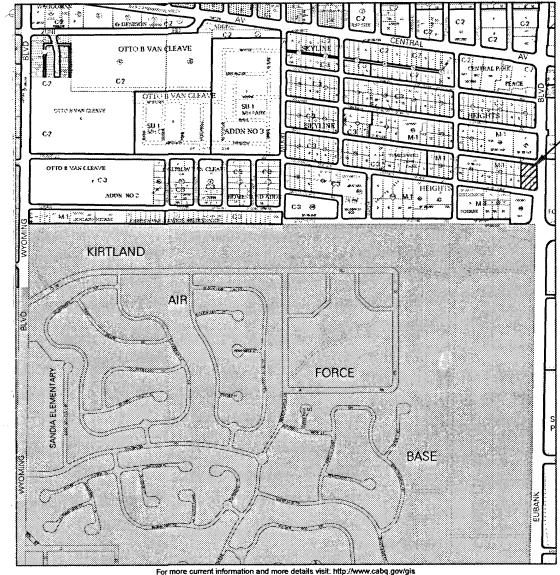





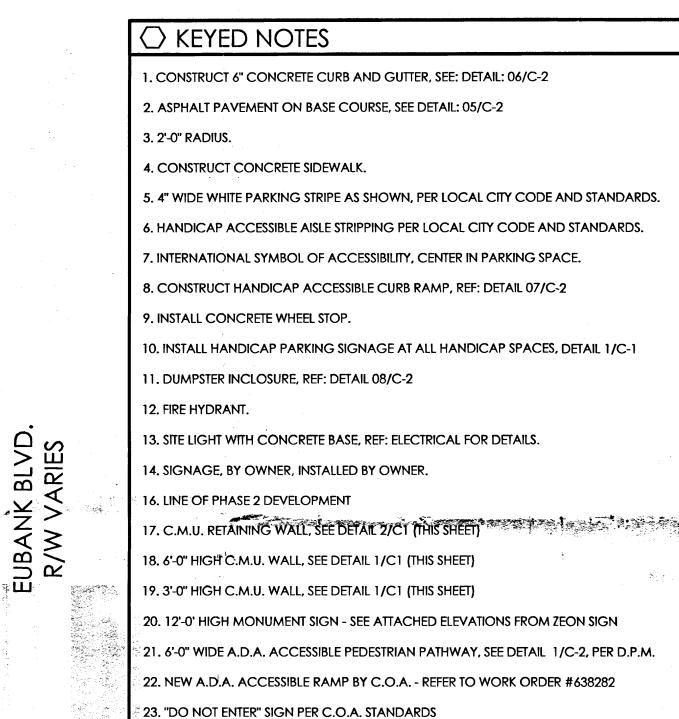


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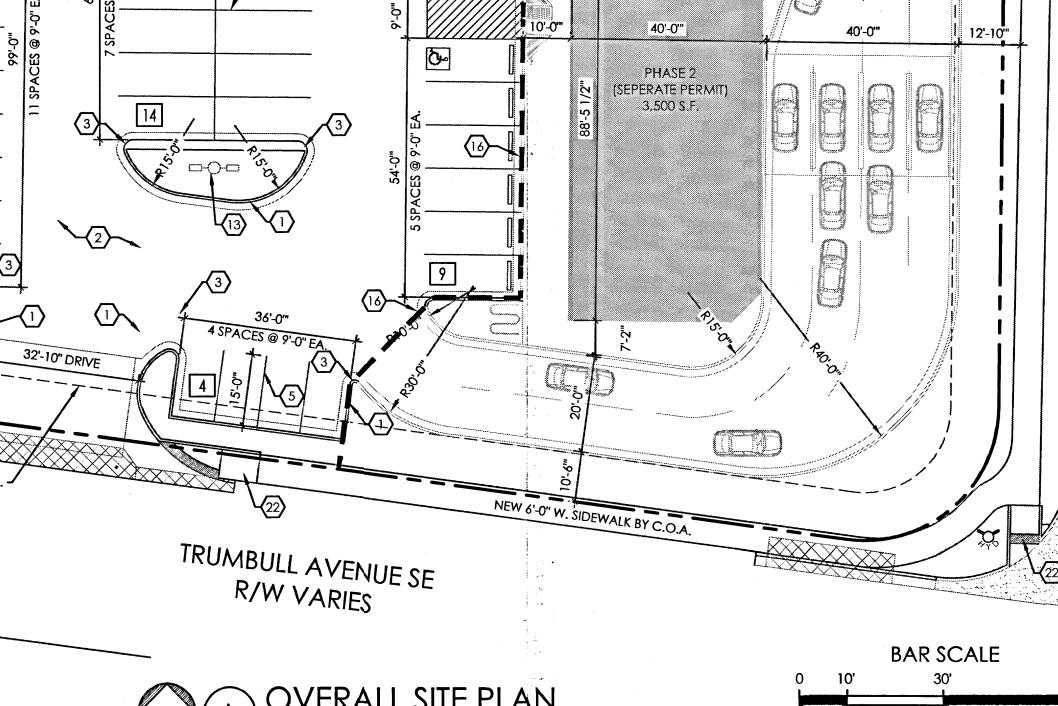
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INNOVAPLAZA

ELECTRICAL

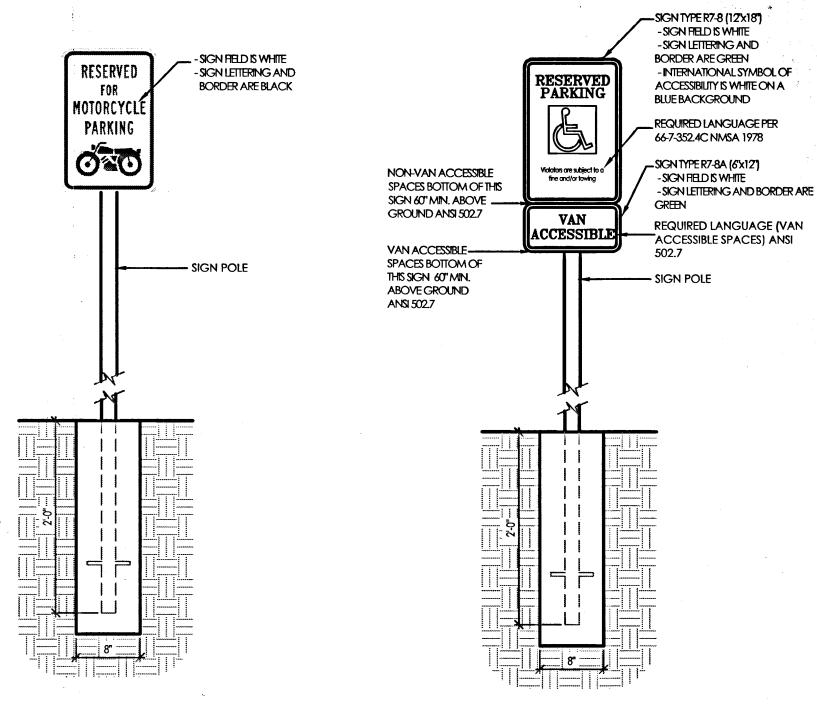(505) 898-7245

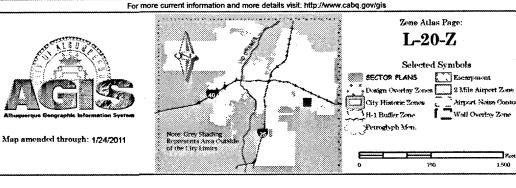22'-8 1/2'"

15'-0'"

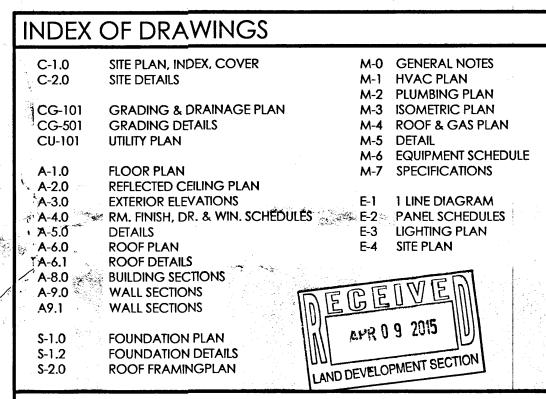NORTHRIDGE ELEC.

328 RANCHITOS NW

ALBUQUERQUE, NM 87114

BELL AVENUE

50'-0" R/W

MECHANICAL

(505) 980-0238

DSL ASSOCIATES

299 Garcia Rd. NW

Albuquerque, NM 87114

STOP SIGN

CONTRACTOR

405 DARTMOUTH SE

ALBUQUERQUE NM 87106

KIMCON INC.

(505) 620-4993

RETAIL SPACE 2,000 S.F.

(3) MOTORCYCLE

PARKING SPACES

(IN FEET)

ARCHITECT

505-242-1859

30'-0" DRIVE

|災 24'-0'"

18'-0'"

RBA Architecture

110 4 Park Ave. SW

Albuquerque, NM 87102

PROJECT TEAM

CEDAR CREST, NM 87008

OWNER

ADJACENT

BUILDING


ADJACENT

BUILDING

GLAD LLC


DOUG ADAMS

P.O. BOX 1111

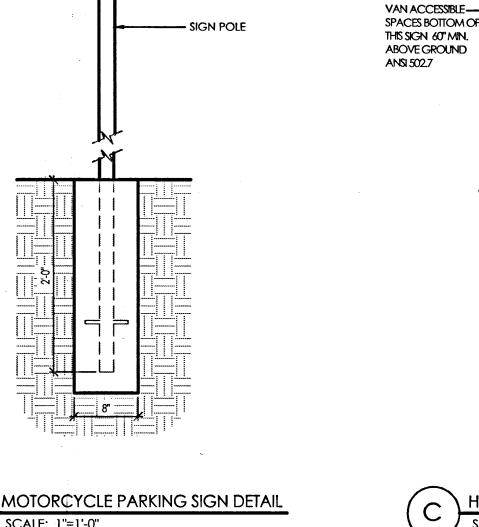

MOTORCYCLE PARKING SIGN DETAIL

HANDICAPPED PARKING SIGN DETAIL

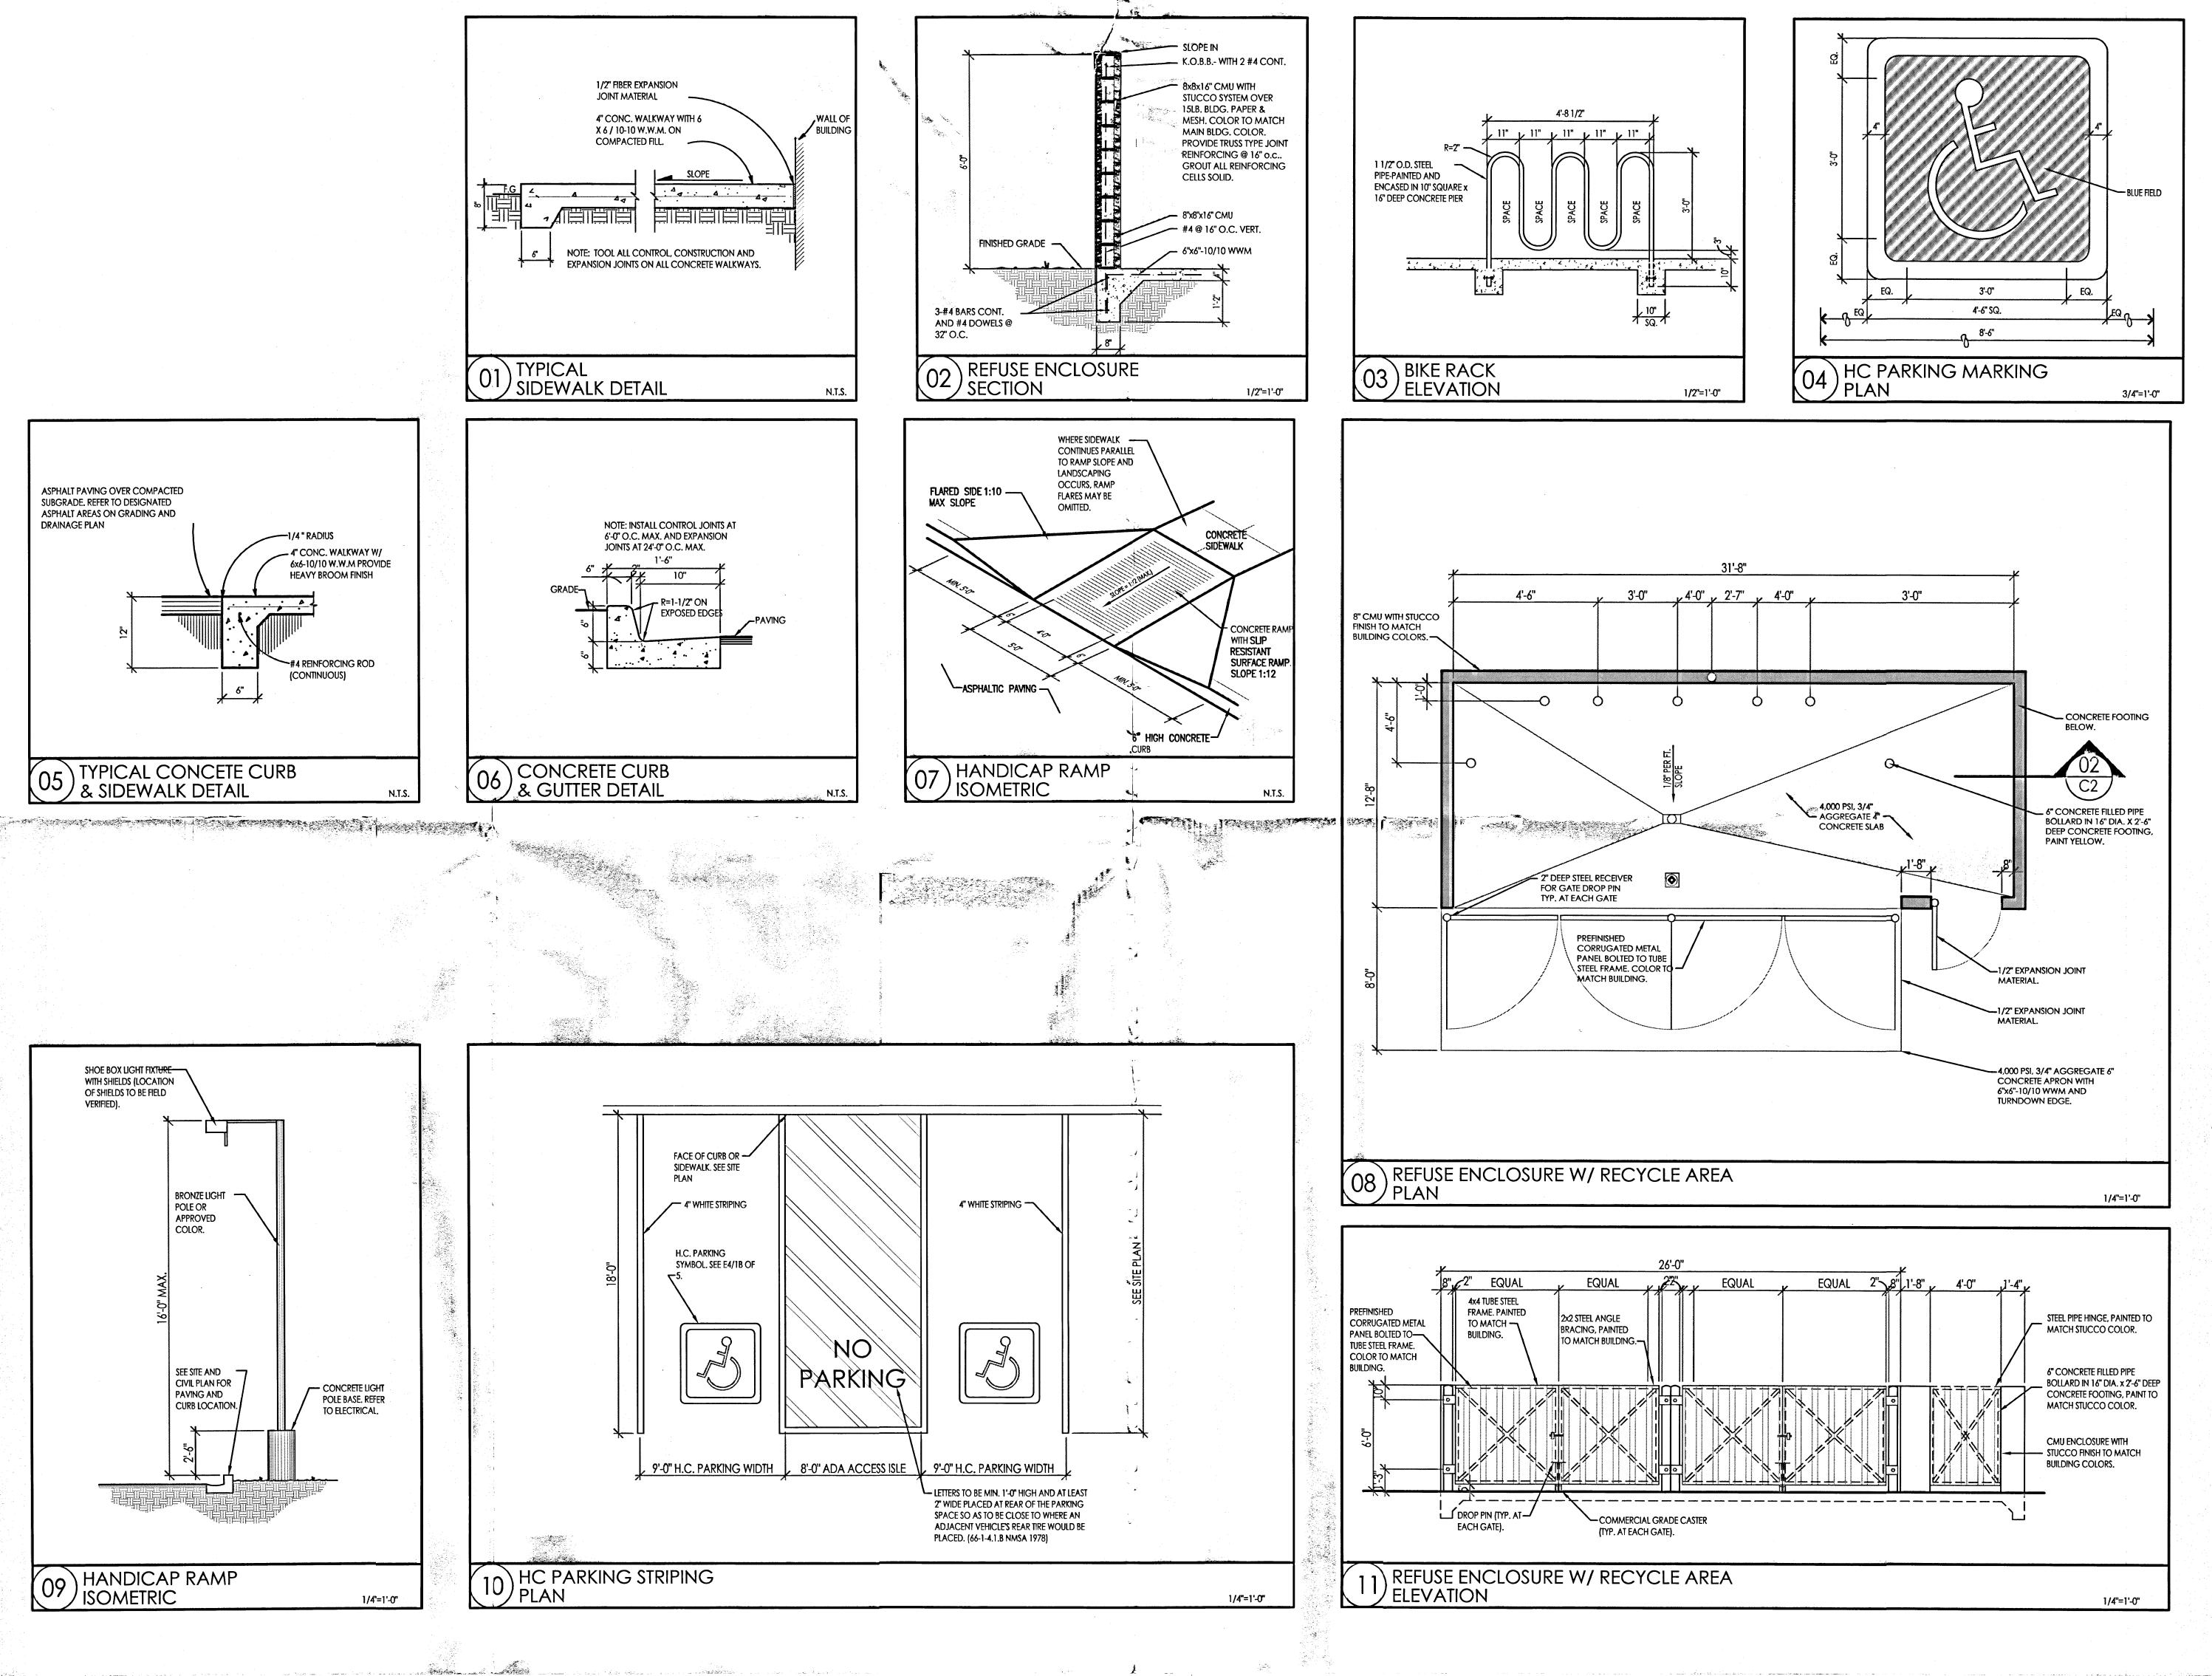

ELOPMENT

SITE 401 **REVISION DATE**


BENNETT

DATE

SHEET NUMBER

04-07-2015

C-2.0

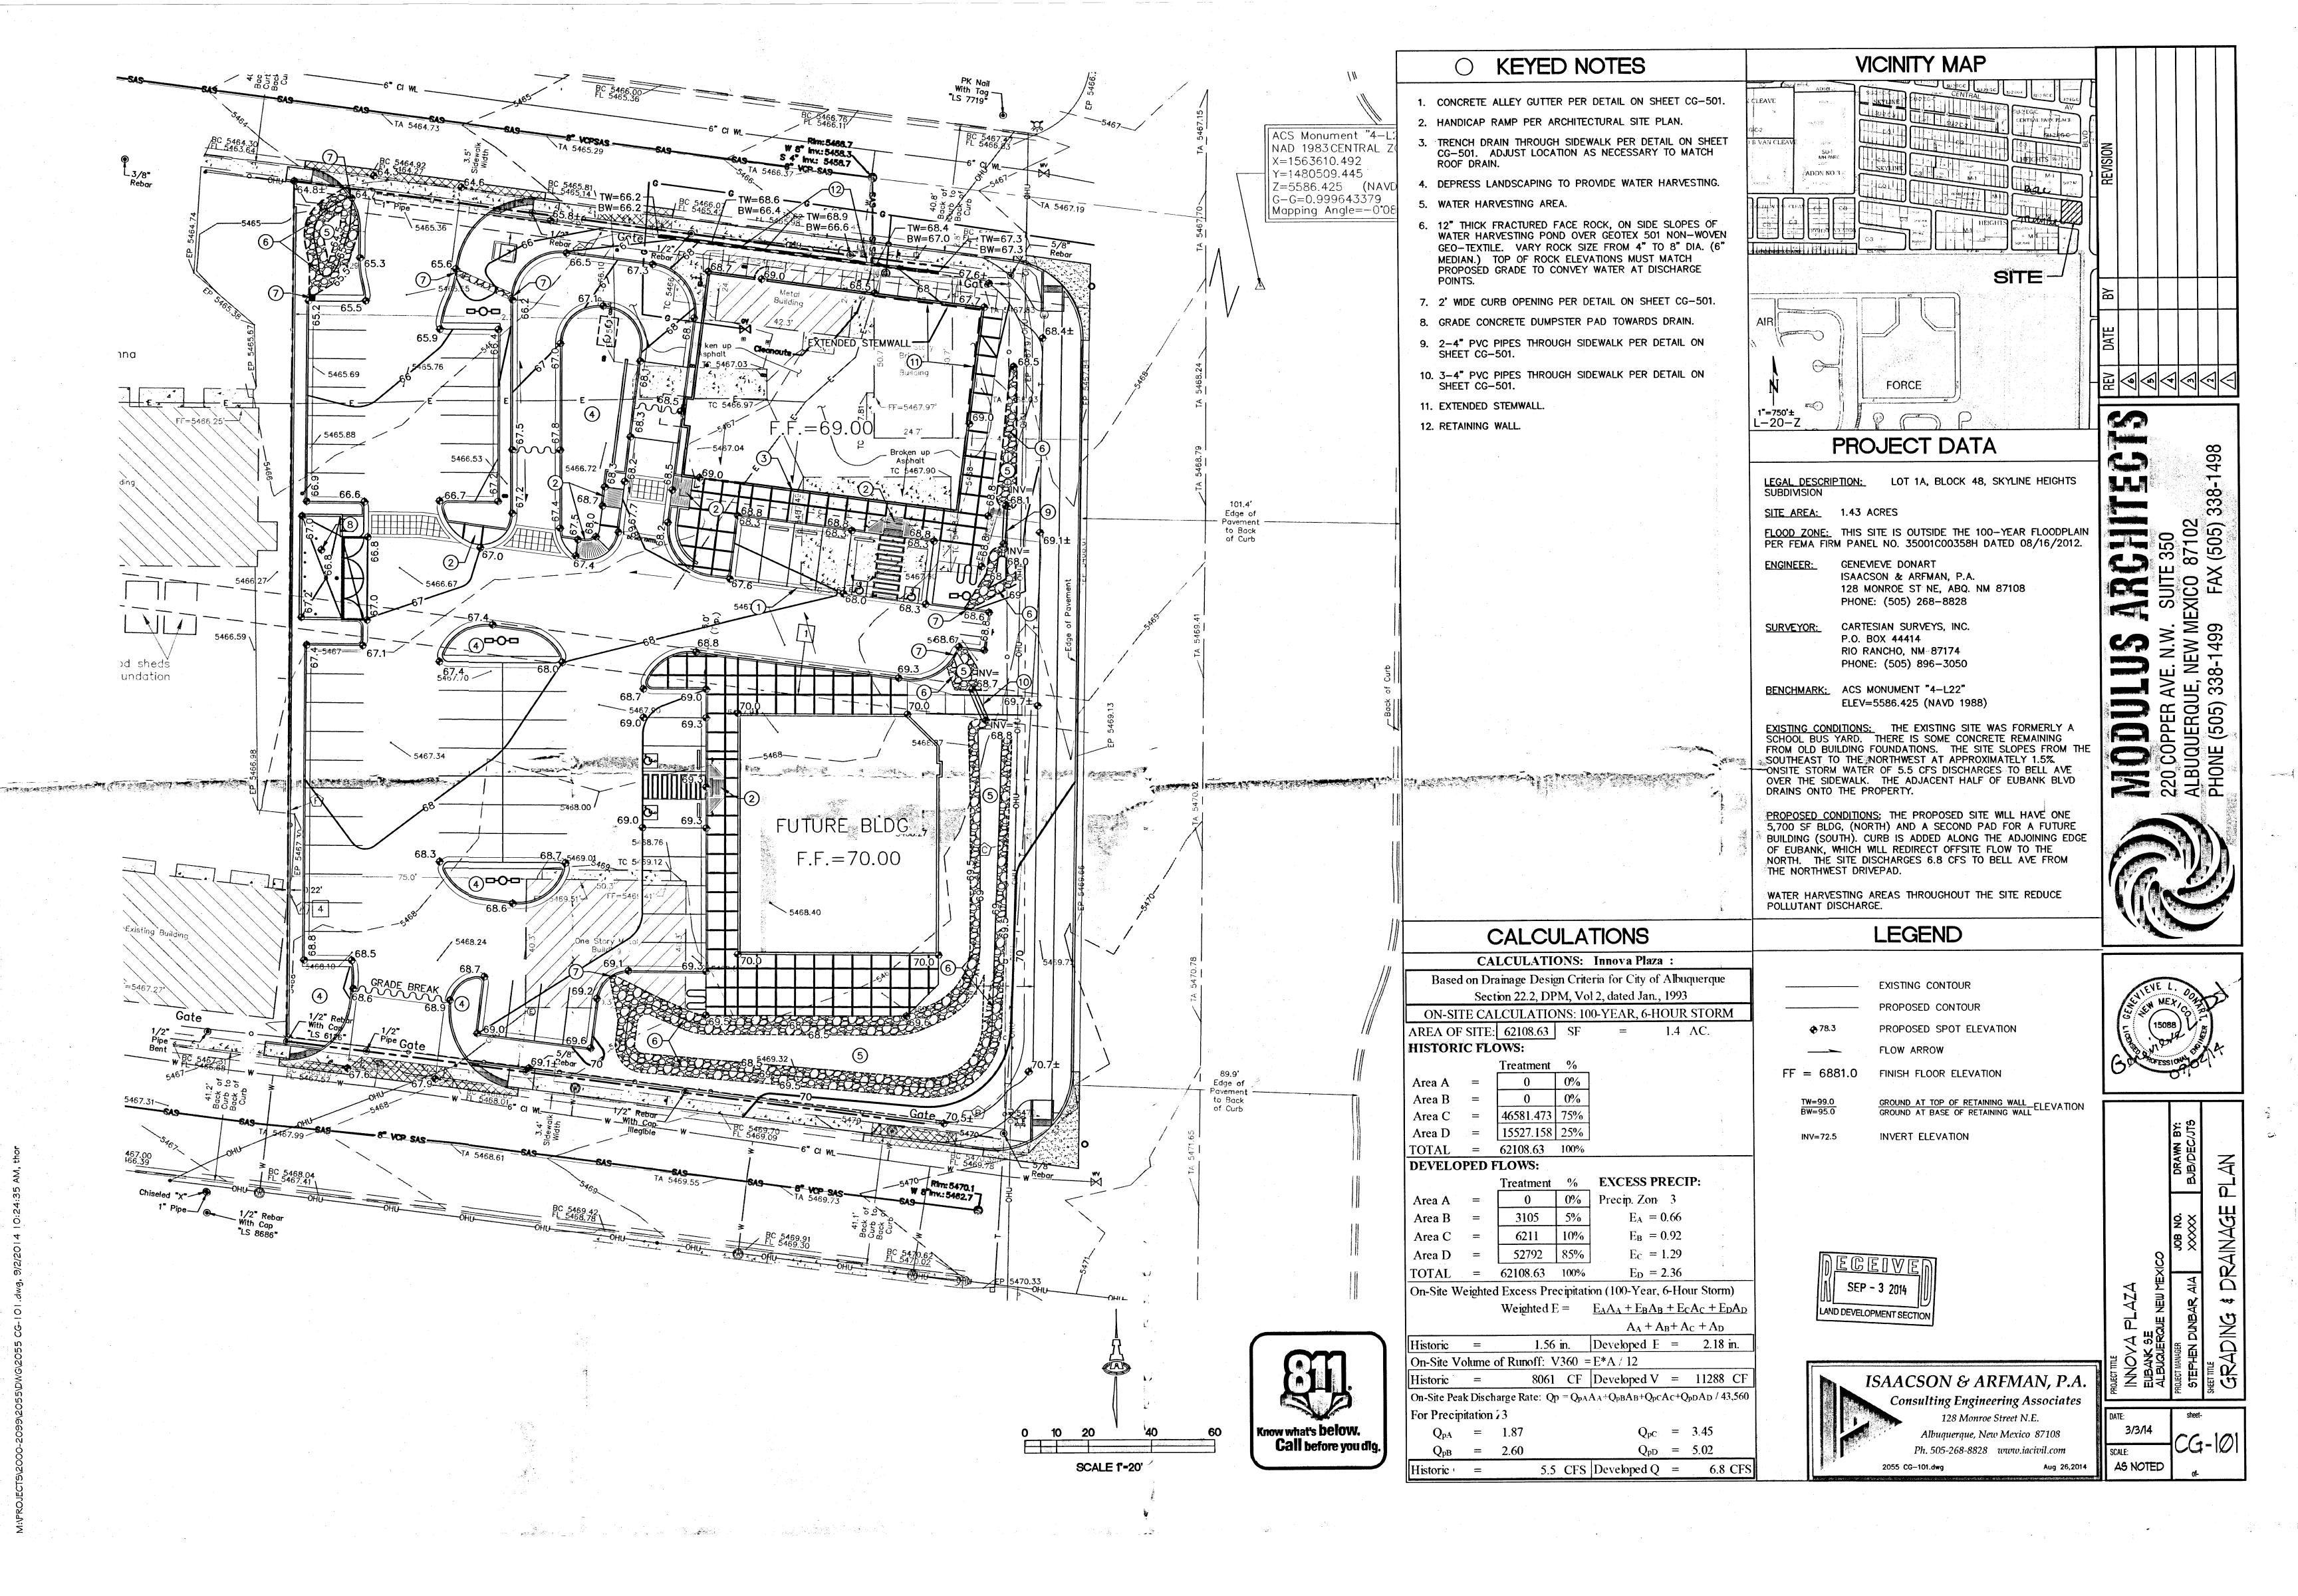

GENERAL NOTES

- 1. ALL WORK DETAILED ON THESE PLANS AND PERFORMED UNDER THIS CONTRACT SHALL BE CONSTRUCTED IN ACCORDANCE WITH THE PROJECT GEOTECHNICAL REPORT. WHERE APPLICABLE, CITY OF ALBUQUERQUE AND NMDOT STANDARDS APPLY
- 2. THE CONTRACTOR SHALL ABIDE BY ALL STATE, LOCAL, AND FEDERAL LAWS, CODES, RULES AND REGULATIONS WHICH APPLY TO THE CONSTRUCTION OF THESE IMPROVEMENTS, INCLUDING EPA AND ADA REQUIREMENTS.
- 3. ALL SUBGRADE, OVEREXCAVATION, BACKFILL, AND FILL SHALL BE PLACED AND / OR COMPACTED PER THE GEOTECHNICAL REPORT AND CITY OF ALBUQUERQUE SPECIFICATIONS.
- 4. THE CONTRACTOR SHALL OBTAIN ALL REQUIRED PERMITS FOR THE PROJECT PRIOR TO COMMENCING CONSTRUCTION, OR PRIOR TO OCCUPANCY. AS APPROPRIATE. IF PERMITS ARE DELAYED OR ISSUED WITH CONDITIONS, THE CONTRACTOR SHALL NOTIFY THE OWNER AND ARCHITECT
- 5. COORDINATE WORK WITH SITE PLAN, UTILITY PLAN, DEMOLITION PLAN, AND LANDSCAPE PLAN.
- 6. IT IS THE CONTRACTOR'S RESPONSIBILITY TO FIELD VERIFY HORIZONTAL AND VERTICAL LOCATIONS OF ALL EXISTING OBSTRUCTIONS, AND CONDITION OF ALL EXISTING INFRASTRUCTURE PRIOR TO CONSTRUCTION. REPORT ALL DISCREPANCIES TO THE ARCHITECT / ENGINEER AND VERIFY THE ARCHITECT / ENGINEER'S INTENT BEFORE PROCEEDING.
- 7. THE CONTRACTOR SHALL BE SOLELY RESPONSIBLE FOR SITE SAFETY.
- 8. THE CONTRACTOR SHALL MAINTAIN RECORD DRAWINGS ON SITE AT ALL TIMES. THE CONTRACTOR SHALL NOT SCALE DRAWINGS. ONLY WRITTEN DIMENSIONS OR KEYED NOTES SHALL BE USED.
- 9. CONTRACTOR SHALL OBTAIN ALL REQUIRED INSPECTIONS OF THE WORK. CONTRACTOR SHALL REGULARLY UPDATE OWNER AND ARCHITECT REGARDING THE STATUS OF THE INSPECTIONS.
- 10. CONSTRUCTION ACTIVITY SHALL BE LIMITED TO THE PROPERTY AND/OR PROJECT LIMITS. ANY DAMAGE TO ADJACENT STRUCTURES RESULTING FROM THE CONSTRUCTION PROCESS SHALL BE REPAIRED OR REPLACED AT THE CONTRACTOR'S EXPENSE. CONTRACTOR SHALL BE RESPONSIBLE FOR DOCUMENTING EXISTING CONDITIONS PRIOR TO CONSTRUCTION.
- 11. CONSTRUCTION EQUIPMENT SHALL NOT OBSTRUCT DRIVEWAYS. EQUIPMENT SHALL ONLY OBSTRUCT DESIGNATED TRAFFIC LANES IF APPROPRIATE BARRICADING PERMITS HAVE BEEN OBTAINED. THE CONTRACTOR SHALL NOT STORE ANY EQUIPMENT OR MATERIAL IN THE RIGHT-OF-WAY.
- 12. THE CONTRACTOR SHALL PROVIDE A CONSTRUCTION TRAFFIC CONTROL AND SIGNING PLAN THAT CONFORMS TO THE LATEST EDITION OF THE "MANUAL OF UNIFORM TRAFFIC CONTROL DEVICES" (MUTCD) AND LOCAL REQUIREMENTS. THE CONTRACTOR SHALL OBTAIN BARRICADING PERMITS FROM THE APPROPRIATE AUTHORITIES PRIOR TO ANY CONSTRUCTION WORK ON OR ADJACENT TO EXISTING STREETS.
- 13 THE CONTRACTOR SHALL MAINTAIN ALL BARRICADING AND CONSTRUCTION SIGNING AT ALL TIMES. THE CONTRACTOR SHALL VERIFY THE PROPER LOCATION OF ALL BARRICADING AT THE END AND BEGINNING OF EACH DAY.

- 14. EXISTING UTILITY LINES ARE SHOWN IN AN APPROXIMATE MANNER ONLY AND MAY BE INCOMPLETE OR OBSOLETE. SUCH LINES MAY OR MAY NOT EXIST WHERE SHOWN OR NOT SHOWN, CONTRACTOR SHALL CONTACT NM-811 FOR UTILITY LINE SPOTS TWO WORKING DAYS PRIOR TO CONDUCTING SITE FIELD WORK. CONTRACTOR SHALL FIELD VERIFY AND LOCATE ALL UTILITIES PRIOR TO COMMENCEMENT OF ANY CONSTRUCTION. CONTRACTOR IS FULLY RESPONSIBLE FOR ANY AND ALL DAMAGE CAUSED BY ITS FAILURE TO LOCATE, IDENTIFY AND PRESERVE ANY AND ALL EXISTING UTILITIES, PIPELINES, AND UNDERGROUND UTILITY LINES. THE CONTRACTOR SHALL BE RESPONSIBLE FOR COORDINATION OF NECESSARY DRY UTILITY ADJUSTMENTS.
- 15. SOIL TESTING AND INSPECTION SERVICES DURING EARTHWORK OPERATIONS ARE REQUIRED. CONTRACTOR SHALL ALLOW TESTING LABS TO INSPECT AND APPROVE COMPACTED SUBGRADES, BACKFILL, AND FILL LAYERS BEFORE FURTHER CONSTRUCTION WORK IS DONE. SHOULD COMPACTION TESTS INDICATE INADEQUATE DENSITY, CONTRACTOR SHALL PROVIDE ADDITIONAL COMPACTION AND TESTING AT THE CONTRACTOR'S SOLE EXPENSE.
- 16. CONTRACTOR SHALL PROVIDE ALL OTHER CONSTRUCTION STAKING. CONTRACTOR SHALL LOCATE AND PRESERVE ALL BOUNDARY CORNERS AND REPLACE ANY LOST OR DISTURBED CORNERS AT CONTRACTOR'S SOLE EXPENSE. PROPERTY CORNERS SHALL ONLY BE RESET BY A REGISTERED LAND SURVEYOR.
- 17. CONTRACTOR SHALL COMPLY WITH LOCAL REGULATIONS FOR RESEEDING OF DISTURBED AREAS.
- 18. A CURRENT STORMWATER CONTROL PERMIT, INCLUDING AN FROSION SEDIMENT CONTROL PLAN (E.S.C.)FOR EROSION AND SEDIMENT CONTROL IS REQUIRED FOR ALL CONSTRUCTION, DEMOLITION CLEARING, AND GRADING OPERATIONS THAT DISTURB THE SOIL ON ONE ACRE OR MORE OF LAND. OWNER WILL COORDINATE.
- 19. POST-CONSTRUCTION MAINTENANCE FOR PRIVATE STORMWATER FACILITIES WILL BE THE RESPONSIBLITY OF THE FACILITIES OWNER. PERIODIC INSPECTION AND CERTIFICATIONS OF THE FACILITIES MAY BE REQUIRED BY THE CITY ENGINEER.
- 20. ALL SITE PREPARATION, GRADING OPERATIONS, FOUNDATION CONSTRUCTION. AND PAVEMENT INSTALLATION WORK SHALL BE CONSTRUCTED IN ACCORDANCE WITH THE GEOTECHNICAL REPORT, WHICH WILL BE PROVIDED BY THE OWNER OR ARCHITECT. ALL OTHER WORK SHALL, UNLESS OTHERWISE NOTED IN THE PLANS, BE CONSTRUCTED IN ACCORDANCE WITH THE PROJECT SPECIFICATION (FIRST PRIORITY), AND/OR NMDOT STANDARD SPECIFICATIONS FOR PUBLIC WORK (SECOND PRIORITY.)


GRADING GENERAL NOTES

- 1. PAVEMENT GRADES IN MARKED HANDICAPPED PARKING AREAS SHALL NOT EXCEED 2.0% IN ANY DIRECTION. FOR ALL ACCESSIBLE ROUTES, MAXIMUM ALLOWABLE CROSS SLOPE IS 2.0% AND MAXIMUM LONGITUDINAL SLOPE WITHOUT RAMP IS 5.0%. FOLLOW ALL ADA ACCESSIBILITY GUIDELINES OR CITY CODES, WHICHEVER IS MORE STRINGENT.
- 2. ALL TRASH, DEBRIS, & SURFACE VEGETATION SHALL BE CLEARED AND LEGALLY DISPOSED OF OFFSITE.
- 3. PROPOSED SPOT AND CONTOUR ELEVATIONS SHOWN REPRESENT TOP OF FINISH MATERIAL (I.E. TOP OF CONCRETE, TOP OF CONCRETE BUILDING PAD, TOP OF PAVEMENT MATERIAL, TOP OF LANDSCAPING MATERIAL, ETC.). CONTRACTOR SHALL GRADE, COMPACT SUBGRADE AND DETERMINE EARTHWORK ESTIMATES BASED ON ELEVATIONS SHOWN MINUS FINISH MATERIAL THICKNESSES.
- 4. IF FIELD GRADE ADJUSTMENTS ARE REQUIRED, THE CONTRACTOR SHALL NOTIFY THE ARCHITECT/ENGINEER.
- 5. MINIMUM SLOPES SHALL BE 1% UNLESS OTHERWISE NOTED.

6. STORMWATER CONTROL MEASURES SHOWN ON THIS PLAN

- ARE REQUIRED TO PROVIDE MANAGEMENT OF 'FIRST FLUSH' (DEFINED AS THE 90TH PERCENTILE STORM EVENT OR 0.44" OF STORMWATER WHICH DISCHARGES DIRECTLY TO A PUBLIC STORM DRAINAGE SYSTEM).
- MEASURES REQUIRED FOR EROSION AND SEDIMENT CONTROL SHALL BE INCIDENTAL TO THE PROJECT COST.
- 8. ADJUST ANY RIMS OF EXISTING UTILITY FEATURES AS NECESSARY TO MATCH NEW GRADES. UTILITIES IN PAVED AREAS SHALL BE HS-25 TRAFFIC RATED.
- 9. ALL NEW PAVEMENT SURFACES SHALL BE CONSTRUCTED WITH POSITIVE SLOPE AWAY FROM BUILDINGS AND POSITIVE SLOPE TOWARD EXISTING AND/OR PROPOSED DRAINAGE PATHS. PAVING AND ROADWAY GRADES SHALL BE ±0.1' FROM PLAN ELEVATIONS. BUILDING PAD ELEVATION SHALL BE ± 0.05 ' FROM PLAN ELEVATION.
- 10. WHERE GRADES BETWEEN NEW AND EXISTING ARE SHOWN AS 'MATCH' OR '±', TRANSITIONS SHALL BE SMOOTH.
- 11. ALL FRACTURED FACE ROCK (F.F. ROCK) TO BE 6" AVG. DIA. ANGULAR FACED ROCK PLACED OVER GEOTEX 501 NON-WOVEN GEOTEXTILE (O.E.) NOTE: PERMANENT TURF REINFORCEMENT MATERIAL (LANDLOK TRM 450 O.E.) MAY BE SUBSTITUTED AT ALL AREAS REFERENCING F.F. ROCK EROSION PROTECTION.
- 12. ENGINEER RECOMMENDS THAT OWNER MAINTAIN EROSION PROTECTION ELEMENTS. ENGINEER RECOMMENDS THAT OWNER INSPECT SITE YEARLY AND AFTER EACH RAINFALL TO IDENTIFY NEW AREAS OF EROSION AND INSTALL ADDITIONAL EROSION PROTECTION AS NEEDED BASED ON ACTUAL OCCURRENCES.

13. GRADING SHALL BE PERFORMED AT THE ELEVATIONS AND IN ACCORDANCE WITH THE DETAILS SHOWN ON THIS PLAN.

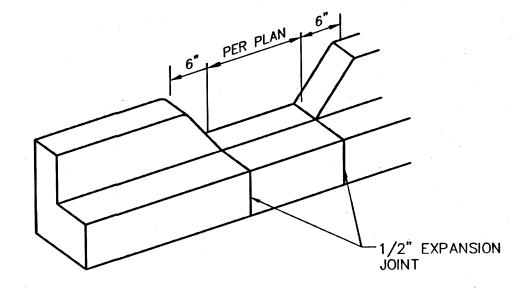


GENERAL_NOTES

1. EDGES NOT SPECIFICALLY DIMENSIONED SHALL BE SHAPED WITH A 3/8" EDGING TOOL.



Maria Caracian Comment of the Commen

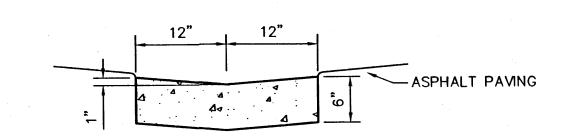


GENERAL NOTES

- 1. EDGES SHALL BE SHAPED WITH A 3/8" EDGING TOOL. 2. CONSTRUCTION CONTROL JOINTS AT 6' O.C. MAX.
- 3. 1/2" EXPANSION JOINTS 48' O.C., CURB RETURNS AND EACH SIDE OF DRIVES. SEAL WITH ____
- 4. EDGE OF ASPHALT PAVING TO BE 1" ABOVE EDGE OF CONCRETE (TYP).


CONCRETE ALLEY GUTTER


SCALE: N.T.S.

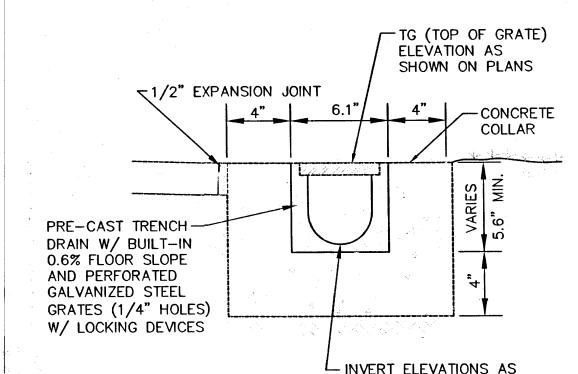


SHOWN ON PLANS NOTE: TRENCH DRAIN SYSTEM BY ACO POLYMER PRODUCTS, OR APPROVED EQUAL.

TRENCH DRAIN THROUGH SIDEWALK

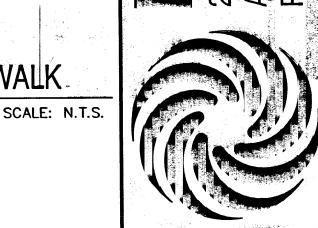


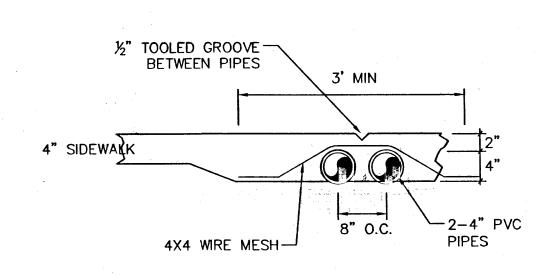

4" PIPES THROUGH WALK SCALE: N.T.S.

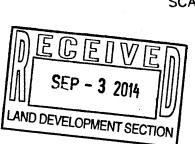


ISAACSON & ARFMAN, P.A. Consulting Engineering Associates 128 Monroe Street N.E. Albuquerque, New Mexico 87108 Ph. 505-268-8828 www.iacivil.com

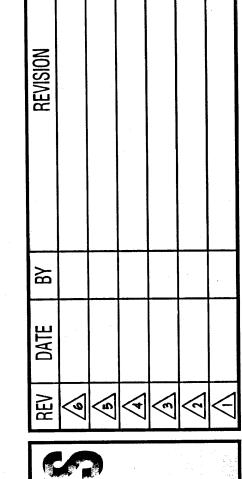

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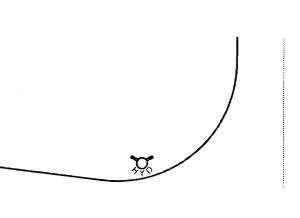


AS NOTED

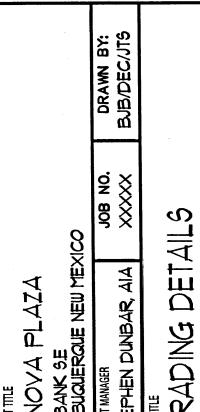ARCHITECT **RBA Architecture** 110 4 Park Ave. SW **ELECTRICAL**

MECHANICAL DSL ASSOCIATES 299 Garcia Rd. NW ALBUQUERQUE, NM 87114 Albuquerque, NM 87114 (505) 980-0238

CONTRACTOR KIMCON INC. 405 DARTMOUTH SE ALBUQUERQUE, NM 87106






SOUTHWEST RENDERING


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- 2. ASPHALT PAVEMENT ON BASE COURSE, SEE DETAIL: 05/C-2
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- 4. CONSTRUCT CONCRETE SIDEWALK.
- 4" WIDE WHITE PARKING STRIPE AS SHOWN, PER LOCAL CITY CODE AND STANDARDS.


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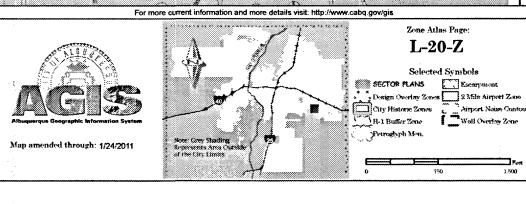
- 6. HANDICAP ACCESSIBLE AISLE STRIPPING PER LOCAL CITY CODE AND STANDARDS.
- INTERNATIONAL SYMBOL OF ACCESSIBILITY, CENTER IN PARKING SPACE.
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- 13. SITE LIGHT WITH CONCRETE BASE, REF: ELECTRICAL FOR DETAILS.
- 14. SIGNAGE, BY OWNER, INSTALLED BY OWNER.
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- 18. 6'-0" HIGH CMU WALL, SEE DETAIL 1/C1 (THIS SHEET) 19. 4'-0" HIGH CMU WALL, SEE DETAIL 1/C1 (THIS SHEET)
- 20. 19'-0' HIGH MONUMENT SIGN SEE ATTACHED ELEVATIONS FROM ZEON SIGNS

Repart => DRB



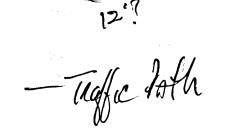

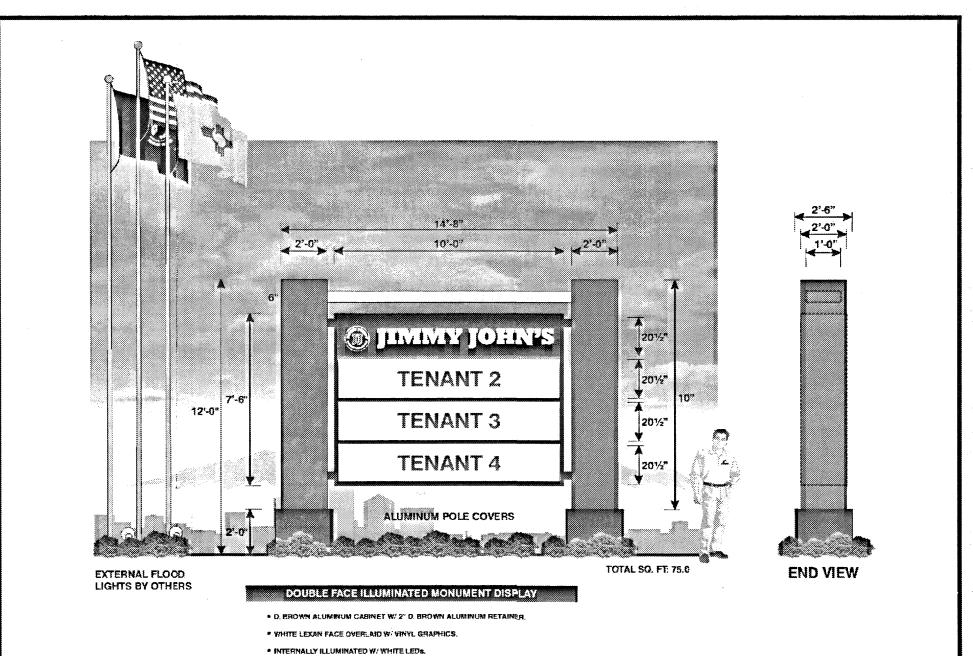

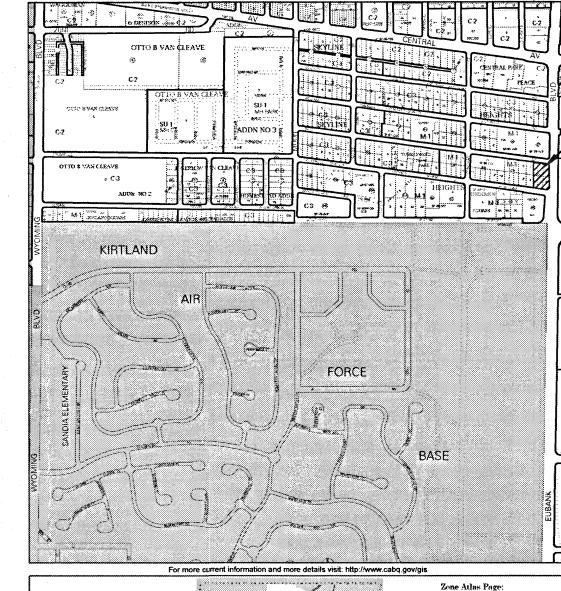





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		M-2	
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CG-501	GRADING DETAILS	M-4	
CU-101	UTILITY PLAN	M-5	= =:: ::=
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S-1.0	FOUNDATION PLAN		
S-1.2	FOUNDATION DETAILS		
S-2.0	ROOF FRAMINGPLAN	1.13	

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- THE STREET OR ROAD FRONTING THE PROPERTY. PROPOSED BUILDING TO HAVE FIRE SPRINKLER SYSTEM THROUGHOUT PER 2009

ACCORDANCE WITH UL 1037, AND SHALL CONTAIN KEYS TO GAIN ACCESS TO

- I.B.C. SECTION 903 AND MANUAL FIRE ALARM SYSTEM PER SECTION 907. FIRE SPRINKLER SYSTEM PLANS TO BE SUBMITTED UNDER SEPARATE PERMIT. G.C. TO PROVIDE KEY BOX, KEY BOX TO BE INSTALLED IN AN ACCESSIBLE LOCATION. THE KEY BOX SHALL BE OF AN APPROVED TYPE LISTED IN
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DESIGN CRITERIA

MAXIMUM BUILDING HEIGHT: MINIMUM BUILDING SETBACKS:

= 32' BUILDING HEIGHT = 5' PER COA 14-16-2-15(E) **EAST** = 35' PER COORS CORRIDOR PLAN = 5' PER COA 14-16-2-15(E)

SIGNAGE: ALL SIGNAGE SHALL COMPLY WITH THE C-1 COMMERCIAL ZONE AND THE COORS CORRIDOR SIGNAGE REGULATION. ANY SIGN WITH MOVING ELEMENTS OR FLASHING LIGHTS, INCLUDING ELECTRONIC SIGNS ARE NOT PERMITTED. SHADES AND INTERNAL IMAGES THAT MEET THE DEFINITION OF A SIGN ARE NOT PERMITTED. FUTURE TENANT SIGNAGE IS LIMITED TO A MAXIMUM OF 8 ADDITIONAL WORDS OR ITEMS OF INFORMATION, PER STREET FRONTAGE.

	i
PARKING CALCULATIONS	
PARKING REQUIRED:	PROVIDED:
PER C.O.A. ZONING 14-16-3-1 (27) (RETAIL) 10,010 SF (GROSS) FIRST FLOOR/200 = 50 SPACES	
TOTAL PARKING REQUIRED: =50 SPACES	57 SPACES
PARKING REDUCTIONS: PER C.O.A. 14-16-3-1 (E) 6a TRANSIT REDUCTIONS 10% REDUCTION IF PROPERTY IS LOCATED WITHIN 300' OF TRANSIT ROUTE.	
PARKING REQUIRED AFTER TRANSIT REDUCTIONS (AT 10%) = 45 SPACES	57 SPACES
PER C.O.A. ZONING 14-16-3-1(c)1 MOTORCYCLE PARKING REQUIRED = 2 SPACES	3 SPACES
PER C.O.A. ZONING 14-16-3-1(F)9a HANDICAP PARKING REQUIRED = 3 (1 VAN)	4 (2 VAN)
PER C.O.A. ZONING 14-16-3-1 (B)3 BICYCLE SPACES 1 PER 20 VEHICLES REQUIRED = 3 SPACES	8 + SPACES

REVISION DATE

DATE 02-19-2015

SHEET NUMBER

P.O. BOX 1111

OWNER **DOUG ADAMS** GLAD LLC CEDAR CREST, NM 87008

Albuquerque, NM 87102 505-242-1859

NORTHRIDGE ELEC. 328 RANCHITOS NW (505) 898-7245

(505) 620-4993

BELL AVENUE

RETAIL SPACE SPACE 1,200 S.F. 18'-0" 15'-0'" 22'-8 1/2" SPACE (c) 2,000 S.F.

ADJACENT

BUILDING

20'-0'" 20'-0'"

(SEPERATE PERMIT)

3,500 S.F.

40'-0'" PHASE 2

ADJACENT BUILDING

TRUMBULL AVENUE SE

(IN FEET)

BAR SCALE


C-1.0

ARCHITECT RBA Architecture 110 4 Park Ave. SW Albuquerque, NM 87102 505-242-1859

ELECTRICAL NORTHRIDGE ELEC. 328 RANCHITOS NW ALBUQUERQUE, NM 87114 Albuquerque, NM 87114 (505) 898-7245

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SOUTHWEST RENDERING

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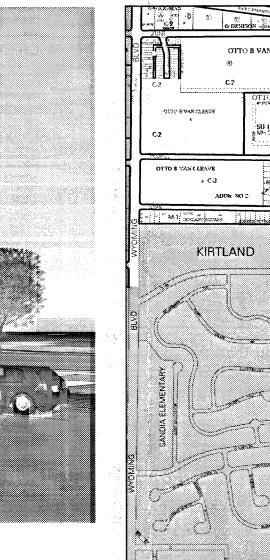
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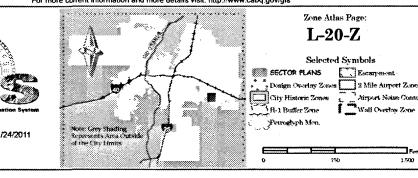
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ROOF PLAN ROOF DETAILS A-6.1 BUILDING SECTIONS A-9.0 WALL SECTIONS

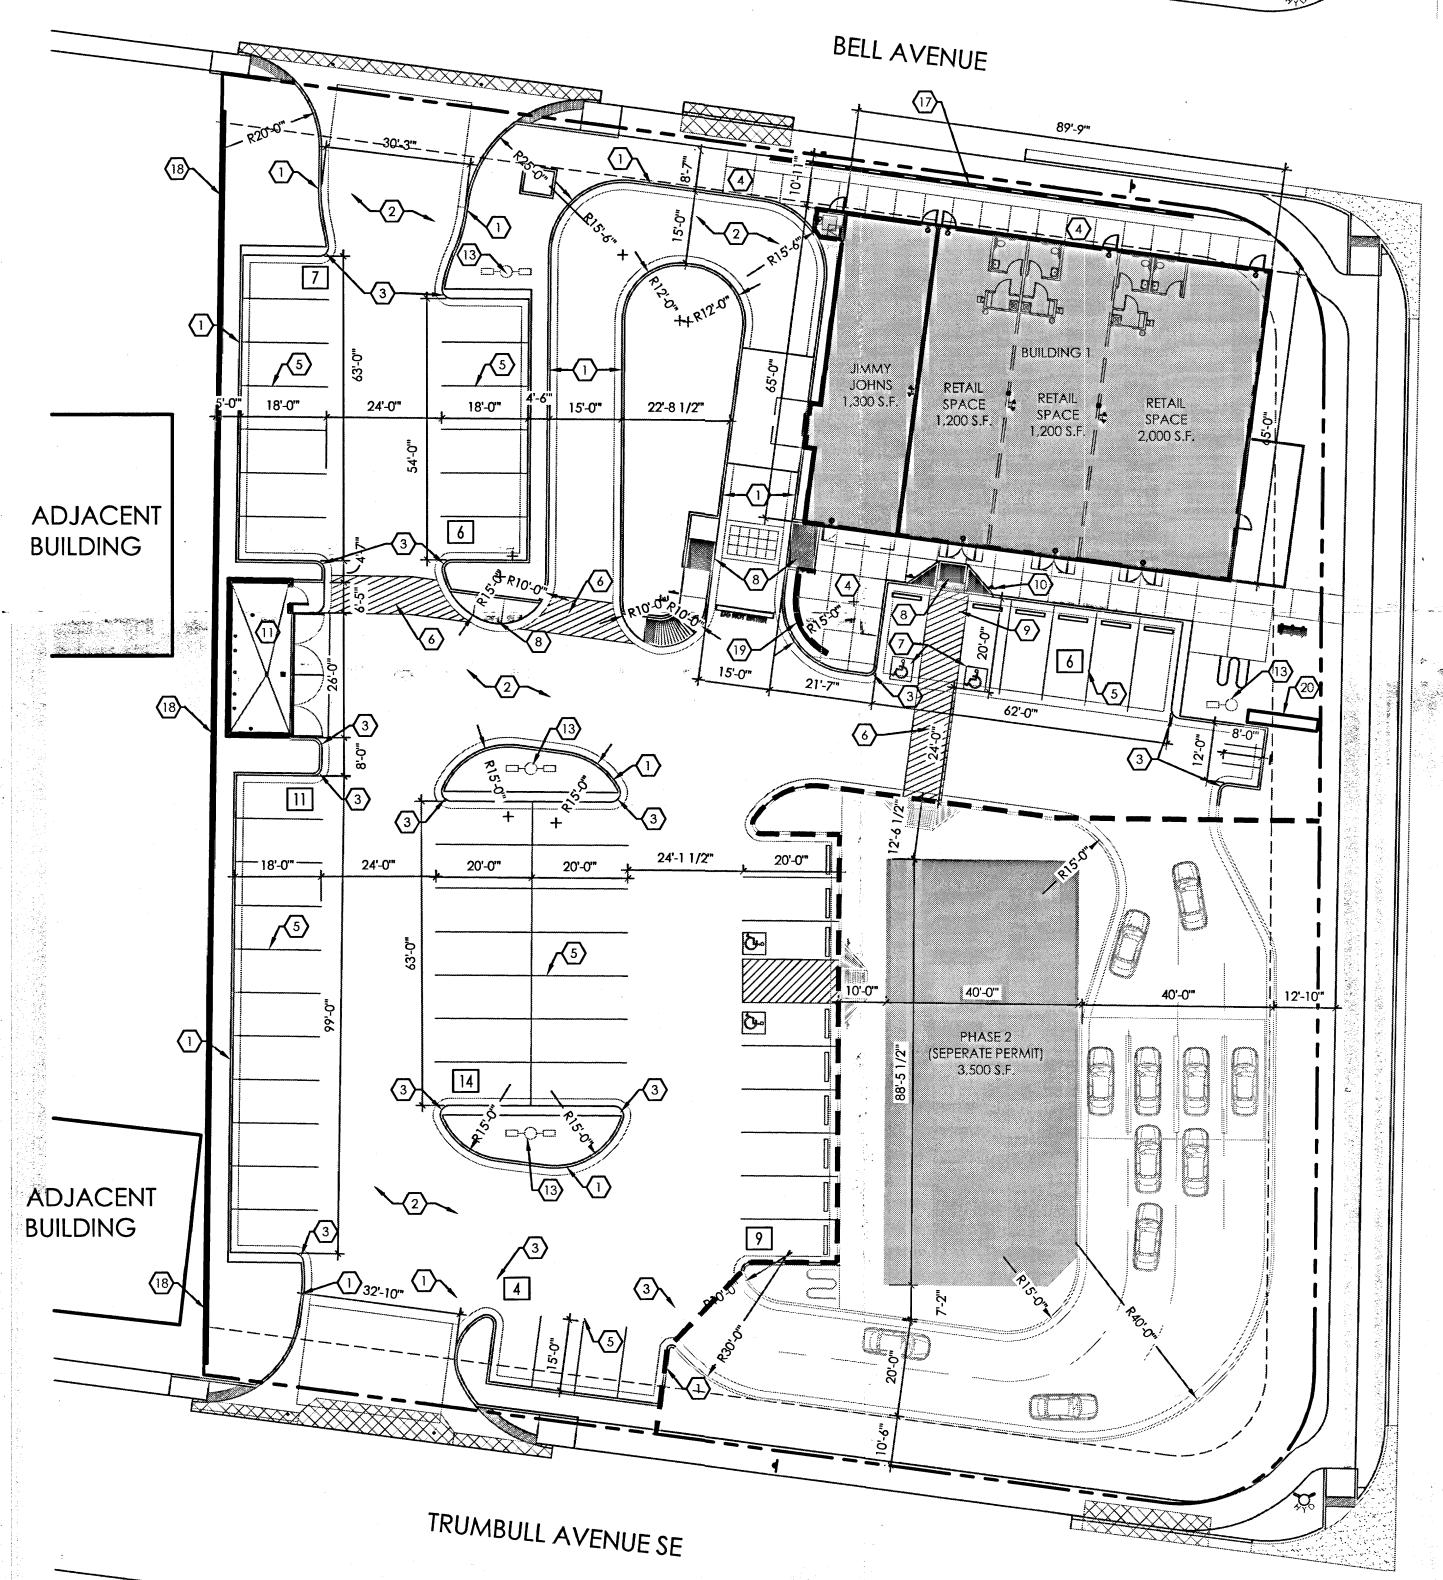WALL SECTIONS FOUNDATION PLAN FOUNDATION DETAILS S-1.2 ROOF FRAMINGPLAN

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E-4 SITE PLAN

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DATE 02-19-2015

SHEET NUMBER

C-1.0

REVISION DATE

BAR SCALE (IN FEET)

