CITY OF ALBUQUERQUE

Planning Department
Brennon Williams, Director



March 27, 2020

Shawn Biazar SBS Construction and Engineering 10209 Snowflake Ct. NW Albuquerque, NM 87114

RE: 601 Winterwood SE

Request for Pad Certification - Approved

Grading Plan Stamp Date: 2/10/20 Certification Dated: 3/19/20

Drainage File: L23D032

Dear Mr. Biazar:

PO Box 1293 Based on the submittal received on 3/23/20, this certification is approved for Building Permit.

If you have any questions, please contact me at 924-3986 or earmijo@cabq.gov.

Albuquerque

Sincerely,

NM 87103

www.cabq.gov Ernest Armijo, P.E.

Principal Engineer, Planning Dept. Development Review Services



City of Albuquerque

Planning Department

Development & Building Services Division

DRAINAGE AND TRANSPORTATION INFORMATION SHEET (REV 6/2018)

Project Title: 601 WINTERWOOD PL., SE GRAIN	IG PLAN Building Permit #:	Hydrology File #: L23D032
DRB#:	EPC#:	Work Order#:
Legal Description: LOT 9, UNIT 4, EX	ECUTIVE HILLS SUBDIVISION	
City Address: 601 WINTERWOOD PL., SE		
Applicant: SBS CONSTRUCTION ANI	D ENGINEEING, LLC	Contact: SHAWN BIAZAR
Address: 10209 SNOWFLAKE CT., NW	/, ALBUQUERQUE, NM 87114	
Phone#: (505) 804-5013	Fax#: (505) 897-4996	E-mail: AECLLC@AOL.COM
Other Contact:		Contact:
Address:		
		E-mail:
TYPE OF DEVEL OPMENT:	PLAT (# of lots) V RESIDENCE	DRB SITEADMIN SITE
THE OF BEVELOTMENT.	EM (" of lots) RESIDENCE	DRD SITERDWIN SITE
IS THIS A RESUBMITTAL?	Yes X No	
DEPARTMENT TRANSPORTAT	ION X HYDROLOGY/DRAI	NAGE
Check all that Apply: TYPE OF SUBMITTAL: ENGINEER/ARCHITECT CERTIFIC X PAD CERTIFICATION CONCEPTUAL G & D PLAN X GRADING PLAN DRAINAGE REPORT DRAINAGE MASTER PLAN FLOODPLAIN DEVELOPMENT PER ELEVATION CERTIFICATE CLOMR/LOMR TRAFFIC CIRCULATION LAYOUT TRAFFIC IMPACT STUDY (TIS) STREET LIGHT LAYOUT OTHER (SPECIFY) PRE-DESIGN MEETING?		PPROVAL/ACCEPTANCE SOUGHT: ING PERMIT APPROVAL FICATE OF OCCUPANCY MINARY PLAT APPROVAL LAN FOR SUB'D APPROVAL LAN FOR BLDG. PERMIT APPROVAL PLAT APPROVAL ELEASE OF FINANCIAL GUARANTEE DATION PERMIT APPROVAL ING PERMIT APPROVAL APPROVAL G PERMIT APPROVAL ING/PAD CERTIFICATION ORDER APPROVAL R/LOMR
		OPLAIN DEVELOPMENT PERMIT R (SPECIFY)

FEE PAID:_____

RUNOFF CALCULATIONS FOR 100 YEAR/6 HOUR STORM

BASIN	AREA	(SF)	AREA	(AC)	AREA	(MI ²)
ON-SITE	12,38	4.00	0.28	843	0.000	44421

E = EA(AA) + EB(AB) + EC(AC) + ED(AD)AA + AB + AC + AD

V-360 = Weighted E (AA + AB + AC + AD)/12

EA = 0.80EB = 1.08EC = 1.46ED = 2.64

LAND TREATMENT DEVELOPED CONDITION

AB = 20.00%AC = 20.00%AD = 60.00%

AA = 0.00%

DEVELOPED Weighted E = 2.09

V360 (DEVELOPED) = 2,253.69 CF

A = 2.20 CFS/ACB = 2.92 CFS/ACC = 3.73 CFS/ACD = 5.25 CFS/AC

TOTAL QP = QPA AA + QPB AB + QPC AC + QPD ADQP (DEVELOPED) = 1.33 CFS

Location

This site is located at 601 Winterwood PL SE, Albuquerque and contains 0.2843 acre. See attached portion of Vicinity Map for exact location.

The purpose of this drainage report is to present a grading and drainage solution

Existing Drainage Conditions

The site for the most part drains south to Winterwood place, SE (22' Private access, drainage, and utility easement), lot 8 and drains into existing concrete channel to the bottom of the arroyo. Small portion of the runoff drains to Four Hills Road and very small portion drains north and finally into the arroyo.

Proposed Conditions and On-Site Drainage Management Plan

The drainage pattern will remain the same as existing conditions. Most of the site drains to lot 8 into the drainage easement and finally drains to existing concrete channel on lot 8. the small portion still will drain into Four Hills Road and a portion to the north. There are no offsite runoff.

Calculations

City of Albuquerque, Development Process Manuel, Section 22.2, Hydrology Section, was used for runoff calculations. See this plan for runoff calculation.

X18.35

X18.03

LOT 8

EXIST. CONC.


EE DRAINAGE CONTINUATION
O CONCRETE CHANNEL ON LOT 8


× 5534.10


X17.75

GENERAL NOTES:

- 1: CONTOUR INTERVAL IS HALF (1.00) FOOT.
- 2: UTILITIES SHOWN HEREON ARE IN THEIR APPROXIMATE LOCATION BASED ONLY ON ABOVE GROUND EVIDENCE FOUND IN THE FIELD AND AS-BUILT INFORMATION PROVIDED BY THE CLIENT. UTILITIES SHOWN HEREON, WHETHER INDICATED AS ABANDONED OR NOT, SHALL BE VERIFIED BY OTHERS FOR EXACT LOCATION AND / OR DEPTH PRIOR TO EXCAVATION OR DESIGN CON-
- 3: THIS IS <u>NOT</u> A BOUNDARY SURVEY, BEARINGS ARE ASSUMED, DISTANCES AND FOUND PROPERTY CORNERS ARE FOR <u>INFORMATIONAL</u> PURPOSES ONLY.
- 4: SLOPES ARE AT 3:1 MAXIMUM.
- 5: ELEVATIONS ARE BASED ON CITY OF ALBUQUERQUE CONTROL STATION CANDELARIA, HAVING AN ELEVATION OF 5090.846 FEET ABOVE SEA LEVEL.
- 6: ADD 5600 TO ALL PROPOSED SPOT ELEVATIONS.

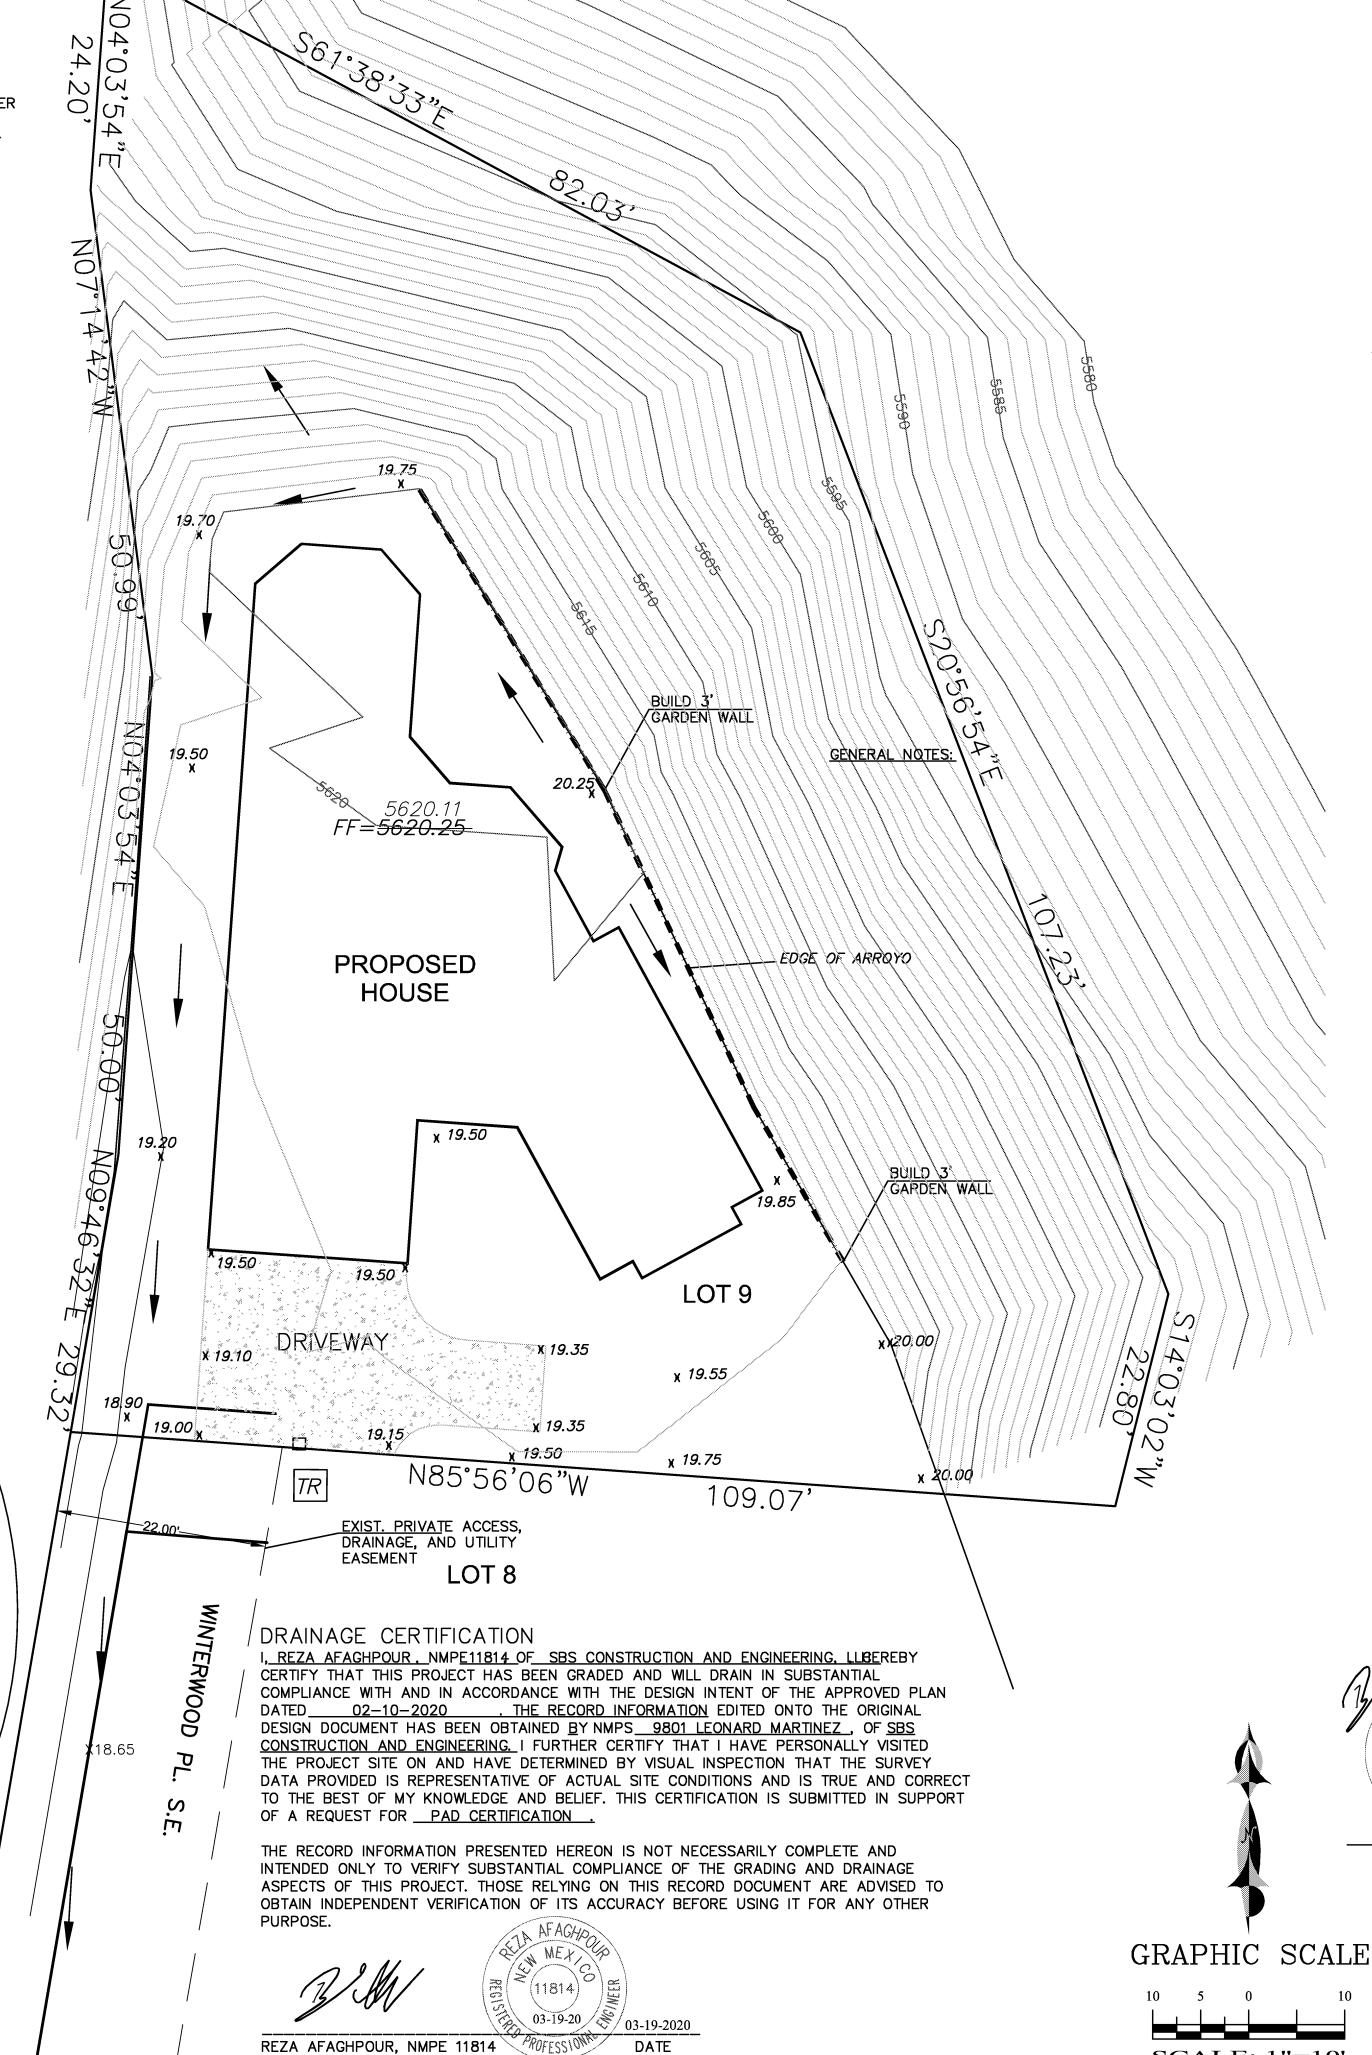

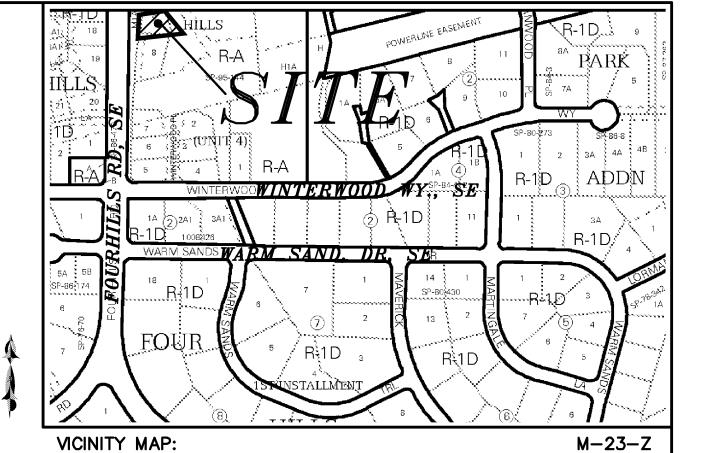

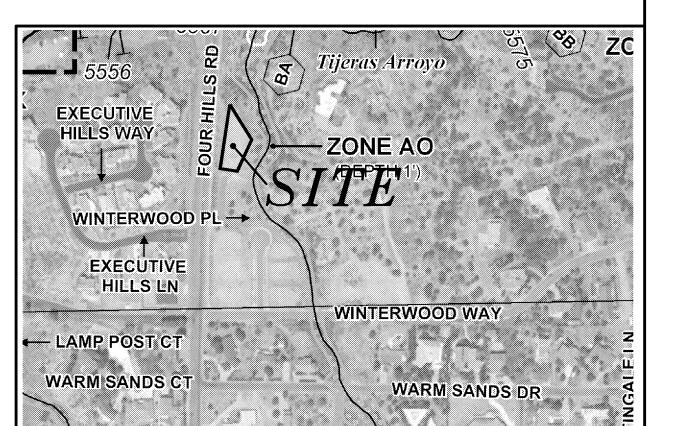

FIRM MAP: EFFECTIVE DATE:

35001C0368G 09-26-2008


LEGAL DESCRIPTION:

LT 9 CORRECTED PLAT OF EXECUTIVE HILLS SUBDIVISION, UNIT 4, CONTAINING 0.2843 AC OR 12,384 SF

ADDRESS: 601 WINTERWOOD PL SE, ALBUQUERQUE

LEGEND

	BOUNDARY LINE
	EASEMENT LINE
******EXISTING SAS*******	EXISTING SEWER
EXISTING SD	EXISTING STORM DRAIN
	EXISTING CURB & GUTTER
	CHAIN LINK FENCE
	EXISTING SIDEWALK
Ą	EXISTING FIRE HYDRANT
O	EXISTING WATER SERVICE
	EXISTING DROP INLET
	PROPOSED RETAINING WALL
	PROPOSED EXTENDED STEM WALL
TRW=38.00 TF=32.00	TOP OF RETAINING WALL TOP OF FOOTING
TSW=34.00	TOP OF EXTENDED STEM WALL
X18.35	EXISTING ELEVATION

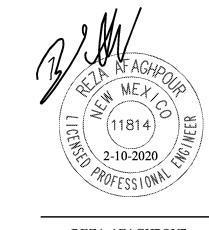

P.E. #11814

AND ENGINEERING, LLC REZA AFAGHPOUR

10209 SNOWFLAKE CT., NW ALBUQUERQUE, NEW MEXICO 87114 (505)899-5570

SBS CONSTRUCTION

SCALE: 1"=10'

601 WINTERWOOD PL., SE **GRADING PLAN**

DRAWING:	G: DRAWN BY:	DATE:	SHEET#	
201931-GD.DWG	D.DWG SBR	2/10/2020	1	