# CITY OF ALBUQUERQUE

Planning Department Alan Varela, Director



Mayor Timothy M. Keller

March 19, 2025

Ronald Bohannan, P.E Tierra West, LLC 5571 Midway Park PI NE Albuquerque, NM 87109

Re: Sage Plaza Storage 9850 De Vargas Rd SW 30-Day Temporary Certificate of Occupancy Transportation Development Final Inspection Engineer's Stamp dated 01-31-24 (M09-D012B) Certification dated 03-12-2025

Dear Mr. Bohannan,

Based upon the information provided in your submittal received 03-17-25, Transportation Development has no objection to a <u>30-day Temporary Certificate of Occupancy</u> based. This letter serves as a "green tag" from Transportation Development for a <u>30-day Temporary Certificate of Occupancy</u> to be issued by the Building and Safety Division.

Prior to the issuance of a permanent Certificate of Occupancy, the following items must be addressed:

Albuquerque

PO Box 1293

- Complete site construction, and remove fencing from the site.
- <sup>NM 87103</sup> Once these corrections are complete, email pictures to <u>malnajjar@cabq.gov</u> for release of Final CO.

If you have any questions, please contact me at (505) 924-3675.

www.cabq.gov

Sincerely,

Maria

Marwa Al-najjar Associate Engineer, Planning Dept. Development Review Services



### MARCH 12, 2025

Marwa Al-najjar Development Review Services City of Albuquerque P.O. Box 1293 Albuquerque, NM 87103

### RE: AA APPROVED TRAFFIC CIRCULATION LAYOUT REQUEST FOR TEMPORARY CERTIFICATE OF OCCUPANCY 9850 DE VARGAS RD SW ALBUQUERQUE NM 87121

I, Ronald R. Bohannan, NMPE #7868, of the firm Tierra West LLC, hereby request approval of the asbuilt Approved Traffic Circulation Layout for issuance of a Permanent Certificate of Occupancy for the project referenced above. This project area as highlighted on the attached site plan is in substantial compliance as inspected on March 3rd, 2025, and is in general accordance with the design intent of the Approved Site Plan dated 01/31/24.

The record information presented hereon is not necessarily complete and intended only to verify substantial compliance of the traffic aspects of this project. Those relying on the record document are advised to obtain independent verification of its accuracy before using it for any other purpose.

Enclosed, please find the Letter of Engineer's Certification and the as-built AA Traffic Circulation Layout. Therefore, we request approval of the as-built AA Traffic Circulation Layout and issuance of the Temporary Certificate of Occupancy to allow the contractor to complete the corrections as noted below.

- 1) Install Bicycle Racks at the Main Entrance
- 2) Install Stop Bar Stripe at the Access Roadway to the facility
- 3) Install an ADA Compliant Pedestrian Crossing at the North Access entrance.

If you have any questions or need additional information regarding this matter, please do not hesitate to contact the place of the second seco





Ronald R. Bohannan, P.E.

Enclosure/s

JN: 2023018 RRB/JN/DB

2023018 Temp AA Approved Traffic Circulation Submittal Letter-.pdf

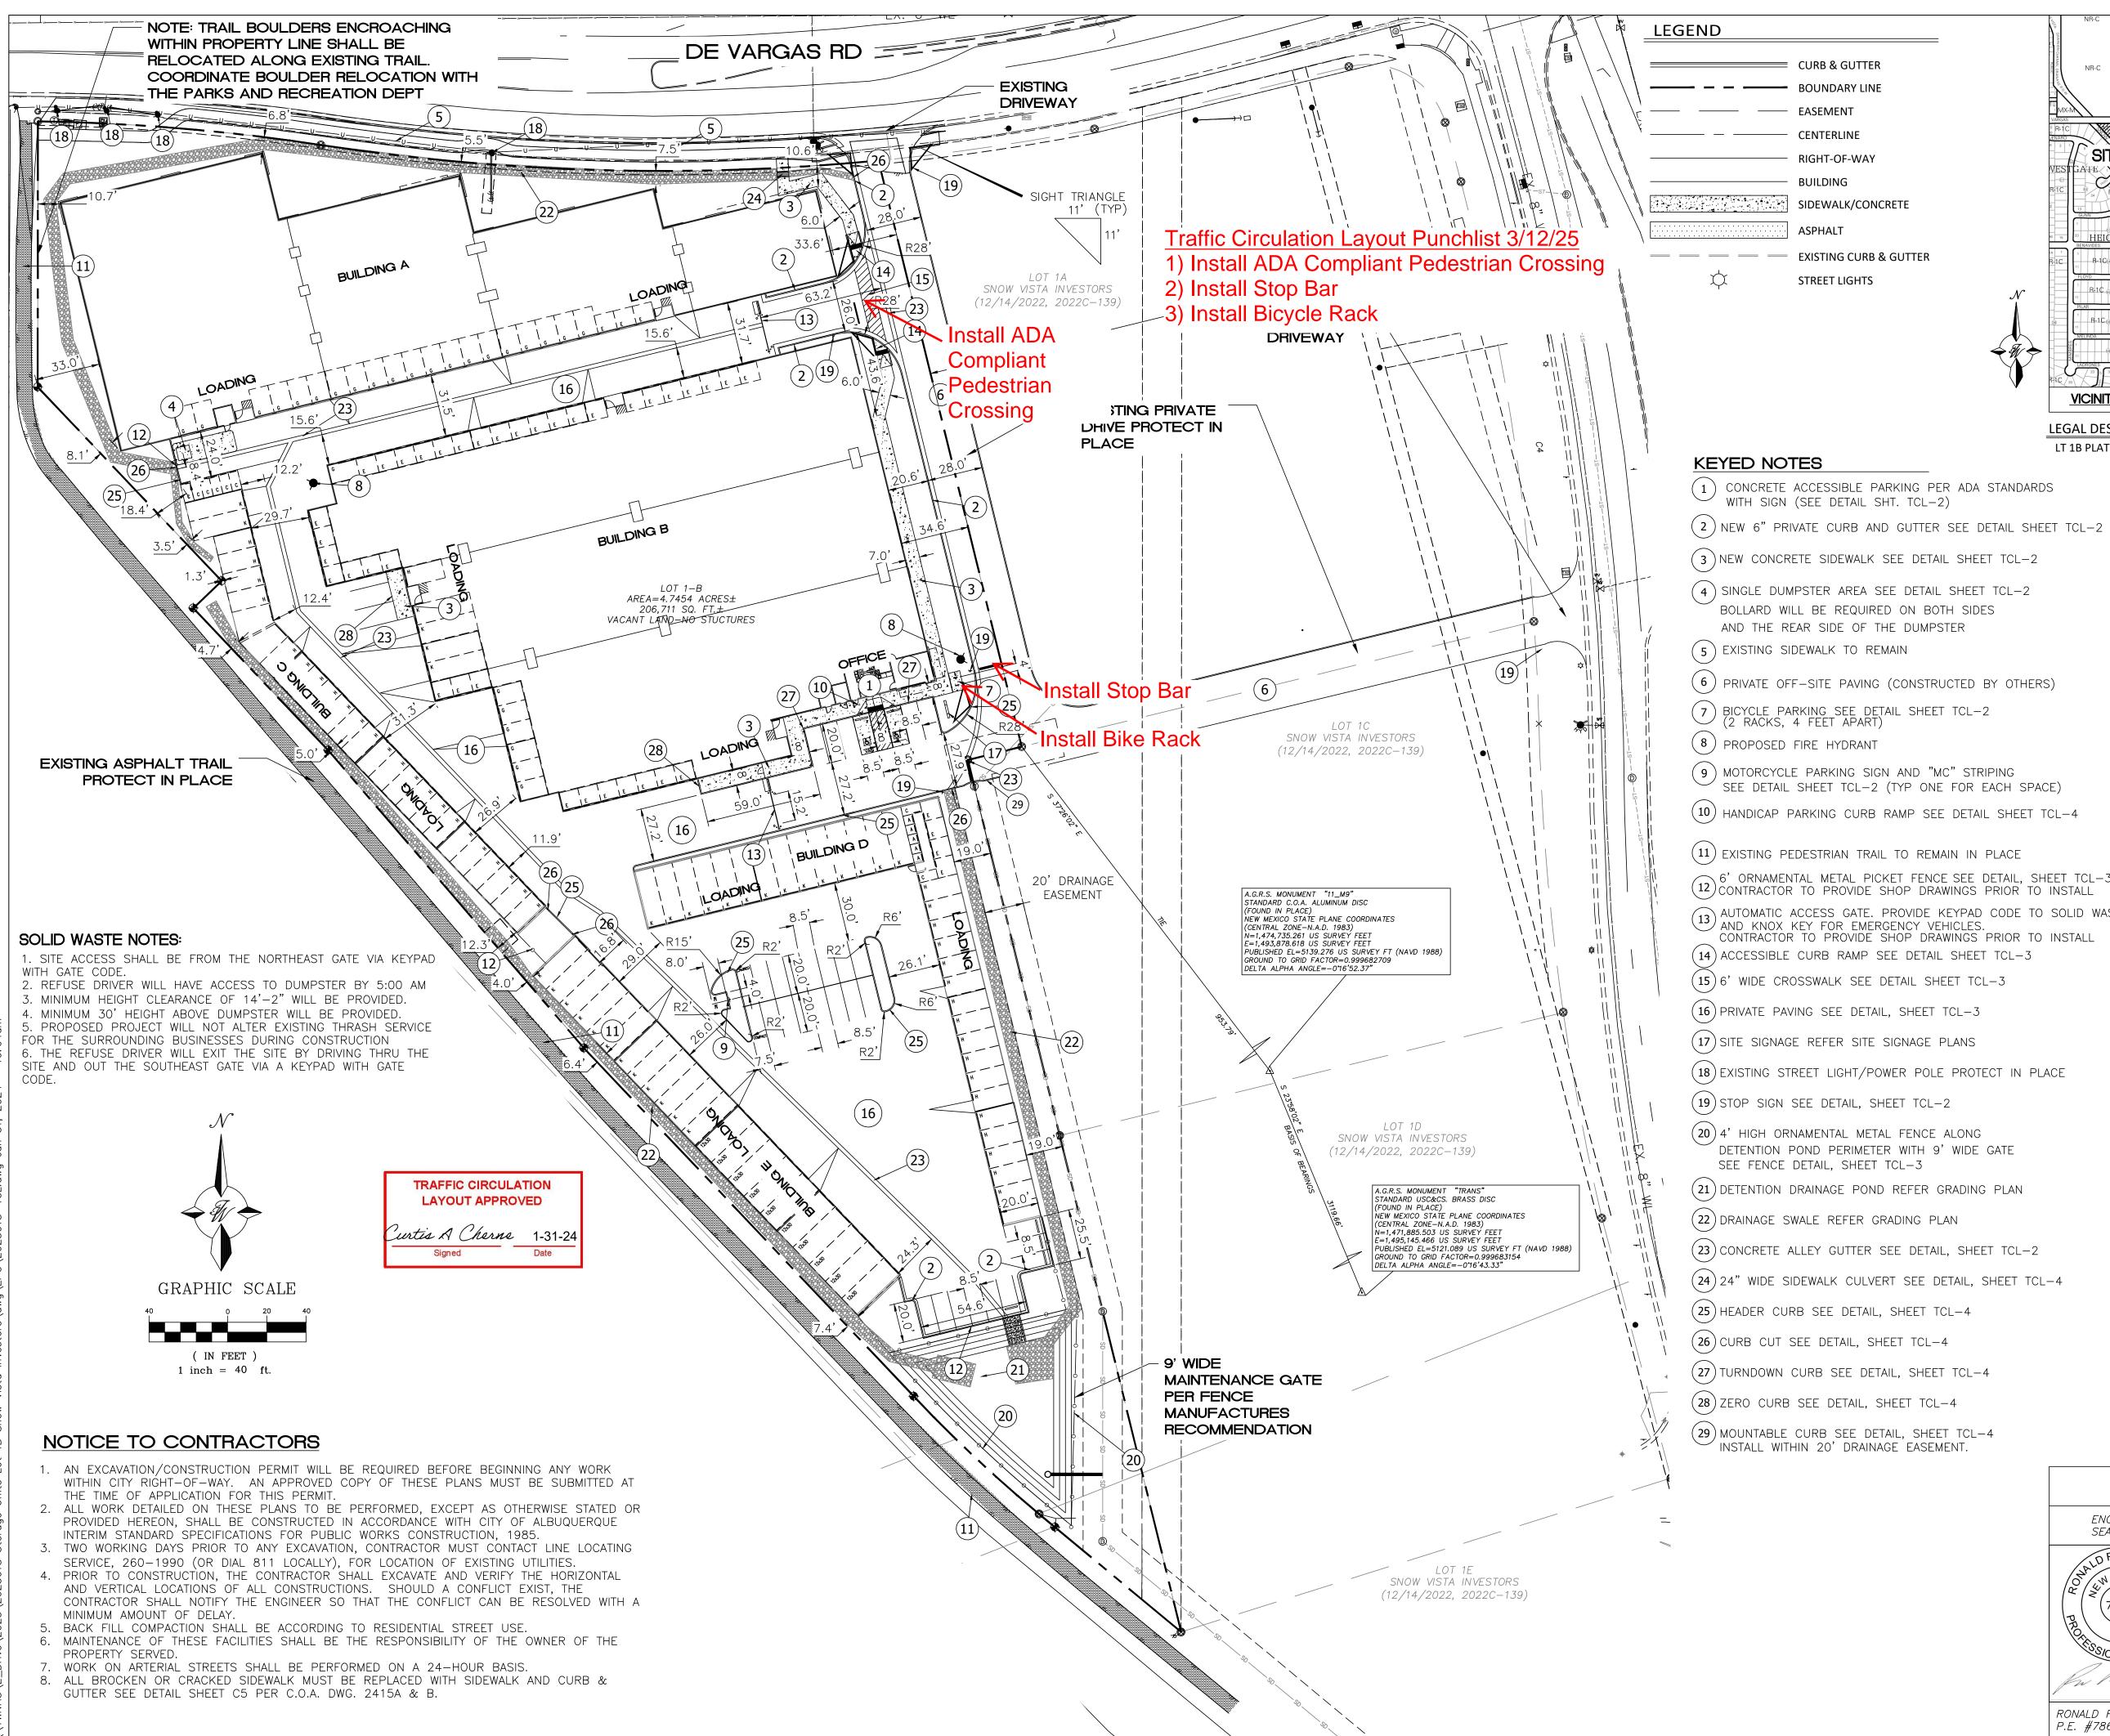

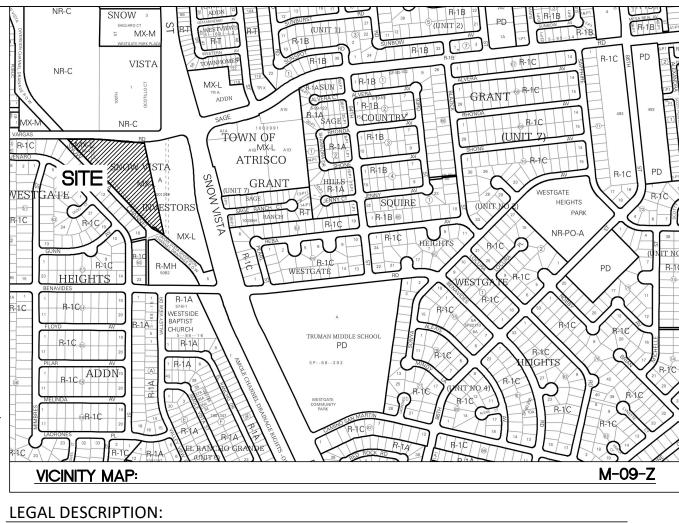

LT 1B PLAT OF LOTS 1A, 1B, 1C, 1D AND 1E SNOW VISTA INVESTORS CONT 4.7454 +/- AC

SELF STORAGE

103.951 S

33,464 SF

48.680 SF

6.007 SF

8.600 SF

7.200 SF

34 SPACES

2 SPACE

206,709.6 SF (4.74 ACRES)

103,951 SF / 3000 SF = 34 SPACES

2 SPACES (1 VAN ACCESSIBLE)

9850 DE VARGAS RD SW ALBUQUERQUE NM 87121

SITE DATA

PROPOSED USAGE:

TOTAL BUILDING AREA

ZONE:

LOT AREA

ADDRESS

BUILDING A BUILDING B:

BUILDING C:

BUILDING D:

BUILDING E:

PARKING REQUIRE

PARKING PROVIDED

HC PARKING REQUIRED

HC PARKING PROVIDED

MC PARKING REQUIRED:

MC PARKING PROVIDED:


BICYCLE PARKING REQUIRED: 3 SPACES


BICYCLE PARKING PROVIDED: 3 SPACES


SEE DETAIL SHEET TCL-2 (TYP ONE FOR EACH SPACE)

 $\gtrsim$  6' ORNAMENTAL METAL PICKET FENCE SEE DETAIL, SHEET TCL-3(12) CONTRACTOR TO PROVIDE SHOP DRAWINGS PRIOR TO INSTALL (12) AUTOMATIC ACCESS GATE. PROVIDE KEYPAD CODE TO SOLID WASTE CONTRACTOR TO PROVIDE SHOP DRAWINGS PRIOR TO INSTALL

ENGINEER'S SEAL	98TH & SAGE STORAGE	DRAWN BY BF
NALD R. BOHA 11	ALBUQUERQUE, NM TRAFFIC	<i>DATE</i> 01/31/2024
2 7868 7868 0 2 7868 0 2 7868 0 2 7 7 8 7 8 7 8 7 8 7 8 7 8 7 8 7 8 7 8	CIRCULATION LAYOUT	2023018-TCL
	<i>TIERRA WEST, LLC</i> 5571 MIDWAY PARK PLACE NE ALBUQUERQUE, NM 87109 (505) 858-3100 www.tierrawestllc.com	SHEET # TCL-1
		јов <b>#</b> 2023018

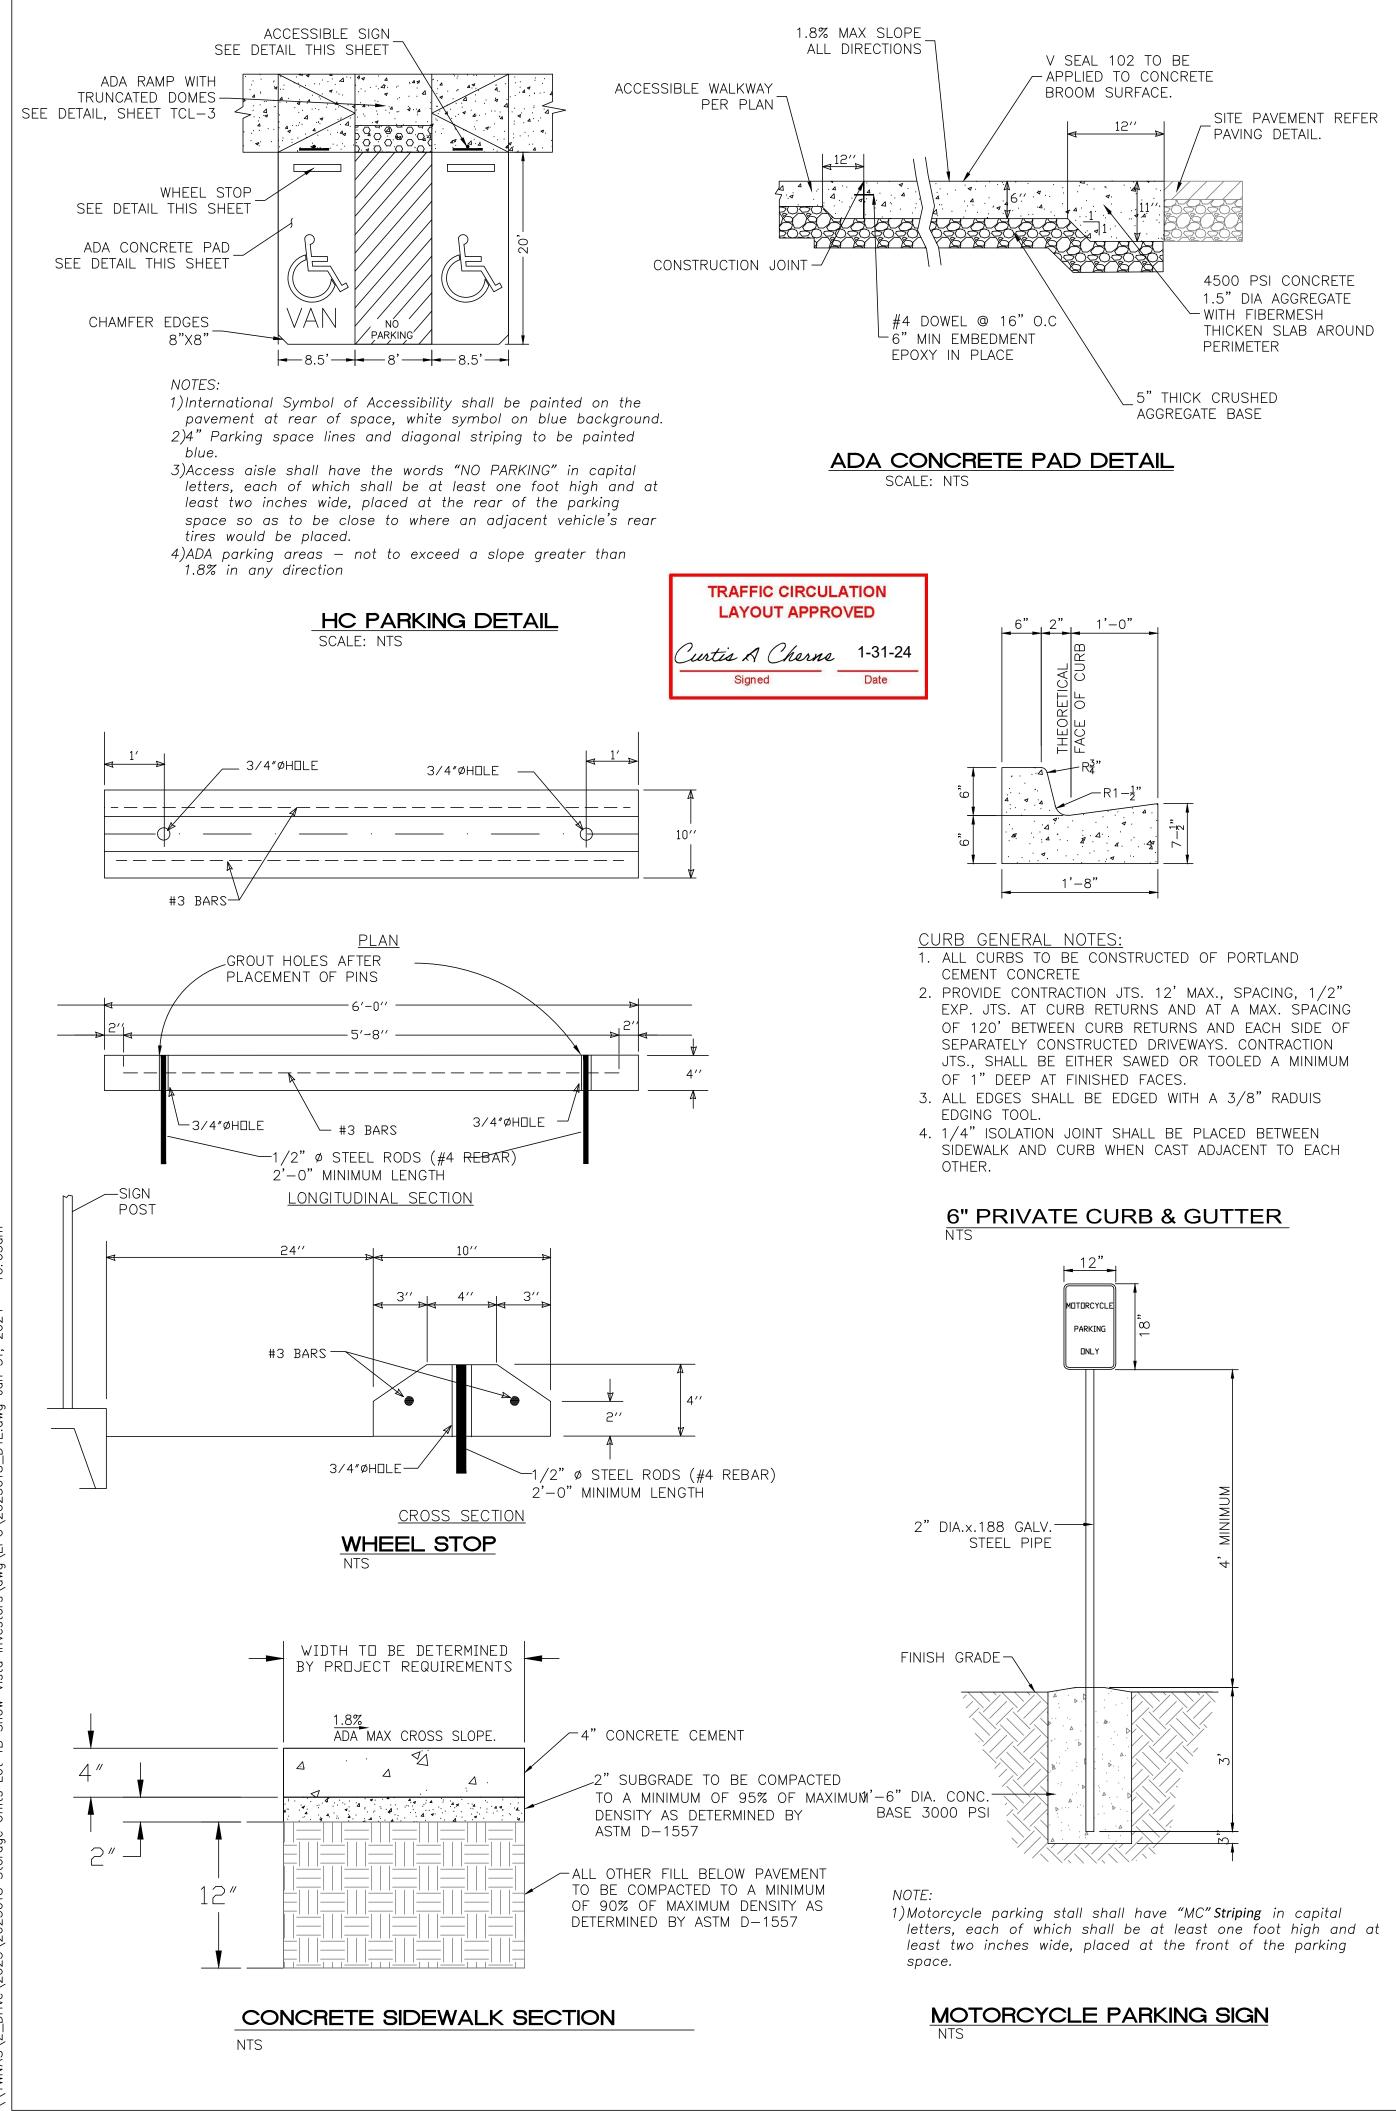


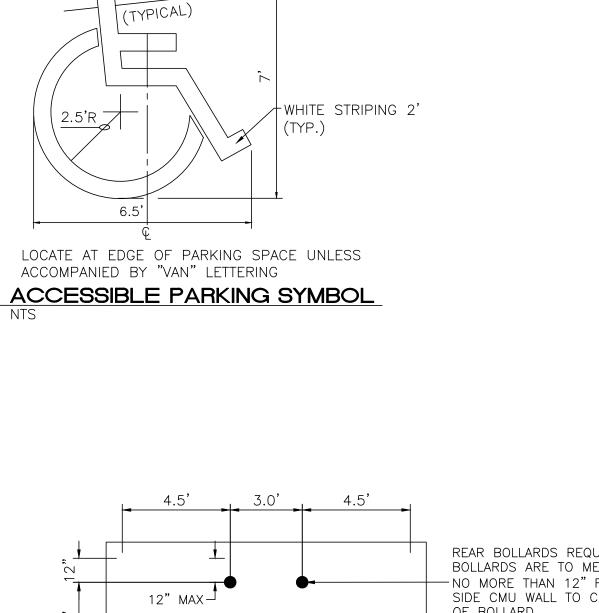

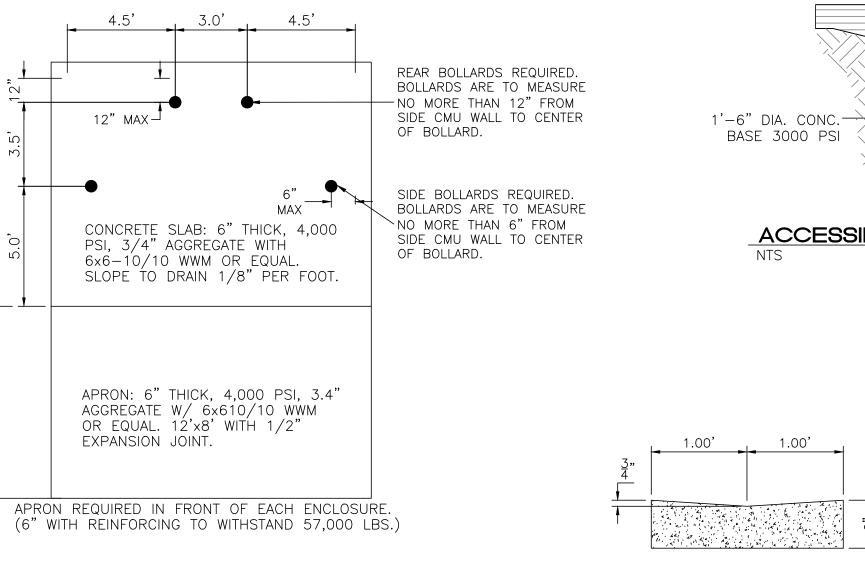


SCALE: 1"=1'

DUMPSTER BOLLARD DETAIL

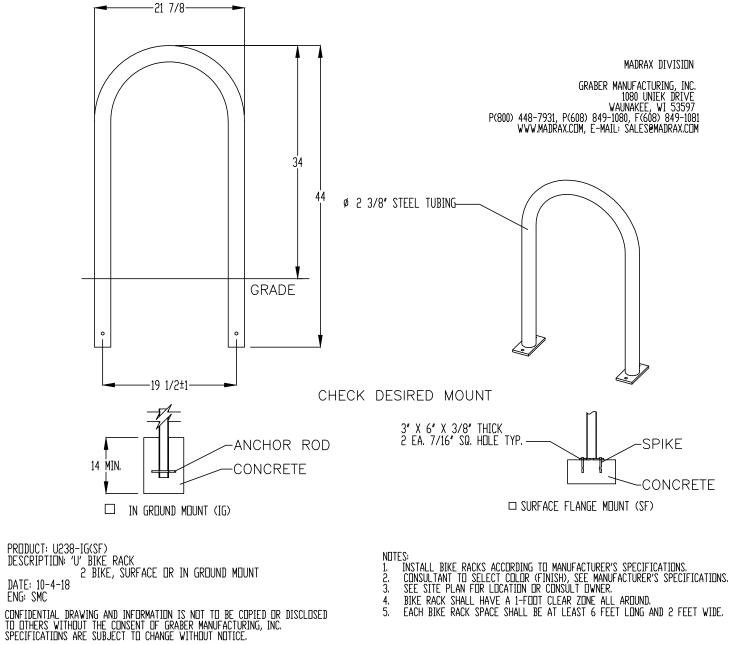



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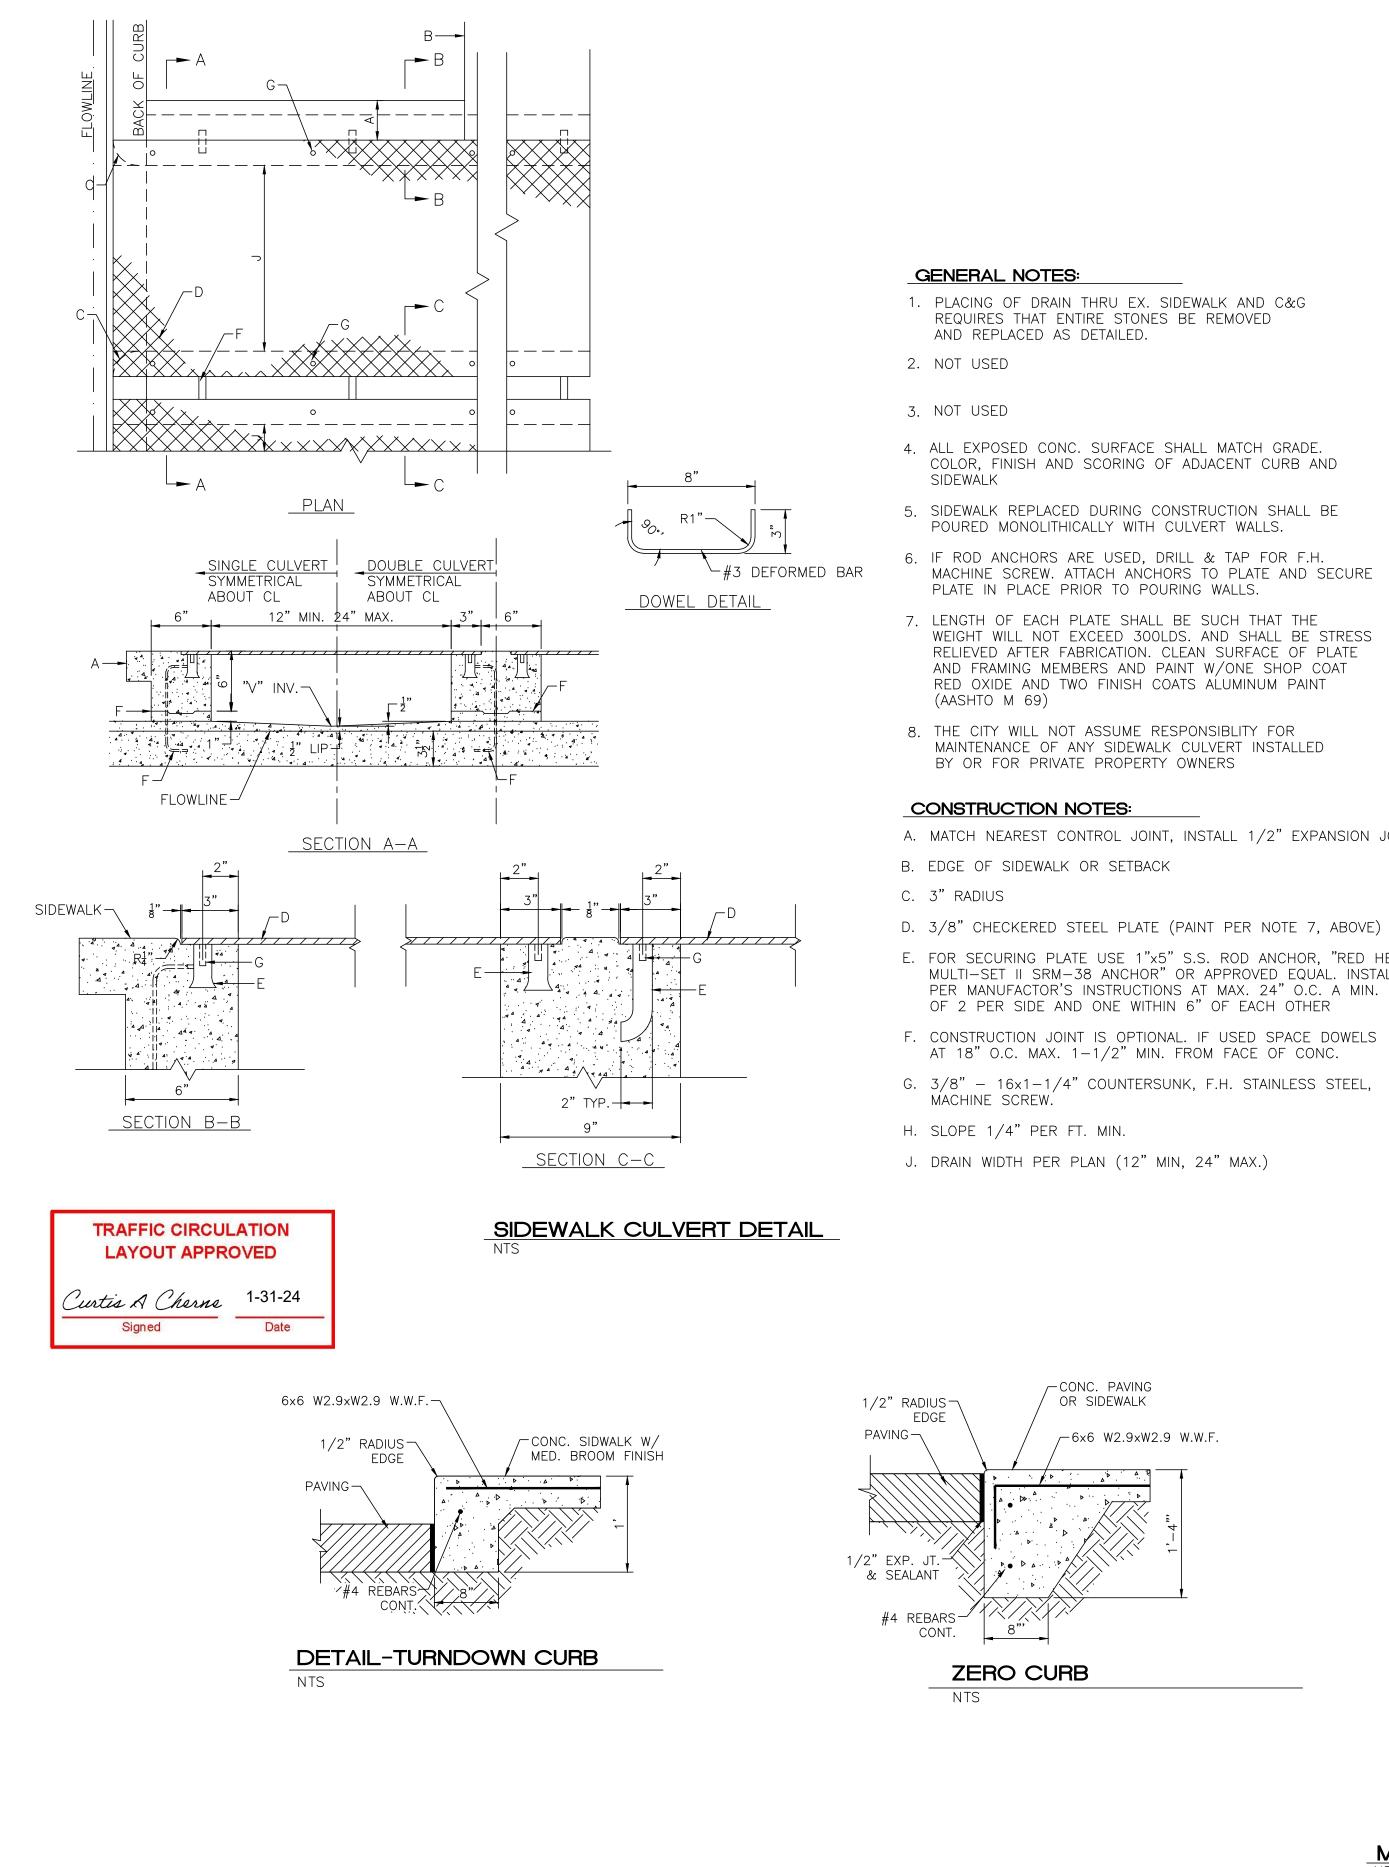
**BIKE RACK** SCALE: NONE

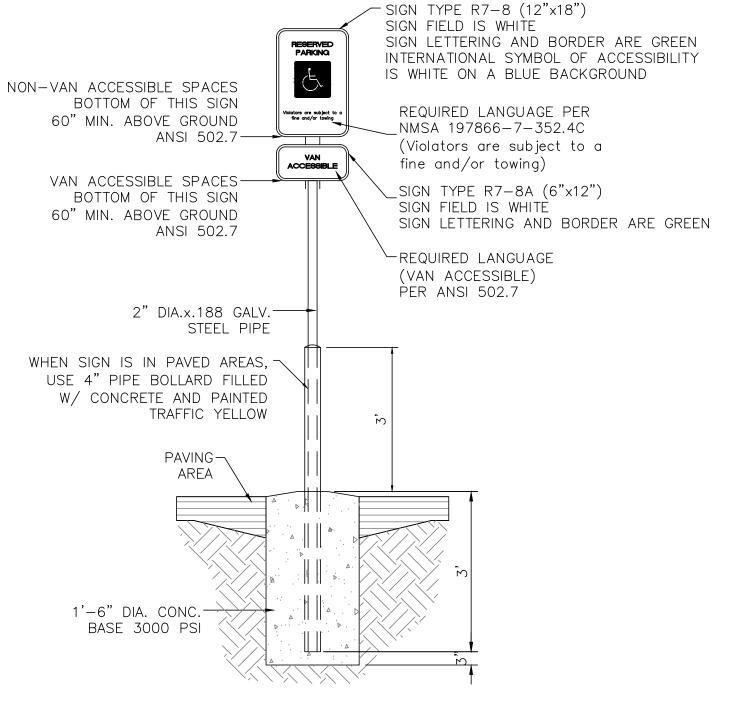


## ACCESSIBLE PARKING SIGN



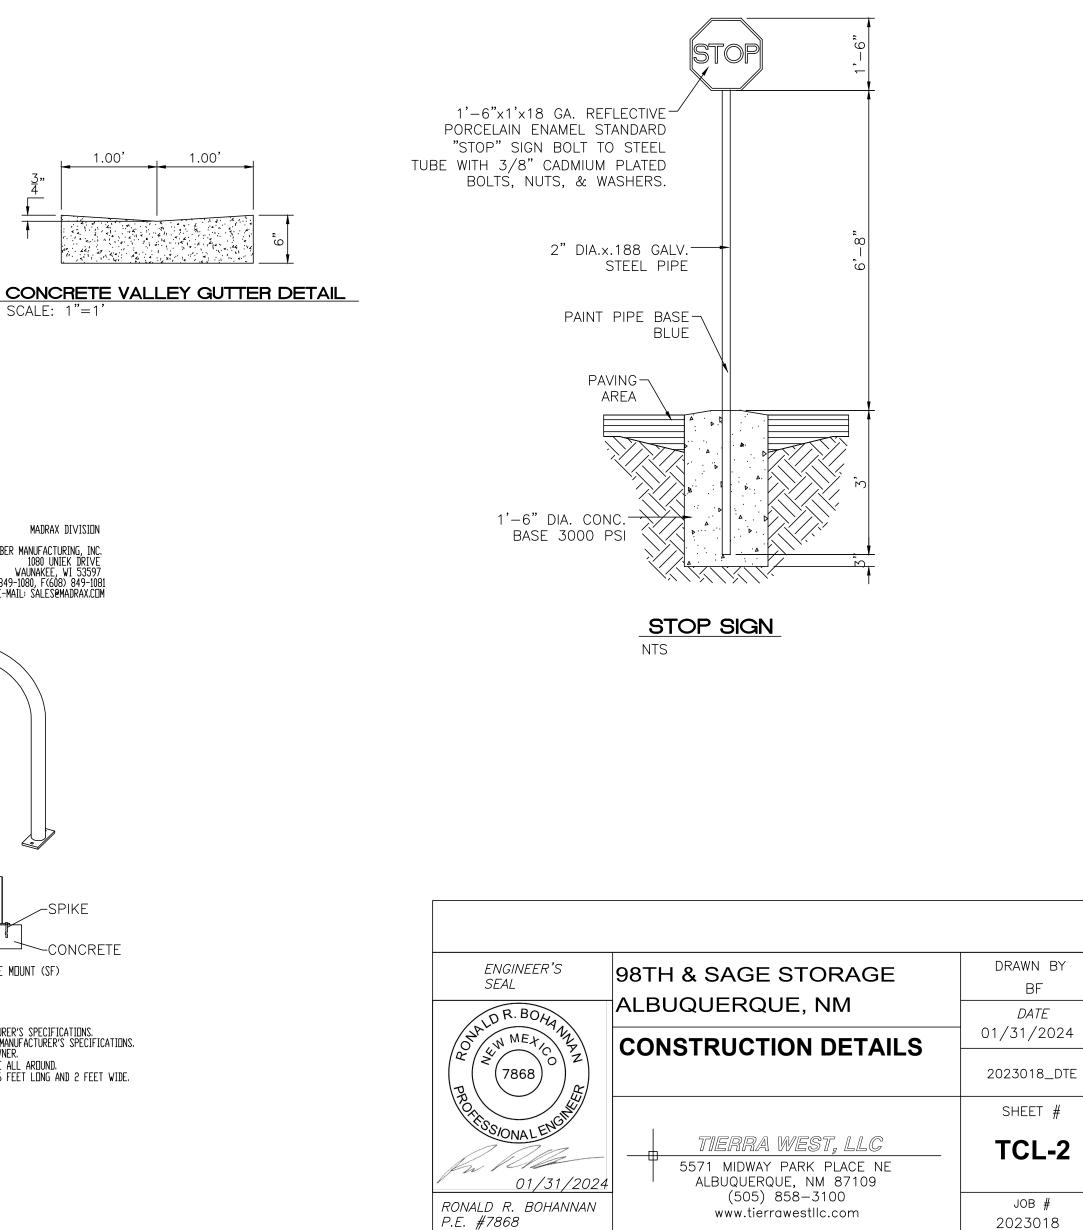

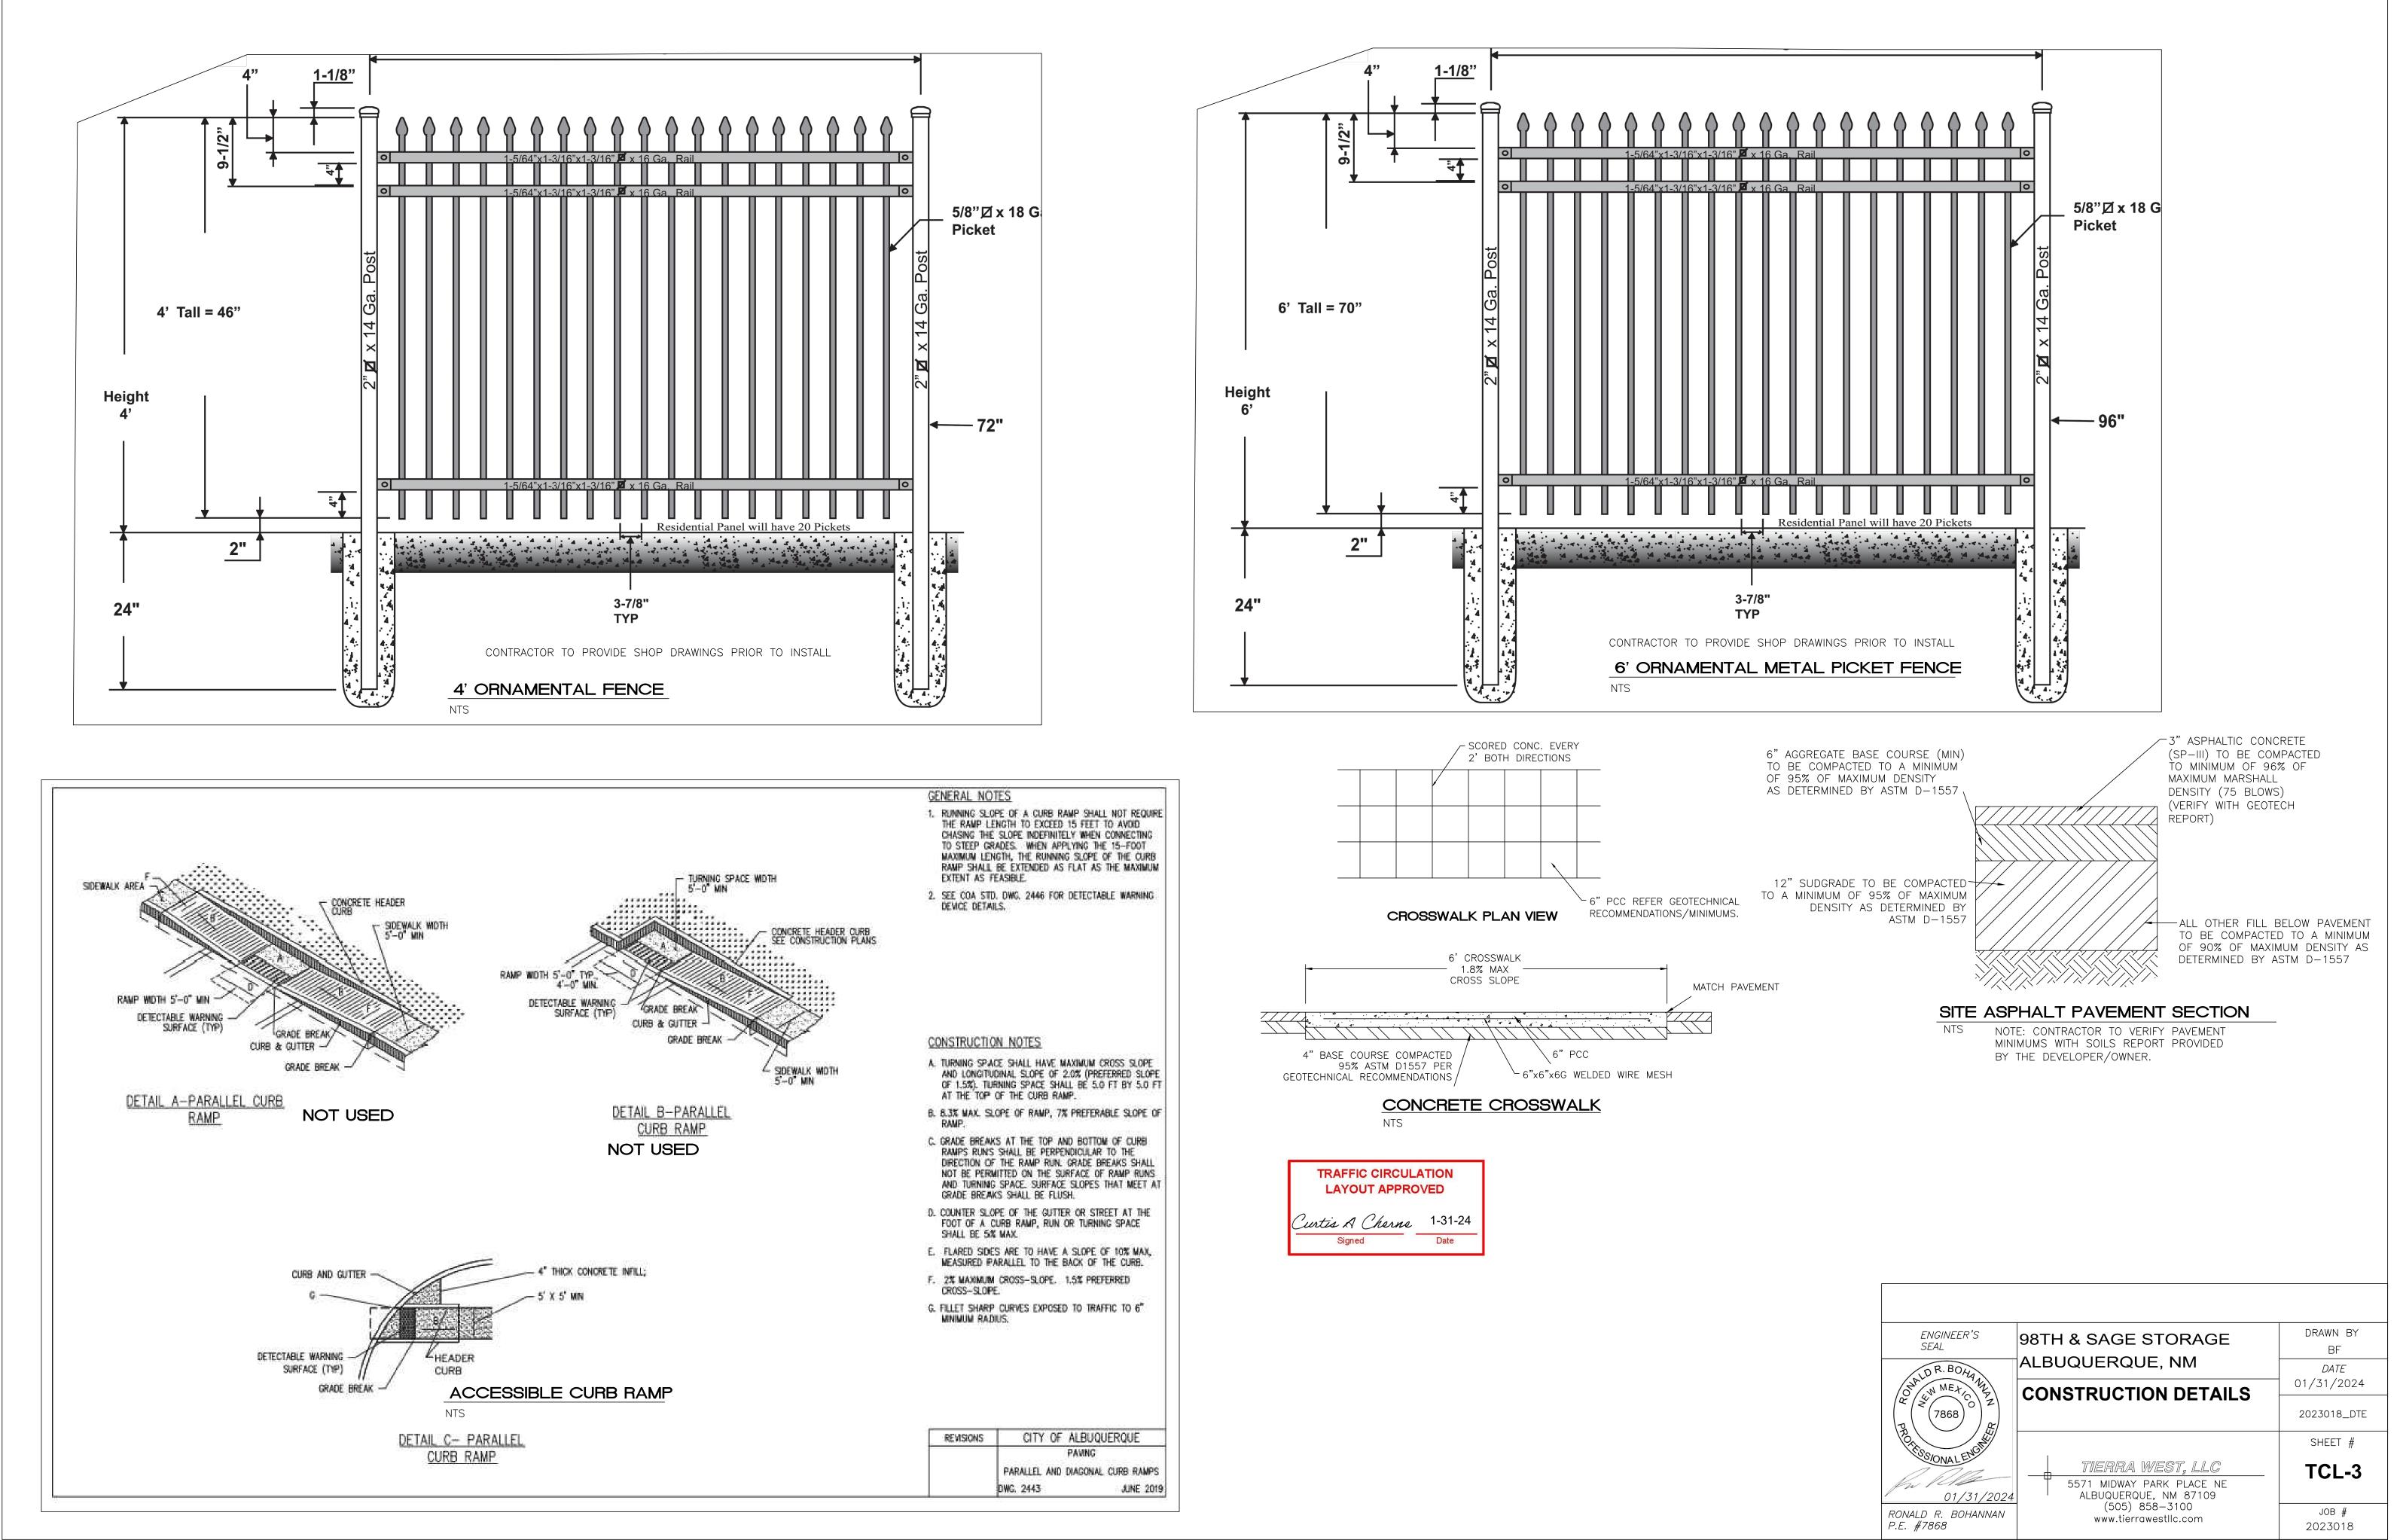

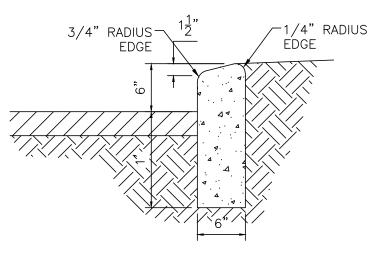

REQUIRES THAT ENTIRE STONES BE REMOVED

4. ALL EXPOSED CONC. SURFACE SHALL MATCH GRADE. COLOR, FINISH AND SCORING OF ADJACENT CURB AND

5. SIDEWALK REPLACED DURING CONSTRUCTION SHALL BE POURED MONOLITHICALLY WITH CULVERT WALLS.

6. IF ROD ANCHORS ARE USED, DRILL & TAP FOR F.H. MACHINE SCREW. ATTACH ANCHORS TO PLATE AND SECURE

7. LENGTH OF EACH PLATE SHALL BE SUCH THAT THE WEIGHT WILL NOT EXCEED 300LDS. AND SHALL BE STRESS RELIEVED AFTER FABRICATION. CLEAN SURFACE OF PLATE AND FRAMING MEMBERS AND PAINT W/ONE SHOP COAT RED OXIDE AND TWO FINISH COATS ALUMINUM PAINT


8. THE CITY WILL NOT ASSUME RESPONSIBLITY FOR MAINTENANCE OF ANY SIDEWALK CULVERT INSTALLED

A. MATCH NEAREST CONTROL JOINT, INSTALL 1/2" EXPANSION JOINT

E. FOR SECURING PLATE USE 1"x5" S.S. ROD ANCHOR, "RED HEAD MULTI-SET II SRM-38 ANCHOR" OR APPROVED EQUAL. INSTALL PER MANUFACTOR'S INSTRUCTIONS AT MAX. 24" O.C. A MIN. OF 2 PER SIDE AND ONE WITHIN 6" OF EACH OTHER

F. CONSTRUCTION JOINT IS OPTIONAL. IF USED SPACE DOWELS

G. 3/8" - 16x1-1/4" COUNTERSUNK, F.H. STAINLESS STEEL,

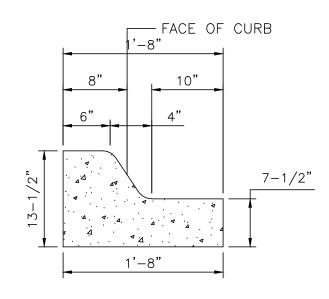

CURB GENERAL NOTES: 1. ALL CURBS TO BE CONSTRUCTED OF PORTLAND CEMENT CONCRETE. 2. PROVIDE CONTRACTION JTS. 12' MAX., SPACING, 1/2" EXP. JTS. AT CURB RETURNS AND AT A MAX. SPACING OF 120' BETWEEN CURB RETURNS AND EACH SIDE OF SEPARATELY CONSTRUCTED DRIVEWAYS. CONTRACTION JTS., SHALL BE EITHER SAWED OR TOOLED A MINIMUM OF 1" DEEP AT FINISHED FACES. 3. ALL EDGES SHALL BE EDGED WITH A 3/8" RADUIS EDGING TOOL. 4. 1/4" ISOLATION JOINT SHALL BE PLACED BETWEEN SIDEWALK AND CURB WHEN CAST ADJACENT TO EACH OTHER.


## MOUNTABLE CURB / GUTTER

CURB GENERAL NOTES: 1. ALL CURBS TO BE CONSTRUCTED OF PORTLAND CEMENT CONCRETE. 2. PROVIDE CONTRACTION JTS. 12' MAX., SPACING, 1/2" EXP. JTS. AT CURB RETURNS AND AT A MAX. SPACING OF 120' BETWEEN CURB RETURNS AND EACH SIDE OF SEPARATELY CONSTRUCTED DRIVEWAYS. CONTRACTION JTS., SHALL BE EITHER SAWED OR TOOLED A MINIMUM OF 1" DEEP AT FINISHED FACES. 3. ALL EDGES SHALL BE EDGED WITH A 3/8" RADUIS EDGING TOOL. 4. 1/4" ISOLATION JOINT SHALL BE PLACED BETWEEN SIDEWALK AND CURB WHEN CAST ADJACENT TO EACH

6" HEADER CURB DETAIL


OTHER.

NTS

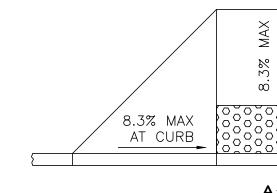



NOT TO SCALE

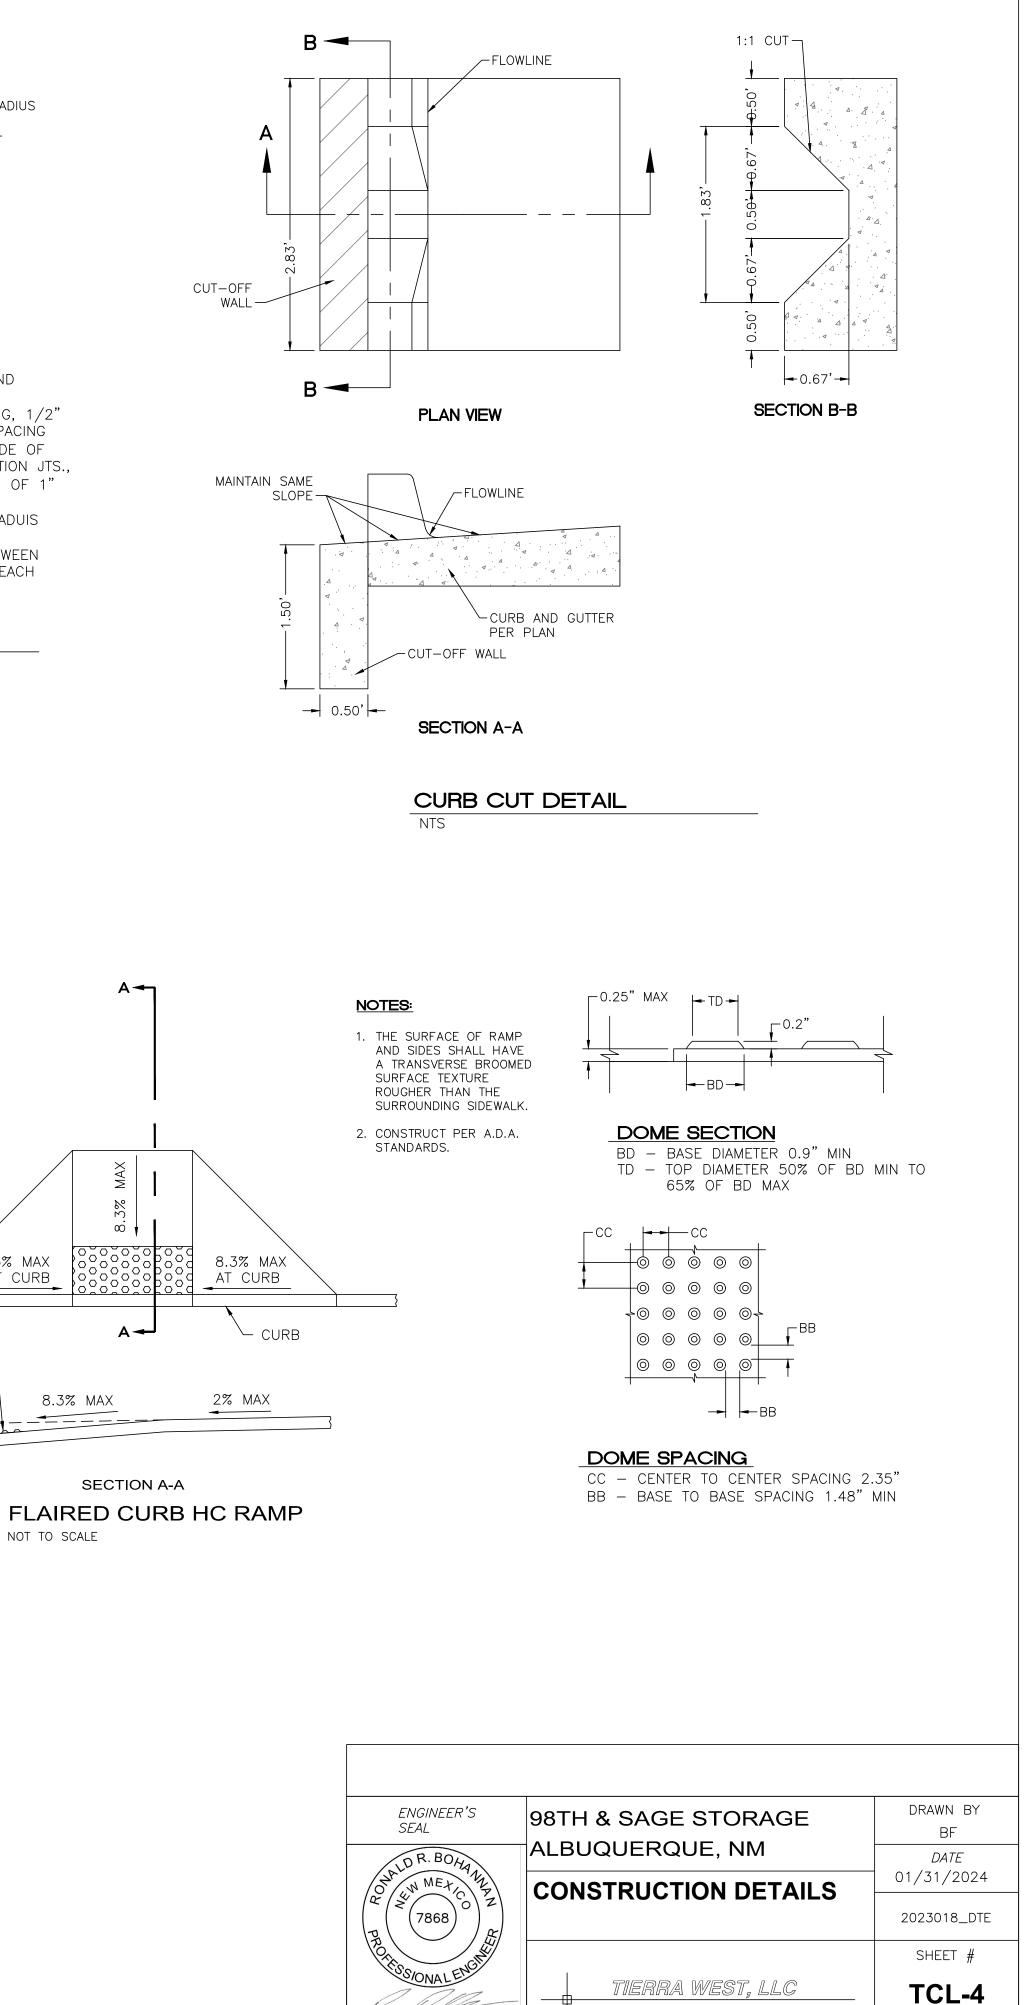

TIERRA WEST, LLC 5571 MIDWAY PARK PLACE NE ALBUQUERQUE, NM 87109 (505) 858-3100 www.tierrawestllc.com

1012

RONALD R. BOHANNAN

P.E. #7868

01/31/2024

JOB # 2023018