


		MITTAL 022
SHEET NO.	SHEET TITLE	INITIAL SUBMITTAL 08/18/2022
C-0	COVER SHEET	•
C-2.0	EXISTING CONDITIONS AND DEMOLITON PLAN	•
C-3.0	SWPPP PHASING	•
C-3.1	SWPPP NOTES	•
C-4.0	GRADING PLAN	•
C-4.1	DRAINAGE PLAN	•
C-4.2	DRAINAGE AND GRADING DETAILS	•
C-4.3	GRADING DETAILS	•
C-5.0	UTILITY PLAN	•
C-5.1	UTILITY DETAILS	•
C-5.2	UTILITY DETAILS	•
C-6.0	MOT PLAN-PHASE1	•
C-6.1	MOT PLAN- PHASE 2	•
C6.2	MOT DETAILS	•

N.T.S. 300 0 300 SCALE : 1" = 300'


DEVELOPMENT PLAN/CONSTRUCTION PLAN/STORMWATER MANAGEMENT PLA FOR SNOW VISTA ALBUQUERQUE, NEW MEXICO



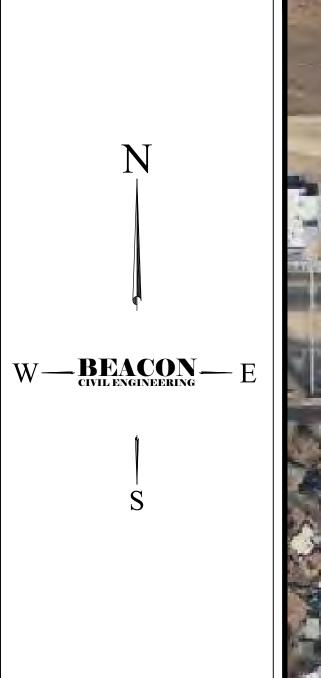

VICINITY MAP 300 0 300 SCALE : 1" = 300'

		CONSULTANTS	BEACON		LAND DEVELOPMENT ENGINEERS	8345 GUNN HIGHWAY TAMPA. FL 33626			
		BENCH MARKS		LEFT ONTO LOMAS AND GO WEST 0.7 MILES TO		THE WEST SIDE OF THE INTERSECTION. THE	STATION MARK IS A CITY OF ALBUQUERQUE SURVEY CONTROL 3 1/4 INCH ALUMINUM DISC	STAMPED "17-J14 1	¹³⁶ OF THE CONCRETE.
		SEAL	THE PROFILE		++++++++++++++++++++++++++++++++++++++	NAA CO	The ER		ATEF A. HANNA, PE #27436
				DESCRIPTION	CONTRACTOR:	DATE:	DATE:	DATE:	DATE:
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MEL MARK	COVER	(SHEE	Τ					
DESIGN REVIEW COMMITTEE	E CITY ENGINEER APPROVAL	ZC	ONE MAP N		_9	9			
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	WESTVIEW TOWNHOMES ADDITION 07/03/1980, VOLUME C17, FOLIO 6-1-2	
enere	LOT 57 LOT 56 LOT 55 LOT	54
	Sector with the sector	
	<u>Phase one</u> scale: 1"=40'	
PHASE	<u>I LEGEND</u> PROPOSED SAW-CUT LIMITS. SEE NEW PAVEMENT INTERFACE	<u>Phase</u> Sf
	DETAIL SHEET C-2.0 CONSTRUCTION DRIVE. SEE DETAIL SHEET C-2.1	
SF	SILT FENCE. SEE DETAIL SHEET C-2.0 STOCKPILE LOCATION	
	INLET PROTECTION	///////////////////////////////////////

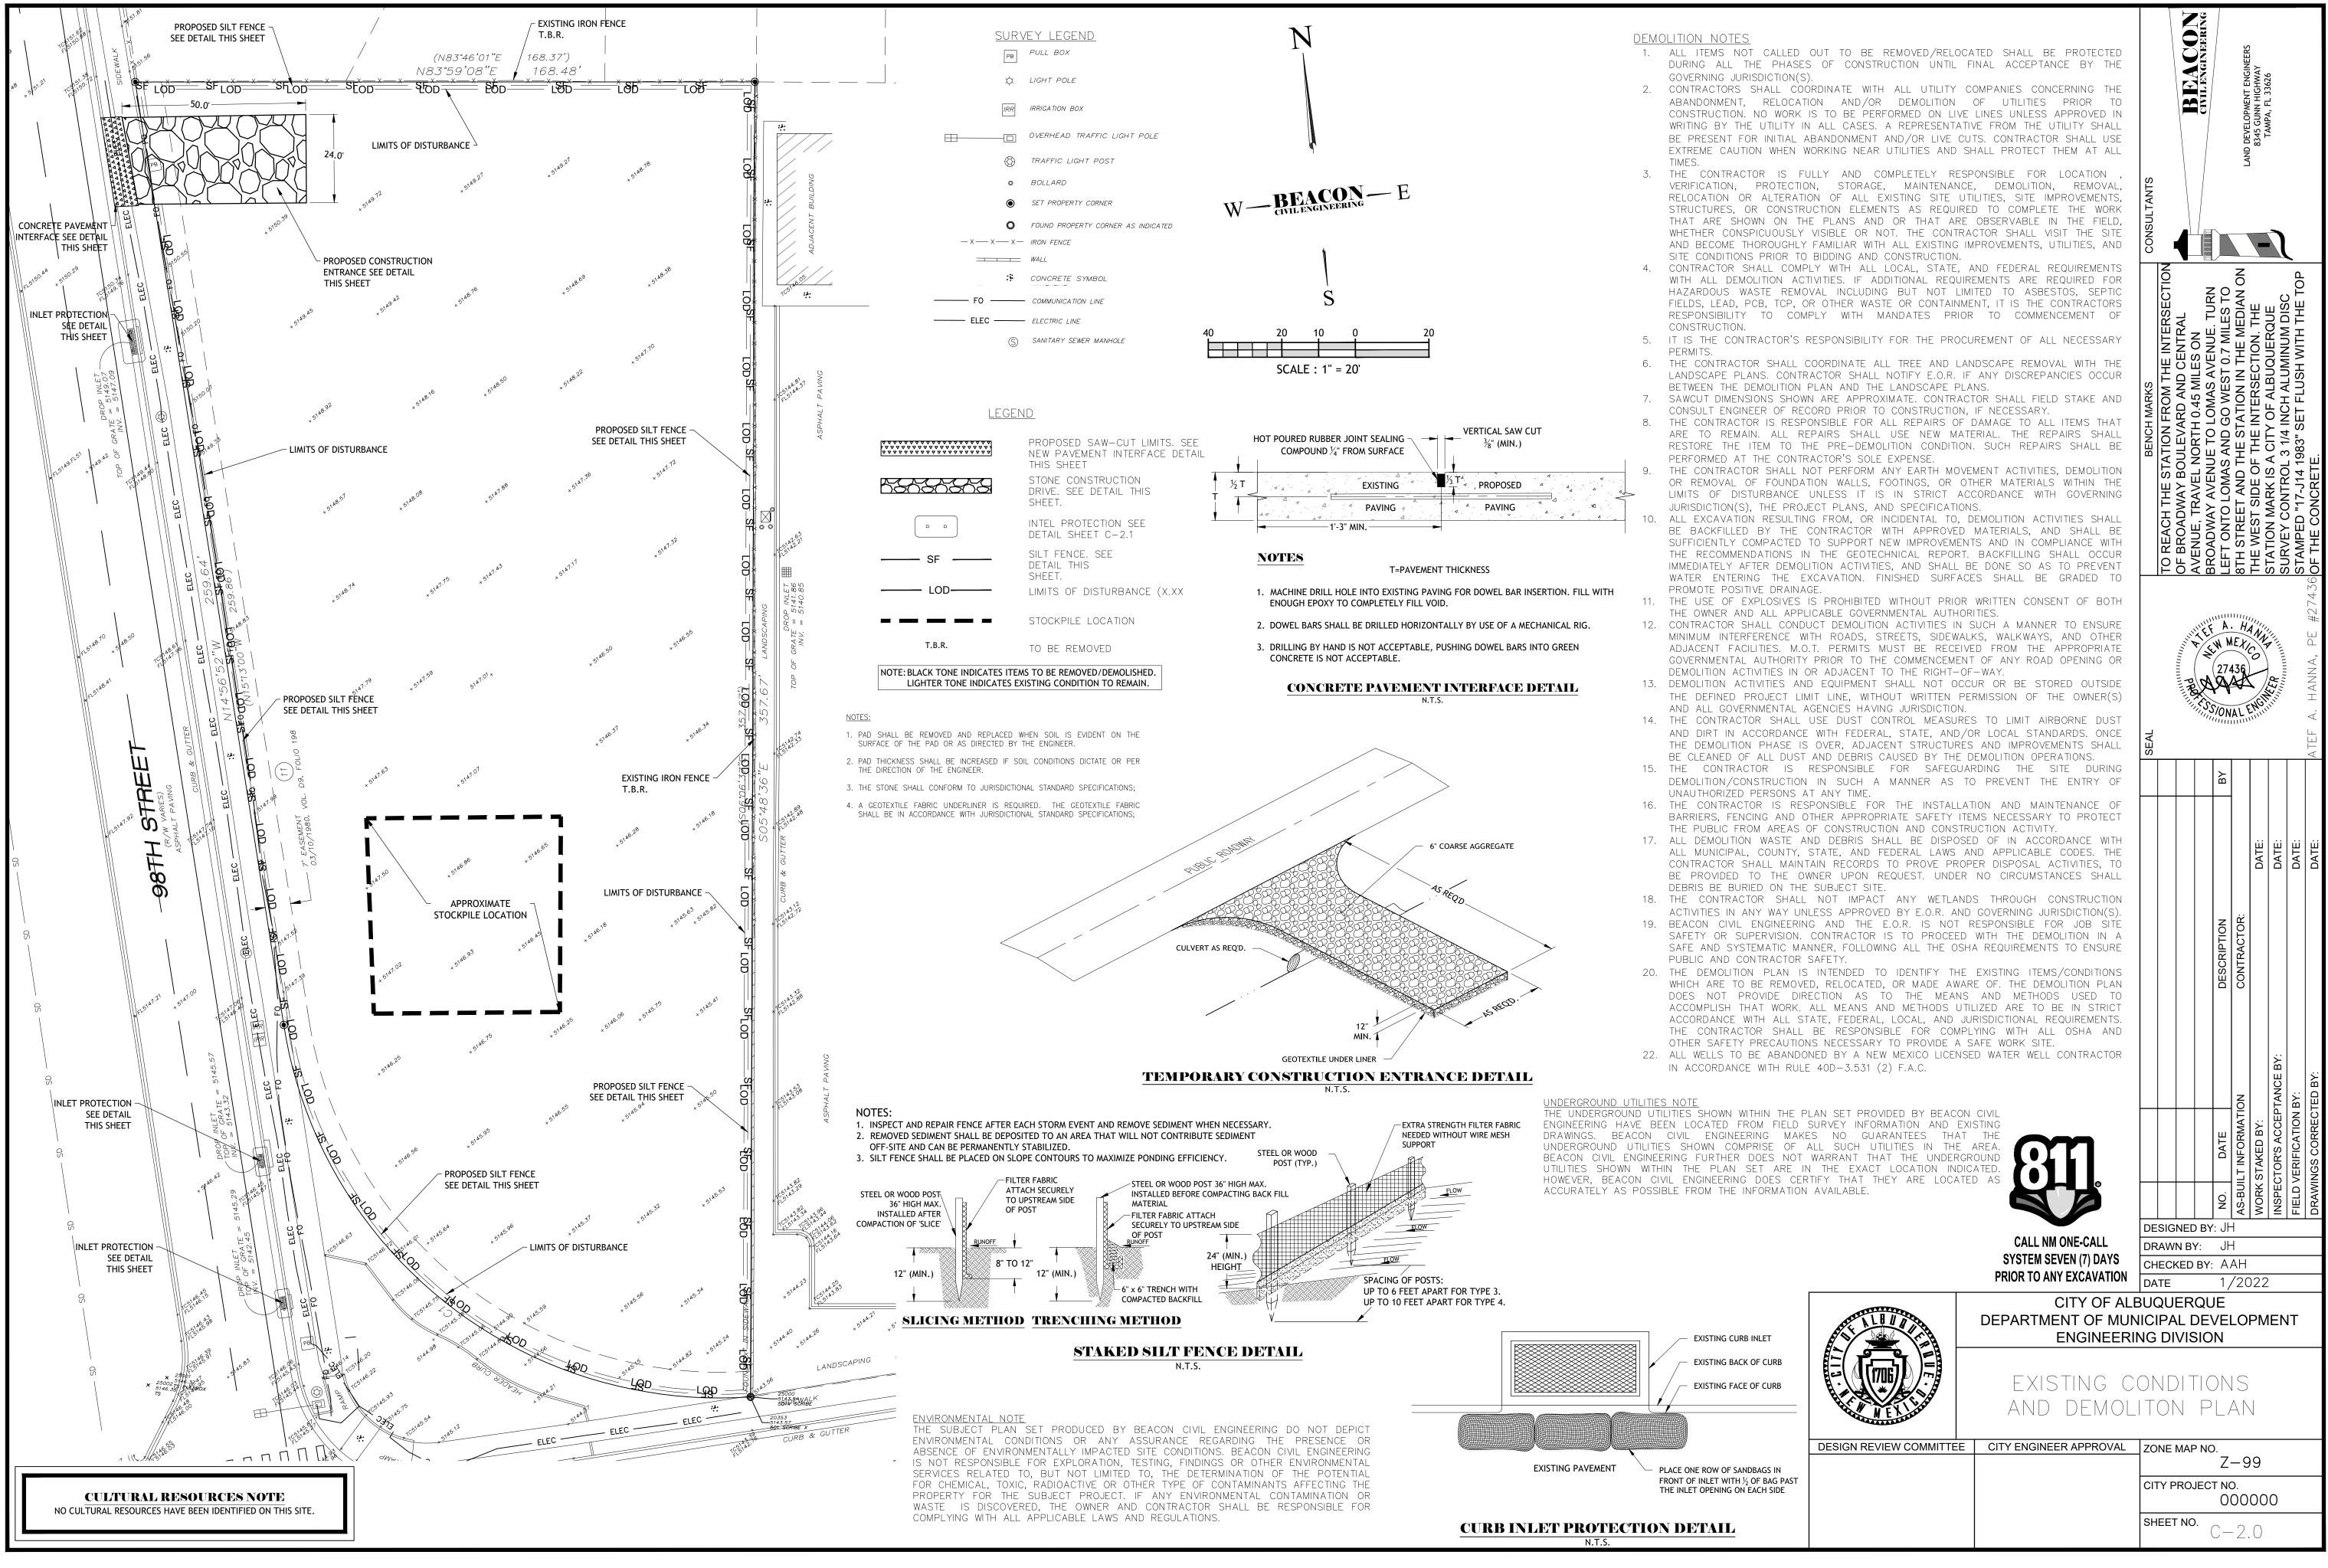TEMPORARY NATIVE SEED BLEND OPEN TRENCH MILLING

INLET PROTECTION

SILT FENCE. SEE DETAIL SHEET C-2.0


II LEGEND


<u>phase III legend</u>

+ + + + + PERMANENT NATIVE SEED BLEND



<u>Phase two</u> SCALE: 1"=40'

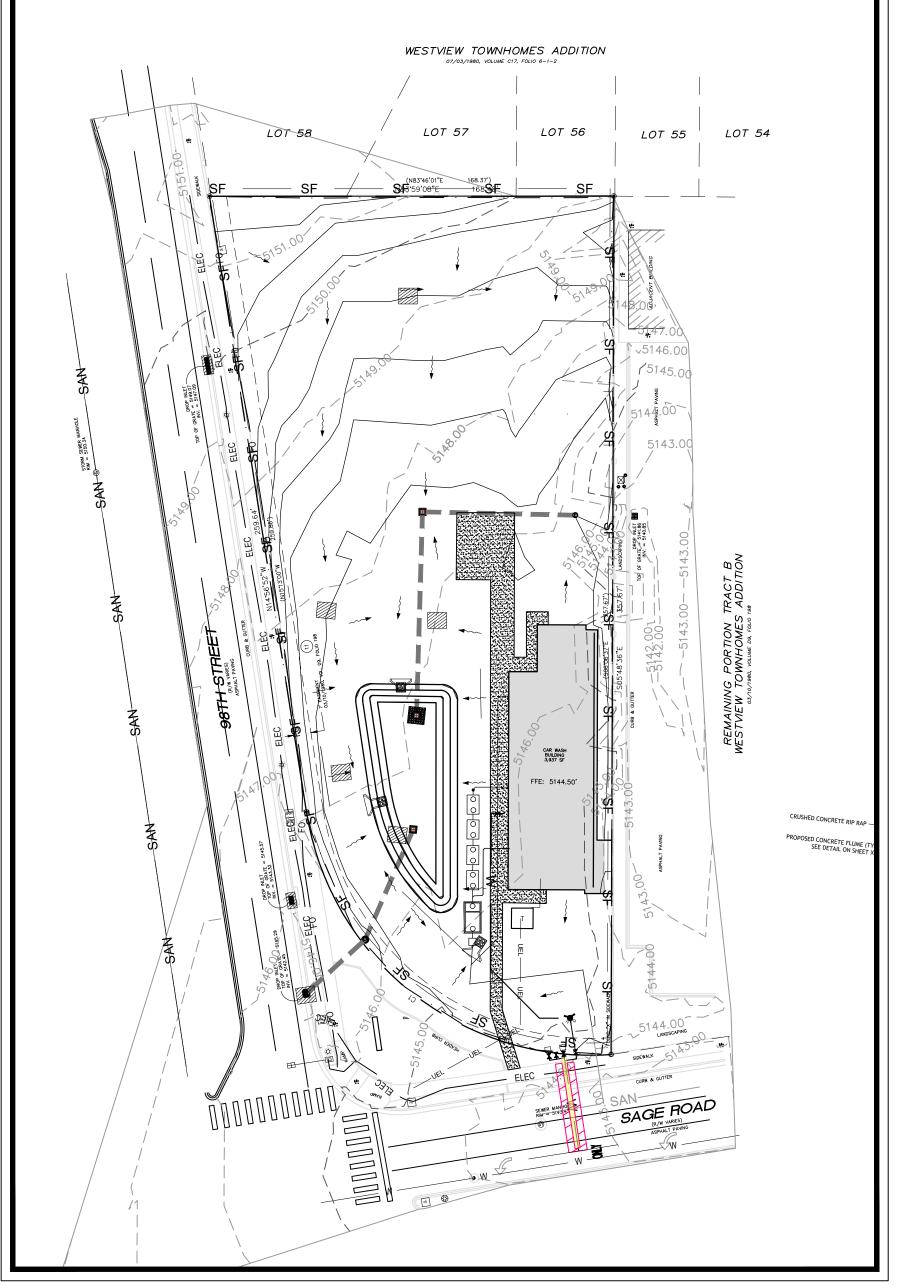

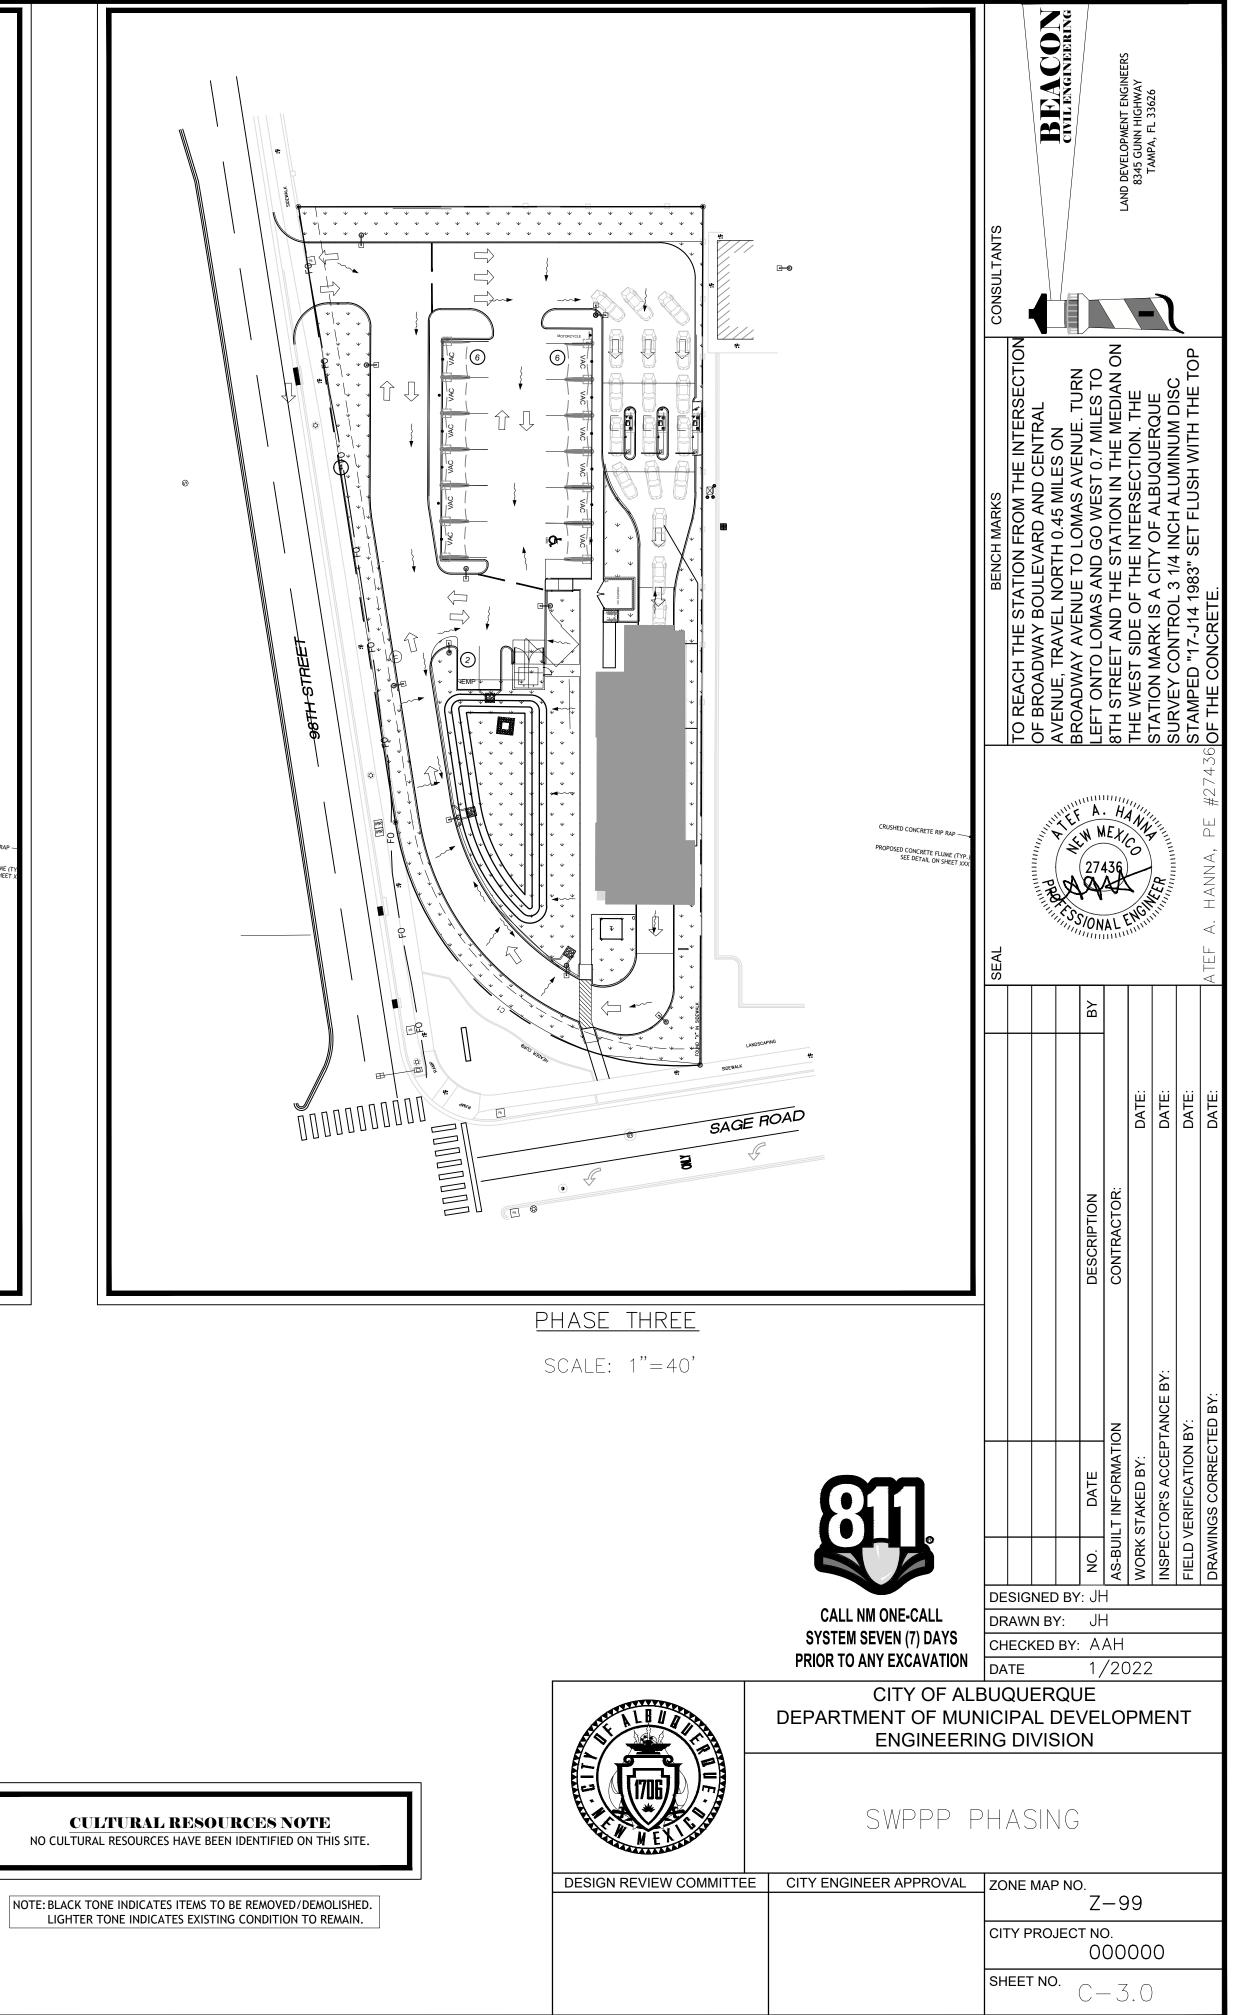

SWPPP STANDARD NOTES

1. SEDIMENT CONTROL PRACTICES MUST BE ESTABLISHED ON ALL DOWN GRADIENT PERIMETERS BEFORE ANY UPGRADIENT LAND DISTURBING ACTIVITIES BEGIN. THESE PRACTICES MUST REMAIN IN PLACE UNTIL FINAL STABILIZATION HAS BEEN ACHIEVED IN ACCORDANCE WITH SECTION C EROSION CONTROL REQUIREMENTS.


- 2. IF DOWN GRADIENT TREATMENT SYSTEM IS OVERLOADED ADDITIONAL UP GRADIENT SEDIMENT CONTROL PRACTICES MUST BE INSTALLED TO ELIMINATE OVERLOADING. THE SWPPP MUST BE AMENDED TO IDENTIFY THE ADDITIONAL PRACTICES.
- 3. ALL STORM DRAIN INLETS MUST BE PROTECTED BY APPROVED BMPS DURING CONSTRUCTION UNTIL ALL POTENTIAL SOURCES FOR DISCHARGE HAVE BEEN STABILIZED. THESE DEVICES MUST BE MAINTAINED UNTIL FINAL STABILIZATION IS ACHIEVED. INLET PROTECTION MAY BE REMOVED IF A SPECIFIC SAFETY CONCERN (STREET FLOODING/FREEZING) HAS BEEN IDENTIFIED.
- 4. TEMPORARY STOCKPILES MUST HAVE SILT FENCE OR OTHER EFFECTIVE SEDIMENT CONTROLS ON THE DOWN GRADIENT SIDE OF THE STOCKPILE AND SHALL NOT BE PLACED AT LEAST 25 FEET FROM ANY ROAD, WETLAND, PROTECTED WATER, DRAINAGE CHANNEL, OR STORM WATER INLETS. STOCKPILE LEFT FOR MORE THAN 14 DAYS MUST BE STABILIZED WITH MULCH, VEGETATION, TARPS OR OTHER APPROVED MEANS.
- 5. VEHICLE TRACKING OF SEDIMENT FROM PROJECT SHALL BE MINIMIZED BY APPROVED BMPS. THESE SHALL BE INSTALLED AND MAINTAINED AT THE CITY APPROVED ENTRANCES. INDIVIDUAL LOTS SHALL EACH BE REQUIRED TO INSTALL AND MAINTAINED ENTRANCES THROUGHOUT THE CONSTRUCTION BUILDING UNTIL A PAVED DRIVEWAY IS INSTALL.
- 6. SEDIMENT THAT HAS WASHED OR TRACKED FROM SITE BY MOTOR VEHICLES OR EQUIPMENT SHALL BE CLEANED FROM PAVED SURFACES THROUGHOUT THE DURATION OF CONSTRUCTION.
- 7. SILT FENCE OR OTHER APPROVED SEDIMENT CONTROL DEVICES MUST BE INSTALLED IN ALL AREAS AS SHOWN ON THE SWPPP.
- 8. SILT FENCE OR OTHER APPROVED SEDIMENT CONTROL DEVICES SHALL BE REQUIRED ALONG THE ENTIRE CURB LINE, EXCEPT FOR APPROVED OPENING WHERE CONSTRUCTION ENTRANCE WILL BE INSTALLED OR DRAINAGE FLOWS AWAY FROM CURB. THIS DEVICE MUST BE MAINTAINED UNTIL FINAL STABILIZATION IS ACHIEVED. DITCH CHECKS SHALL BE REQUIRED IN DITCH BOTTOMS. SPACING FOR THE CHECK MUST BE AS FOLLOWS: [HEIGHT IN FEET (OF THE SEDIMENT DEVICE USED)] X 100 / SLOPE GRADIENT
- 9. DUST CONTROL MEASURES, SUCH AS APPLICATION OF WATER MUST BE PERFORMED PERIODICALLY DUE TO WEATHER, CONSTRUCTION ACTIVITY, AND/OR AS DIRECTED BY THE CITY.
- 10. FLOWS FROM DIVERSION CHANNELS OR PIPES (TEMPORARY OR PERMANENT) MUST BE ROUTED TO SEDIMENTATION BASINS OR APPROPRIATE ENERGY DISSIPATERS TO PREVENT THE TRANSPORT OF SEDIMENT TO OUTFLOW OR LATERAL CONVEYORS AND TO PREVENT EROSION AND SEDIMENT BUILDUP WHEN RUNOFF FLOWS INTO THE CONVEYORS.
- 11. A CONCRETE WASHOUT SHALL BE INSTALLED ON PROJECTS THAT REQUIRE THE USE OF CONCRETE. ALL LIQUID AND SOLID WASTES GENERATED BY CONCRETE WASHOUT OPERATIONS MUST BE CONTAINED IN A LEAK-PROOF ONTAINMENT FACILITY OR IMPERMEABLE LINER. A SIGN MUST BE INSTALLED ADJACENT TO EACH WASHOUT FACILITY TO INFORM OPERATORS TO UTILIZE THE PROPER FACILITIES.
- 12. ALL SEDIMENT CONTROL MEASURES SHALL BE USED AND MAINTAINED FOR THE DURATION OF THE PROJECT UNTIL FINAL STABILIZATION HAS BEEN ACHIEVED ACCORDANCE WITH SECTION C EROSION CONTROL REQUIREMENTS. IF CONSTRUCTION OPERATIONS OR NATURAL EVENTS DAMAGE OR INTERFERE WITH ANY EROSION CONTROL MEASURES, THEY MUST BE RESTORED TO SERVE THEIR INTENDED FUNCTION.
- 13. ADDITIONAL SEDIMENT CONTROL MEASURES SHALL BE ADDED AS NECESSARY TO EFFECTIVELY PROTECT THE NATURAL RESOURCES OF THE CITY. THE TEMPORARY AND PERMANENT EROSION CONTROL PLANS SHALL BE REVISED AS NEEDED BASED ON CURRENT SITE CONDITIONS AND TO COMPLY WITH ALL APPLICABLE REQUIREMENTS.
- 14. RESTRICT CLEARING AND GRADING WITHIN 20 FEET OF AN EXISTING WETLAND BOUNDARY TO PROVIDE FOR A PROTECTIVE BUFFER STRIP OF NATURAL VEGETATION.

AREA SUMMARY (A	ACRES)
TOTAL PARCEL AREA	1.099
ON-SITE DISTURBED AREA	1.099
OFF-SITE DISTURBED AREA	0.00
TOTAL DISTURBED AREA	1.099
PROPOSED IMPERVIOUS AREA AT COMPLETION WITHIN PROPERTY AREA	0.819
PROPOSED PERVIOUS AREA AT COMPLETION WITHIN PROPERTY AREA	0.280

CONSTRUCTION SCHEDULE

CONSTRUCTION SEQUENCE STARTING AND COMPLETION DATES INITIAL EROSION CONTROL BMPS INSTALLATION INTERMEDIATE EROSION CONTROL BMPS FINAL PHASE E&SC BMPS MAINTENACE OF E&SC PRACTICES DEMOLITION INSTALLATION / REMOVAL OF TEMPORARY SEDIMENT BA RETROFITTING OF DENTENTION POND (N/A)CLEARING AND GRUBBING grading STORM AND SANITARY SEWER INSTALLATION PAVING BUILDING CONSTRUCTION TEMPORARY GRASSING @ 14 DAY INTERVALS PERMANENT GRASSING @ 30 DAY INTERVALS REMOVAL OF TEMPORARY BMPS FINAL CLEAN-UP

																BEACON	CIVIL ENGINEERING	I AND DEVELOPMENT ENGINEERS	TAMPA FI 33626			
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BASI	_														HE INTERS	CENTRAL LES ON	AVENUE. TU	V THE MED	CTION. THE	3 1/4 INCH ALBUQUERQUE 3 1/4 INCH ALUMINUM DISC	SH WITH TH	
														BENCH MARKS	ON FROM T	EVARD AND 8TH 0.45 MII	O LOMAS /	STATION IN	IE INTERSE	1 Y UF ALBI /4 INCH AL I	" SET FLUS	
														BEN	THE STATIC	NAY BOULE RAVEL NOF	AVENUE T	T AND THE		ARK IS A UI NTROL 3 1	17-J14 1983	NCRETE.
															TO REACH THE STATION FROM THE INTERSECTION	OF BROADWAY BOULEVARD AND CENTRAL AVENUE, TRAVEL NORTH 0.45 MILES ON	BROADWAY AVENUE TO LOMAS AVENUE. TURN	8TH STREET AND THE STATION IN THE MEDIAN ON	THE WEST SIDE OF THE INTERSECTION. THE	STATION MARK IS A CITY OF ALBUQUERQUE SURVEY CONTROL 3 1/4 INCH ALUMINUM DIS	STAMPED "17-J14 1983" SET FLUSH WITH THE TOP	#27436 OF THE CONCRETE.
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BE PLACED IN THIN, HO TO AT LEAST 98% OF 98). A FLORIDA REGIST COMPACTION PRIOR TO OTINGS OF ANY TYPE. VEMENTS AND SLAB-C	TER OF THE PIPE, IF A DRIZONTAL LOOSE LIFTS F THE STANDARD PR TERED PROFESSIONAL S THE INSTALLATION OF COMPACTION OF THE DN-GRADE SHOULD BI	S, MAXIMUM 6 INCHES, OCTOR MAXIMUM DRY SOILS ENGINEER SHALL F PAVEMENTS, CURBS, UPPER 8 INCHES OF E COMPACTED TO AT		PROTES	A. H MEJ 27436 27436	ENGI	The ER THINK THE THE		A. HANNA, PE #27436
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APE PLAN FOR REQUIRED LOPES SHALL BE A MINI		COVER PLANTINGS.			ΒY				
AND BACKFILL OPERA ANDARDS. <mark>SEE SHEET C</mark> A	F 5.00% UNLESS A F L NOTIFY ENGINEER OF ESSIBLE STANDARDS AI ATIONS SHALL COMF	RE MET. PLY WITH GOVERNING				DATE:	DATE:	DATE:	DATE:
4.3 FOR DETAILS. S SUBJECTED TO VEHI DS.		MEET H-20 TRAFFIC			DESCRIPTION CONTRACTOR:				
AND PROTECTION NC Shall Maintain Acce Dings under construc Buildings with sprink The fire department	ESS FOR EMERGENCY CTION WITH A MINIMUM LER OR STANDPIPE S	I WIDTH OF 20 FT. YSTEMS SHALL BE					BY:		
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<u>AIN</u> ood zone "x" per 336h, dated 8/16/2012	MELLING	GRADING	; PL	AN					
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			SHEET	Г NO. (C-4	.0			

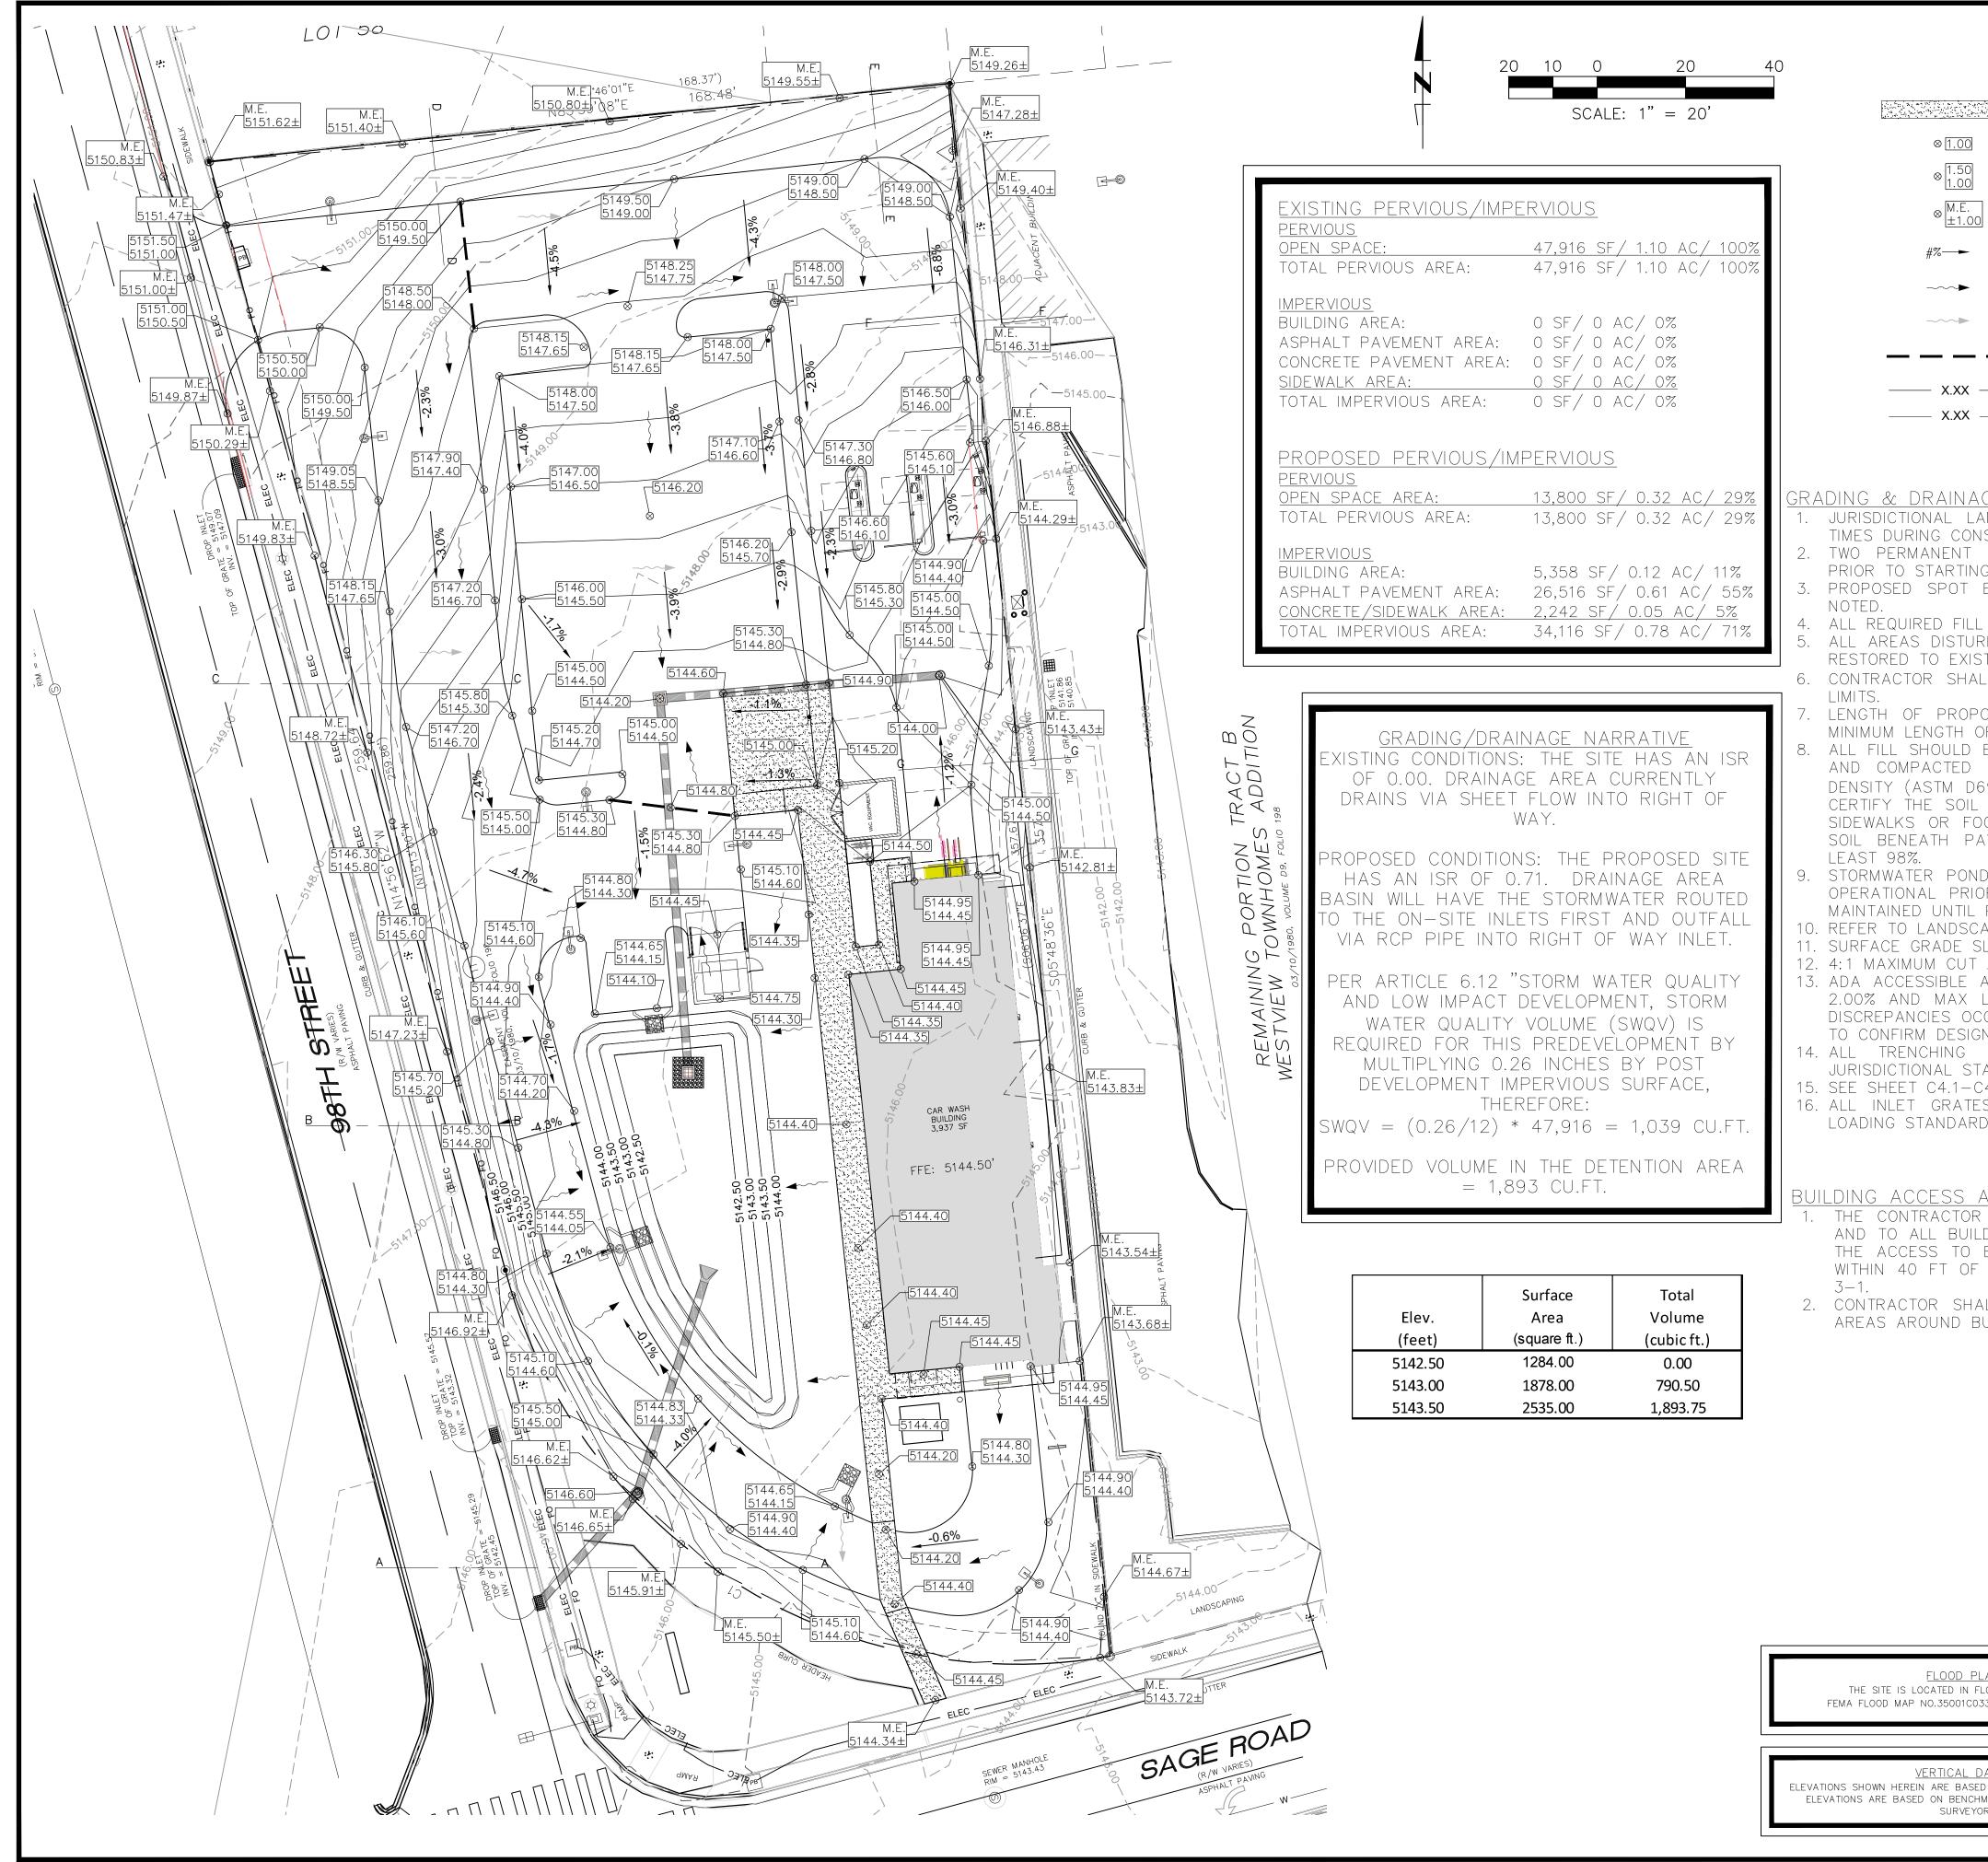- EXISTING DIRECTIONAL DRAINAGE FLOW ARROW
- DIRECTIONAL DRAINAGE FLOW ARROW
- PROPOSED SLOPE INDICATOR
- MATCH EXISTING ELEVATION
- PROPOSED TOP OF CURB/BOTTOM OF CURB SPOT ELEVATION


- <u>LEGEND</u> ADA PARKING STALLS. 2% MAX SLOPES IN ALL DIRECTIONS PROPOSED SPOT ELEVATION

BEACON CIVILENGINEERING

) DEVELOPMENT ENGINE 8345 GUNN HIGHWAY TAMPA, FL 33626


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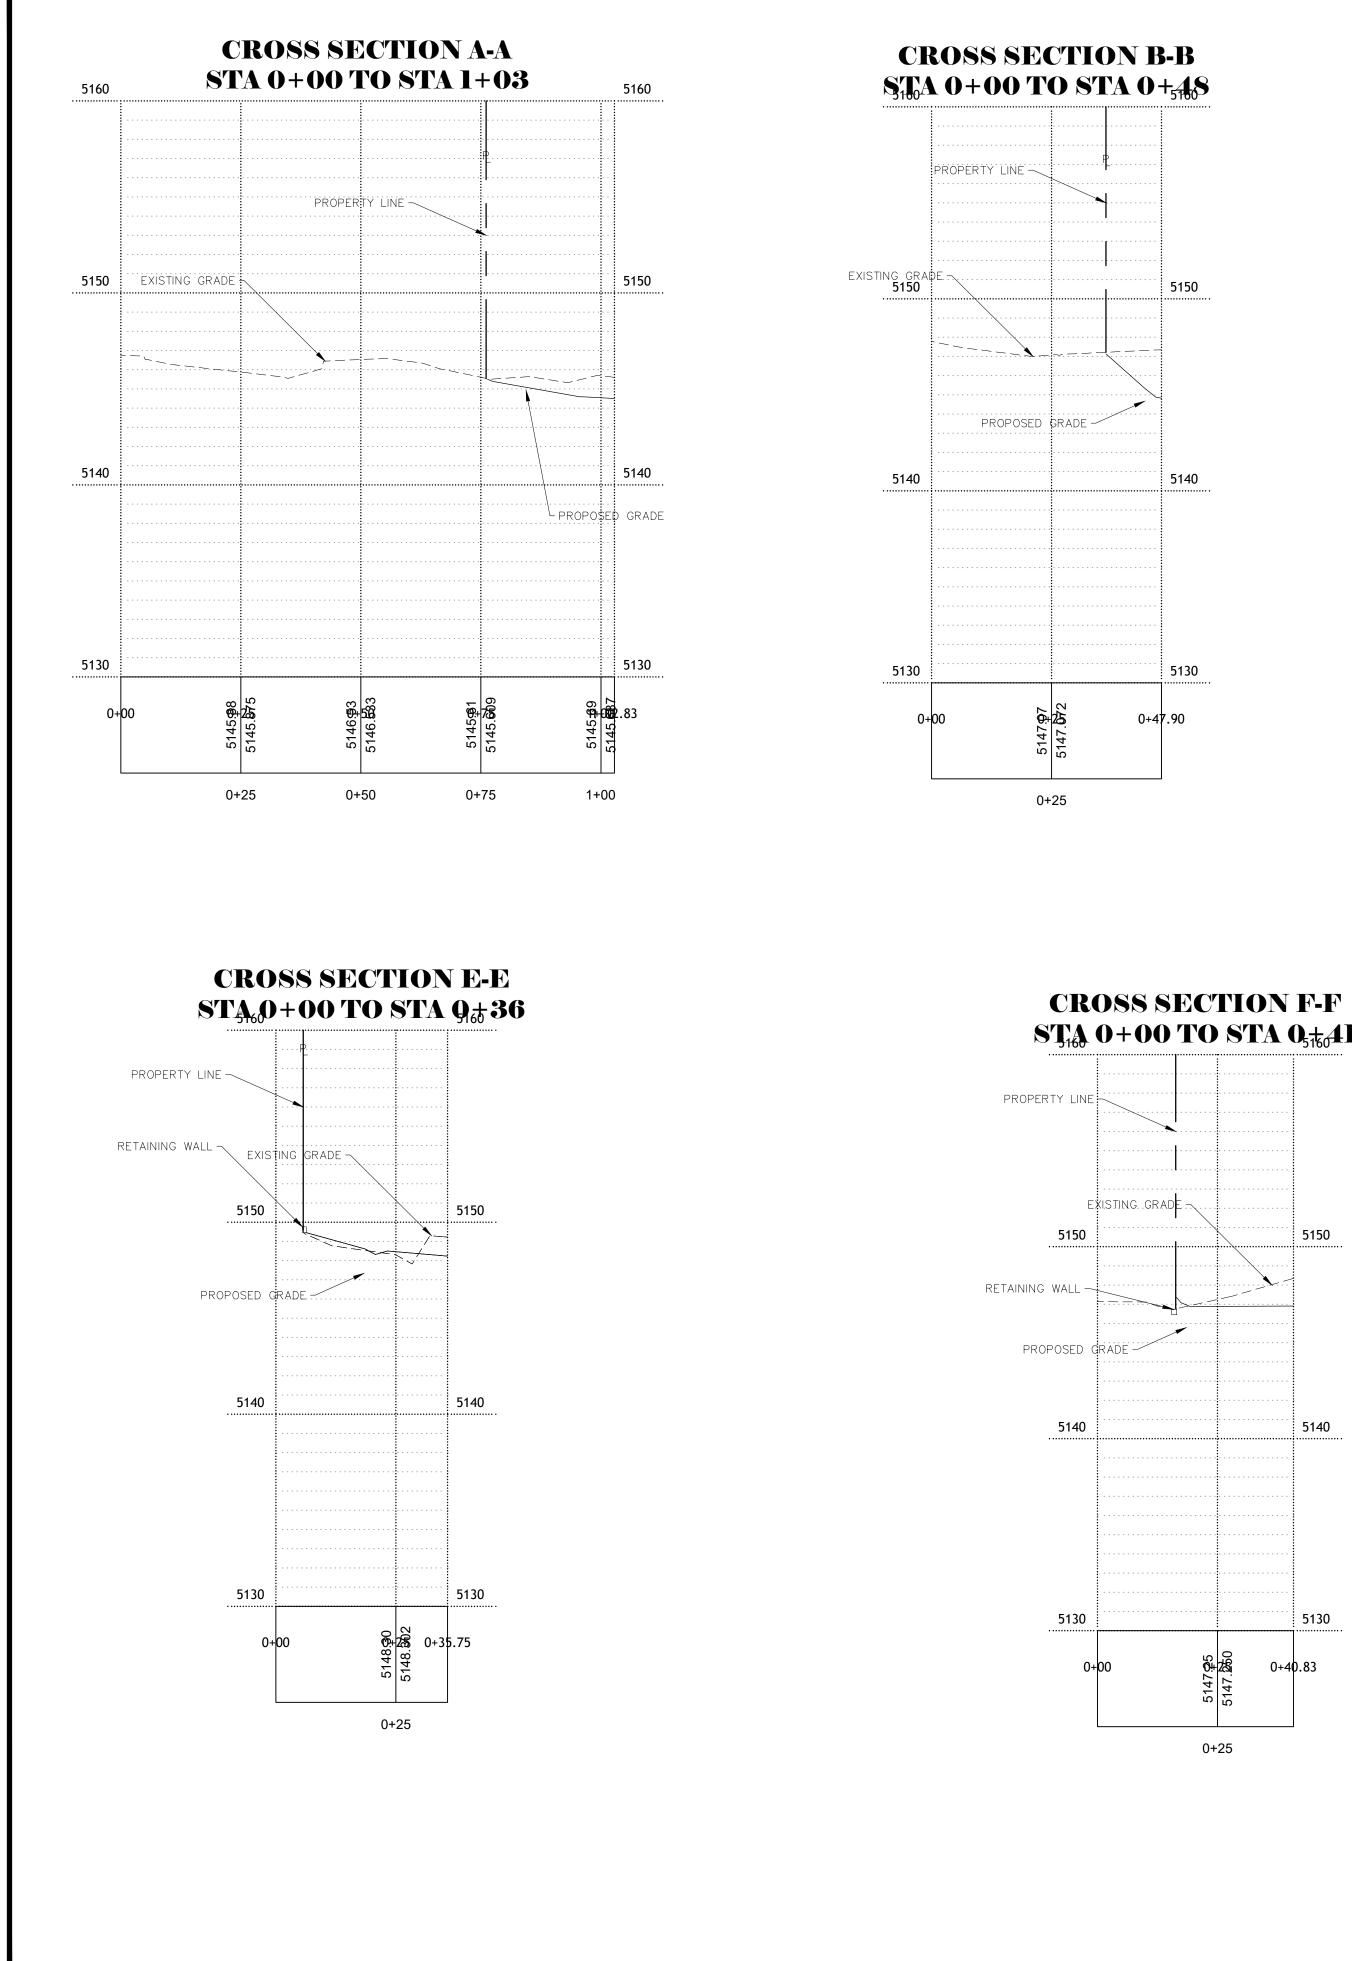
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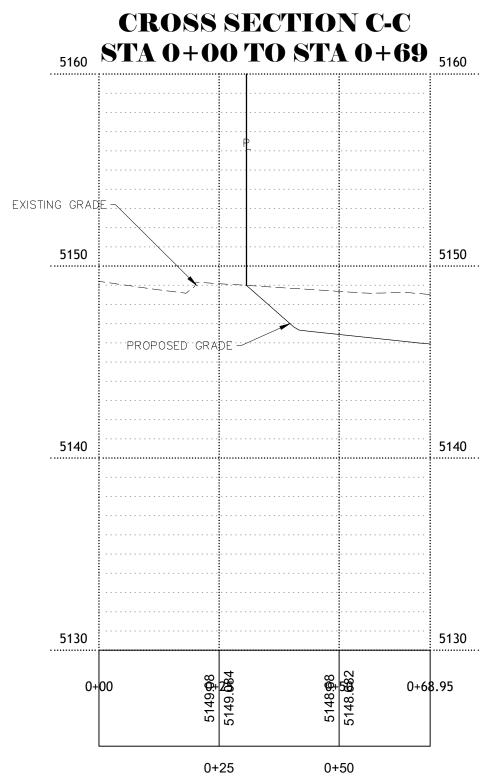


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CTIONAL ST EET C4.1-C LET GRATE	ANDARDS. S 24.3 FOR DE S SUBJECTE	<mark>See sheet c4.2 f</mark> Tails. Ed to vehicle	FOR PIP	E TRENCH	HING DETAIL	S	10	A B B B B B B B	LEFT	8TH THE	STAT	ST ST	#27436 0F
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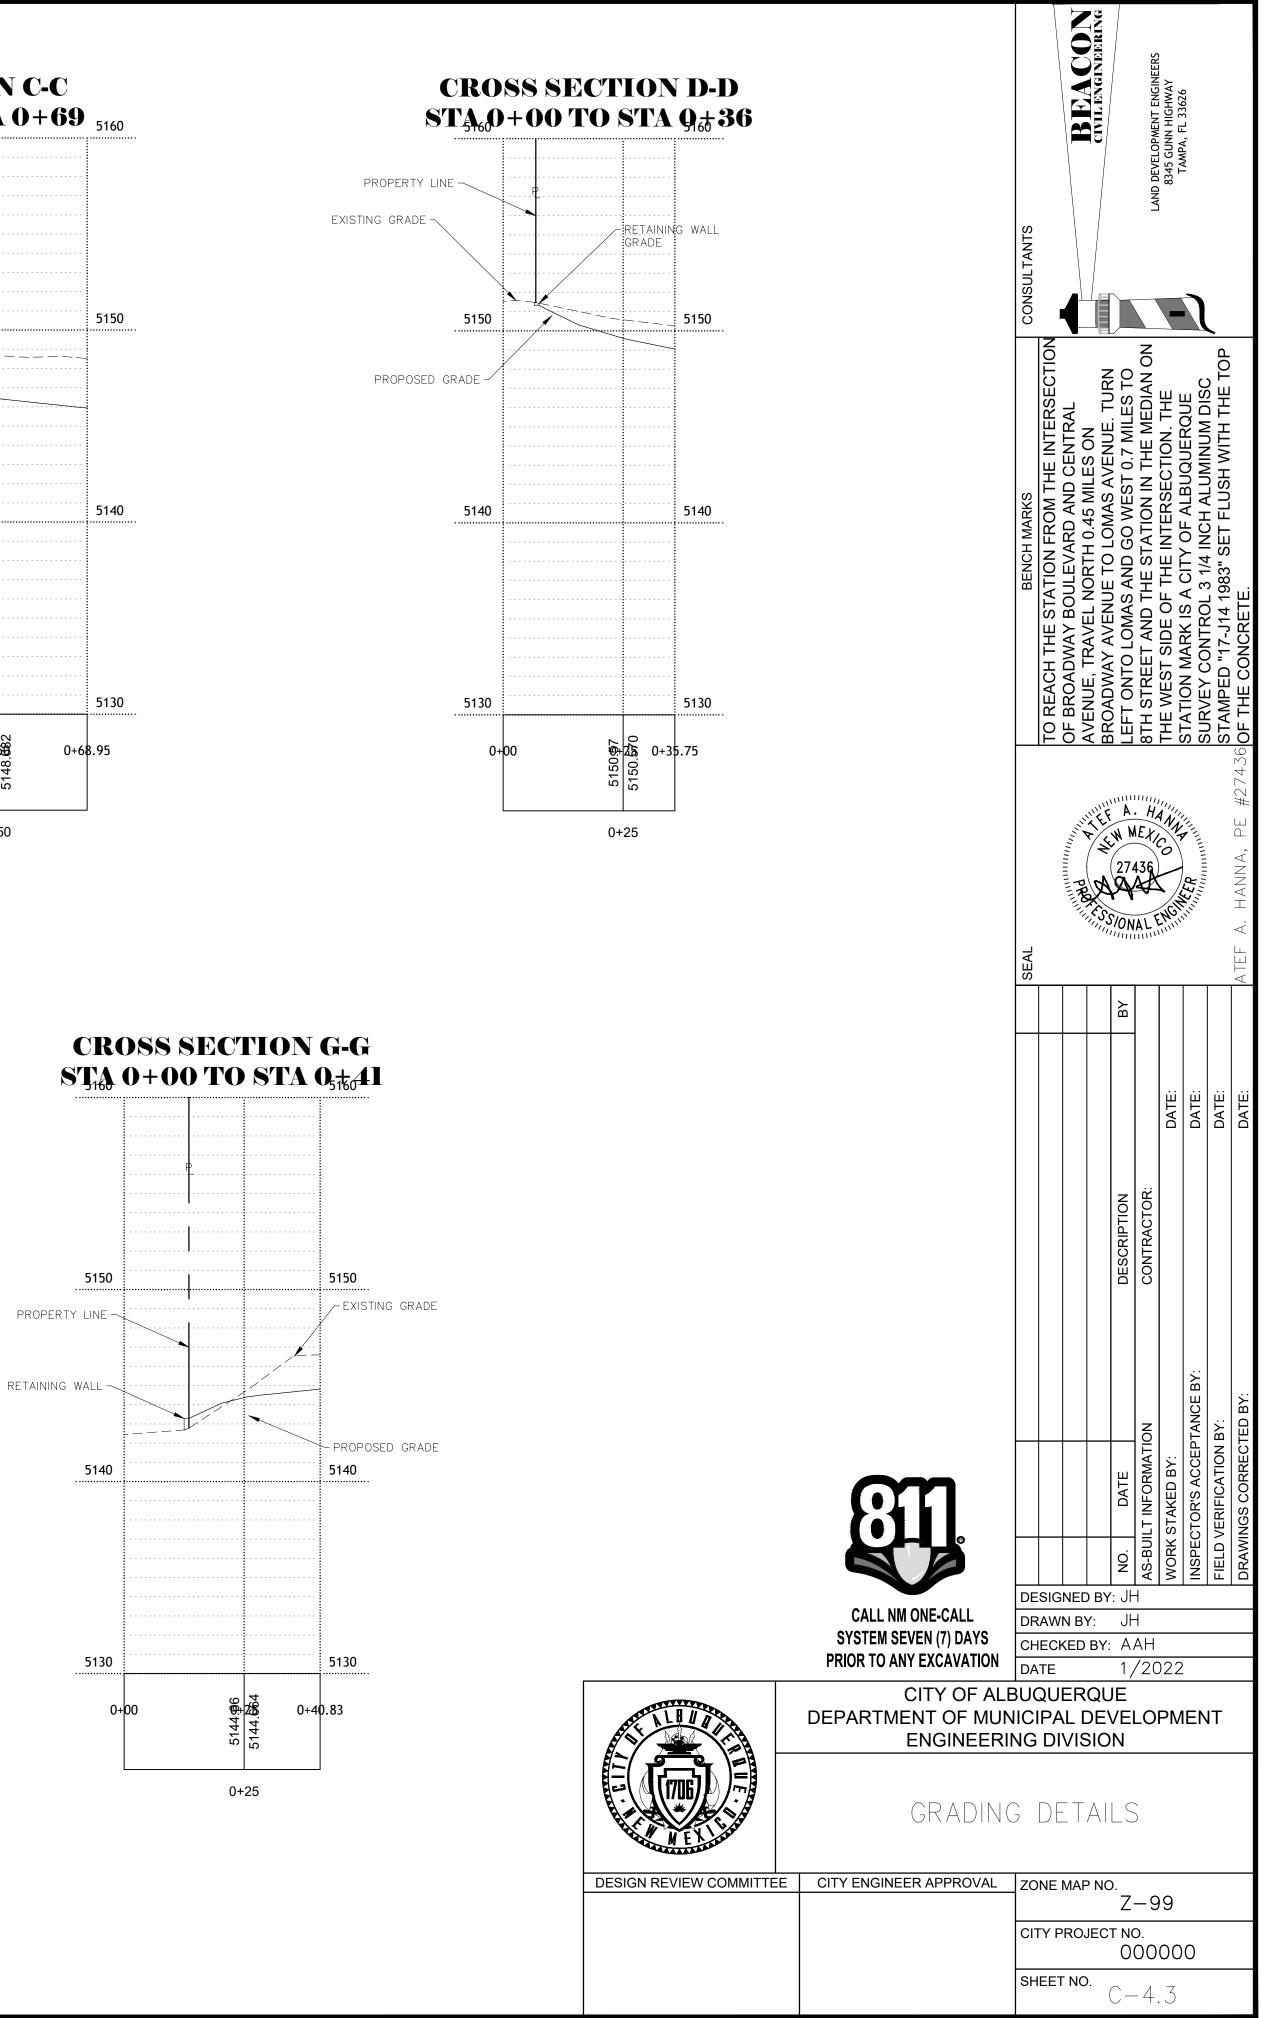


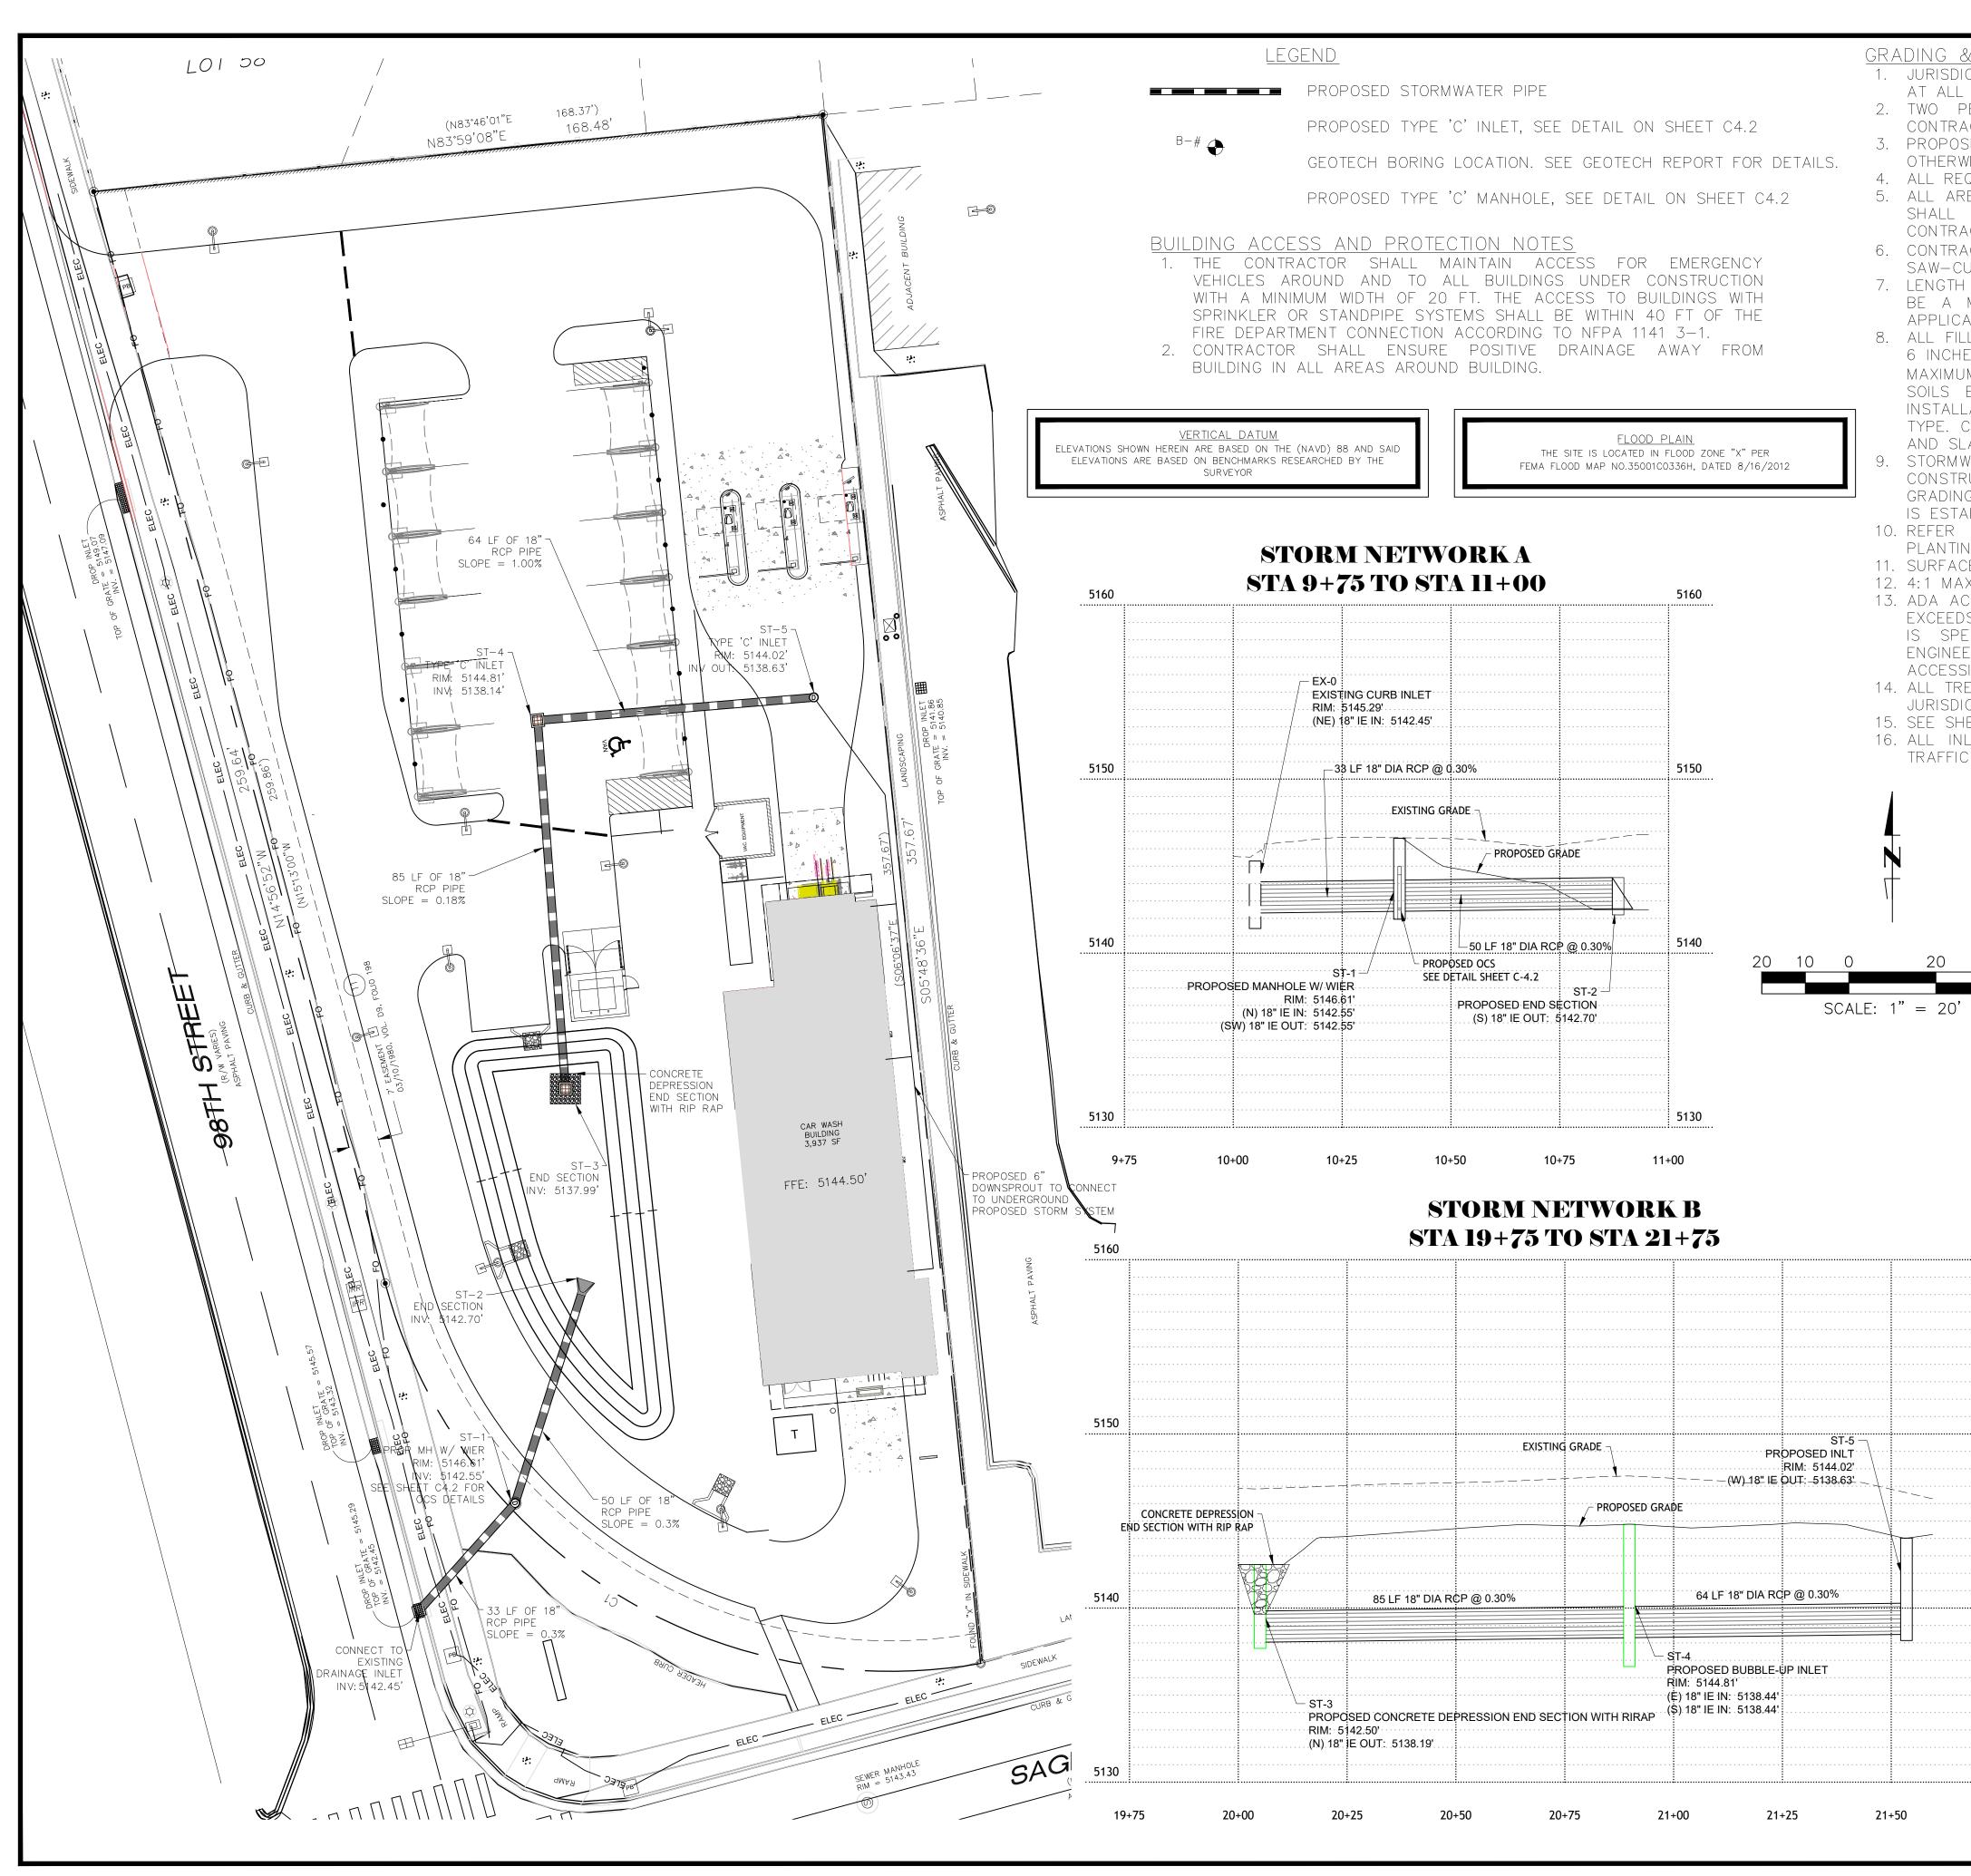




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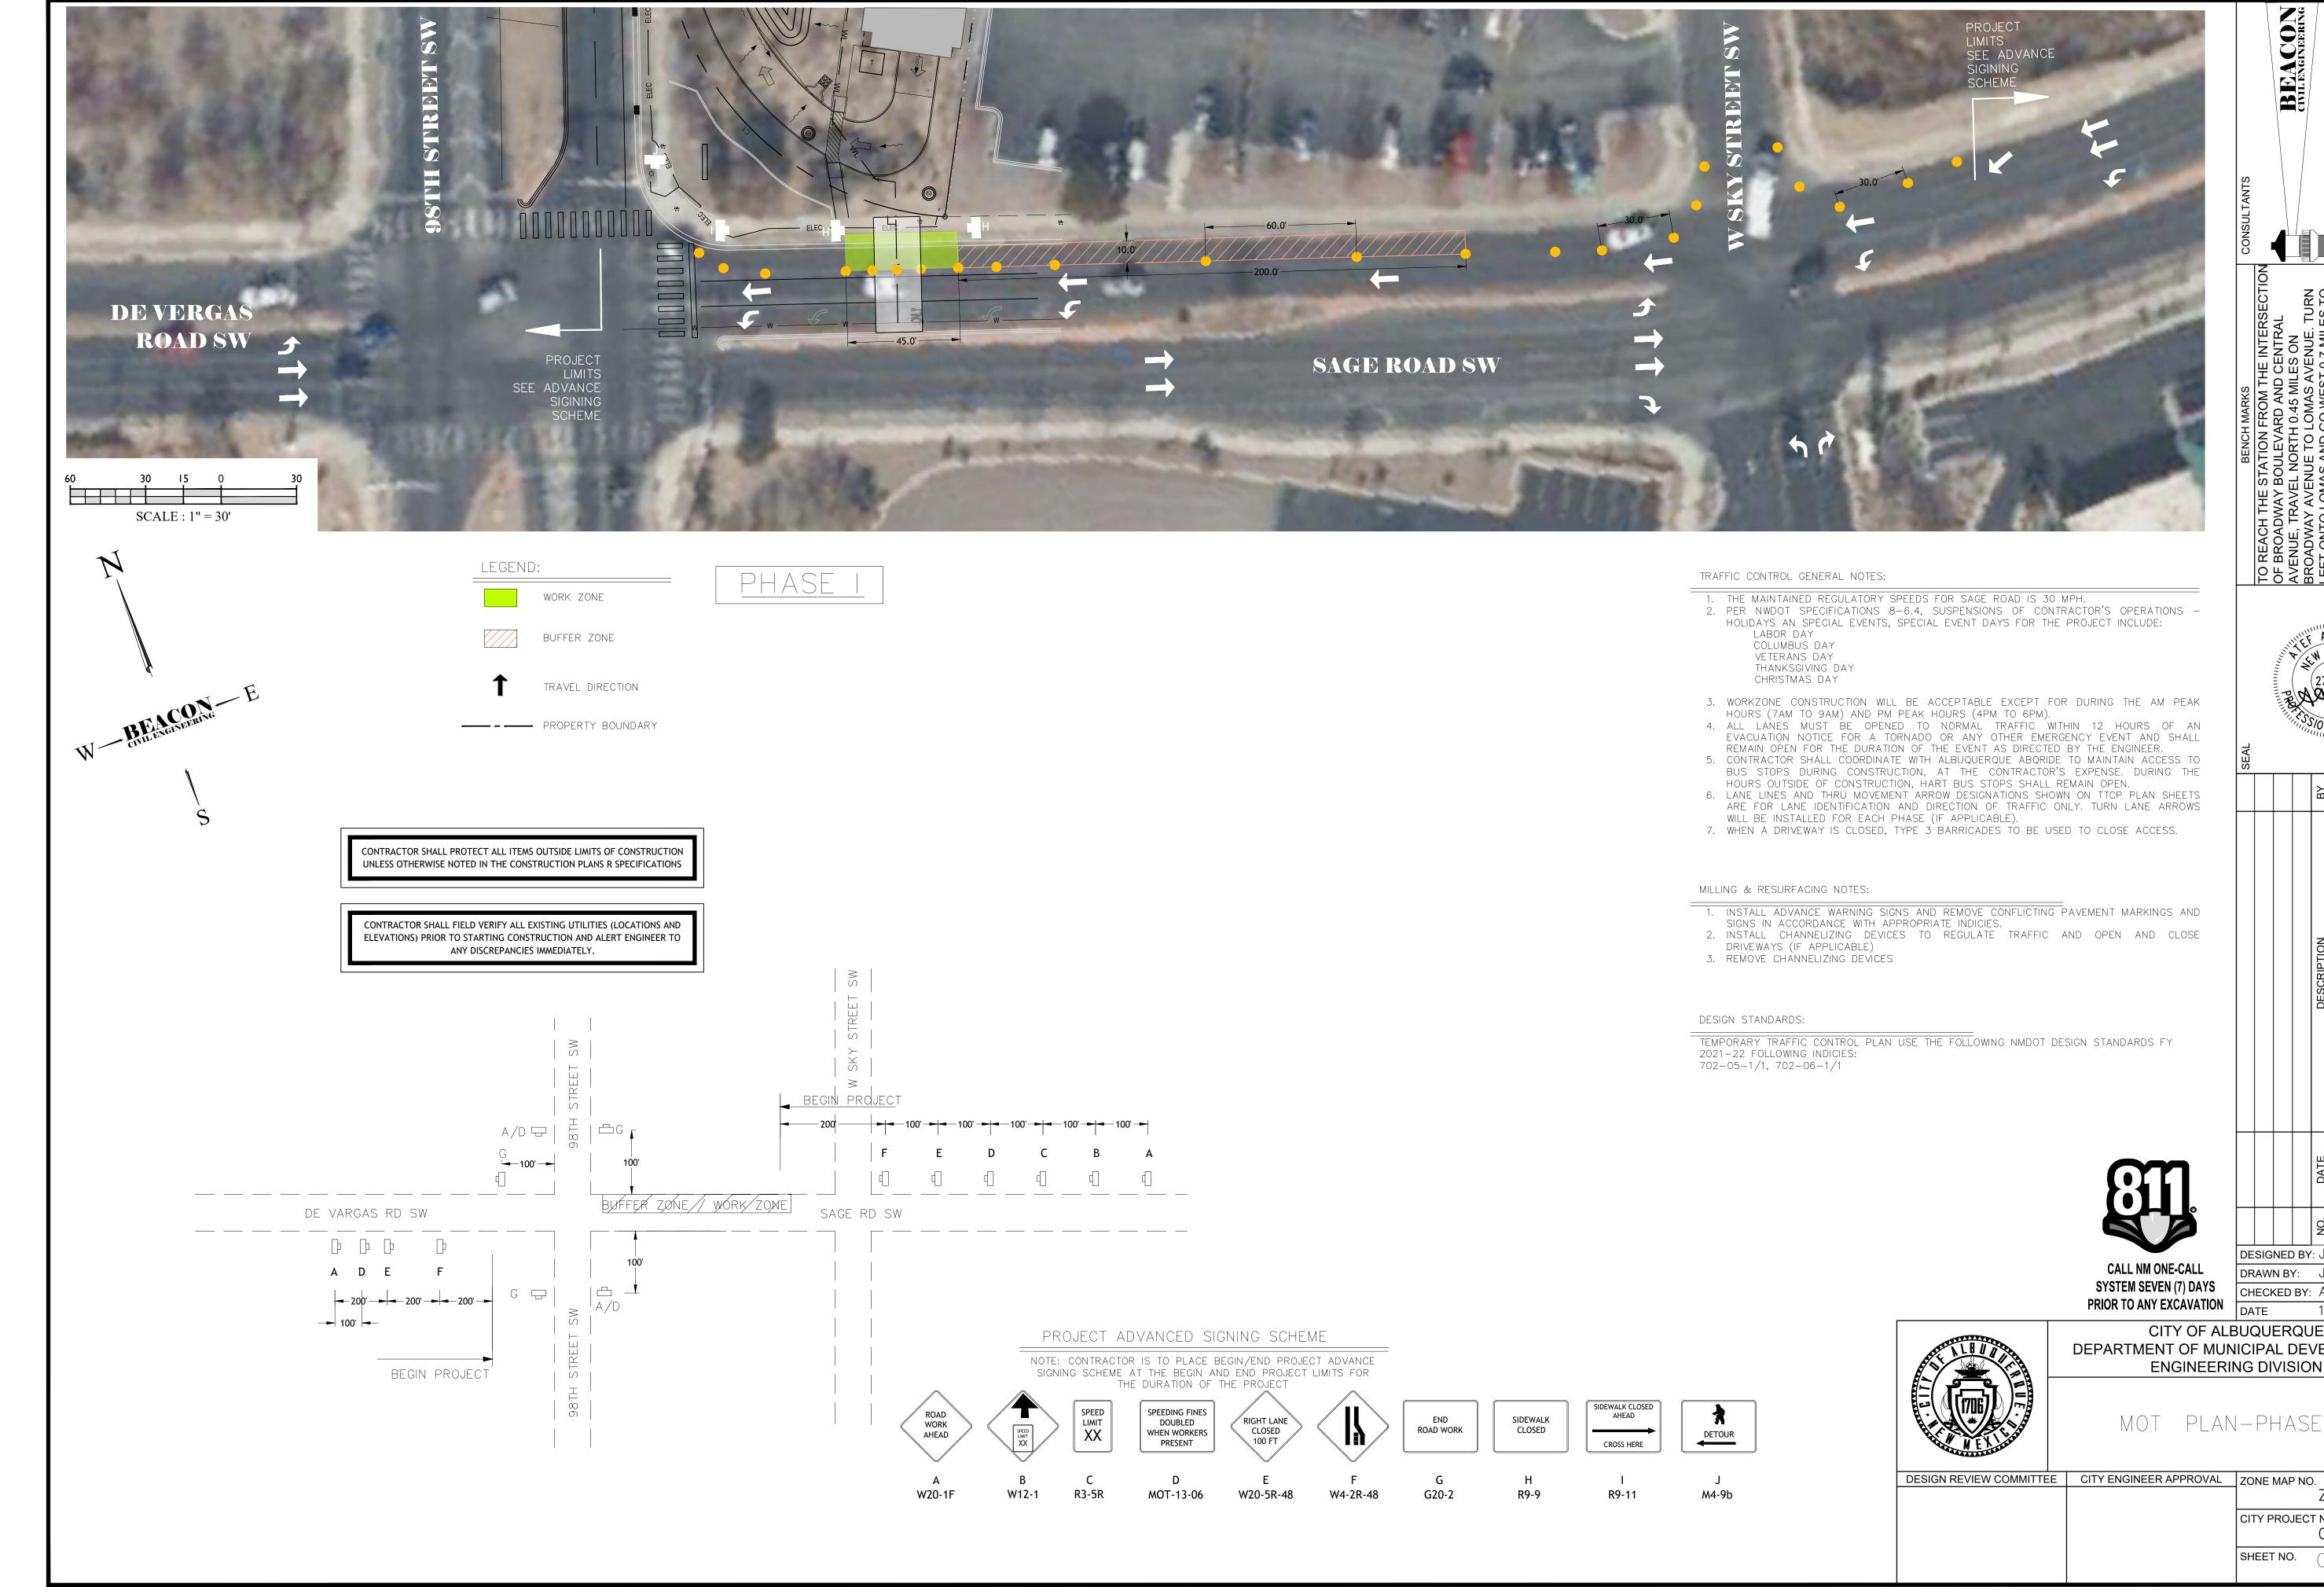


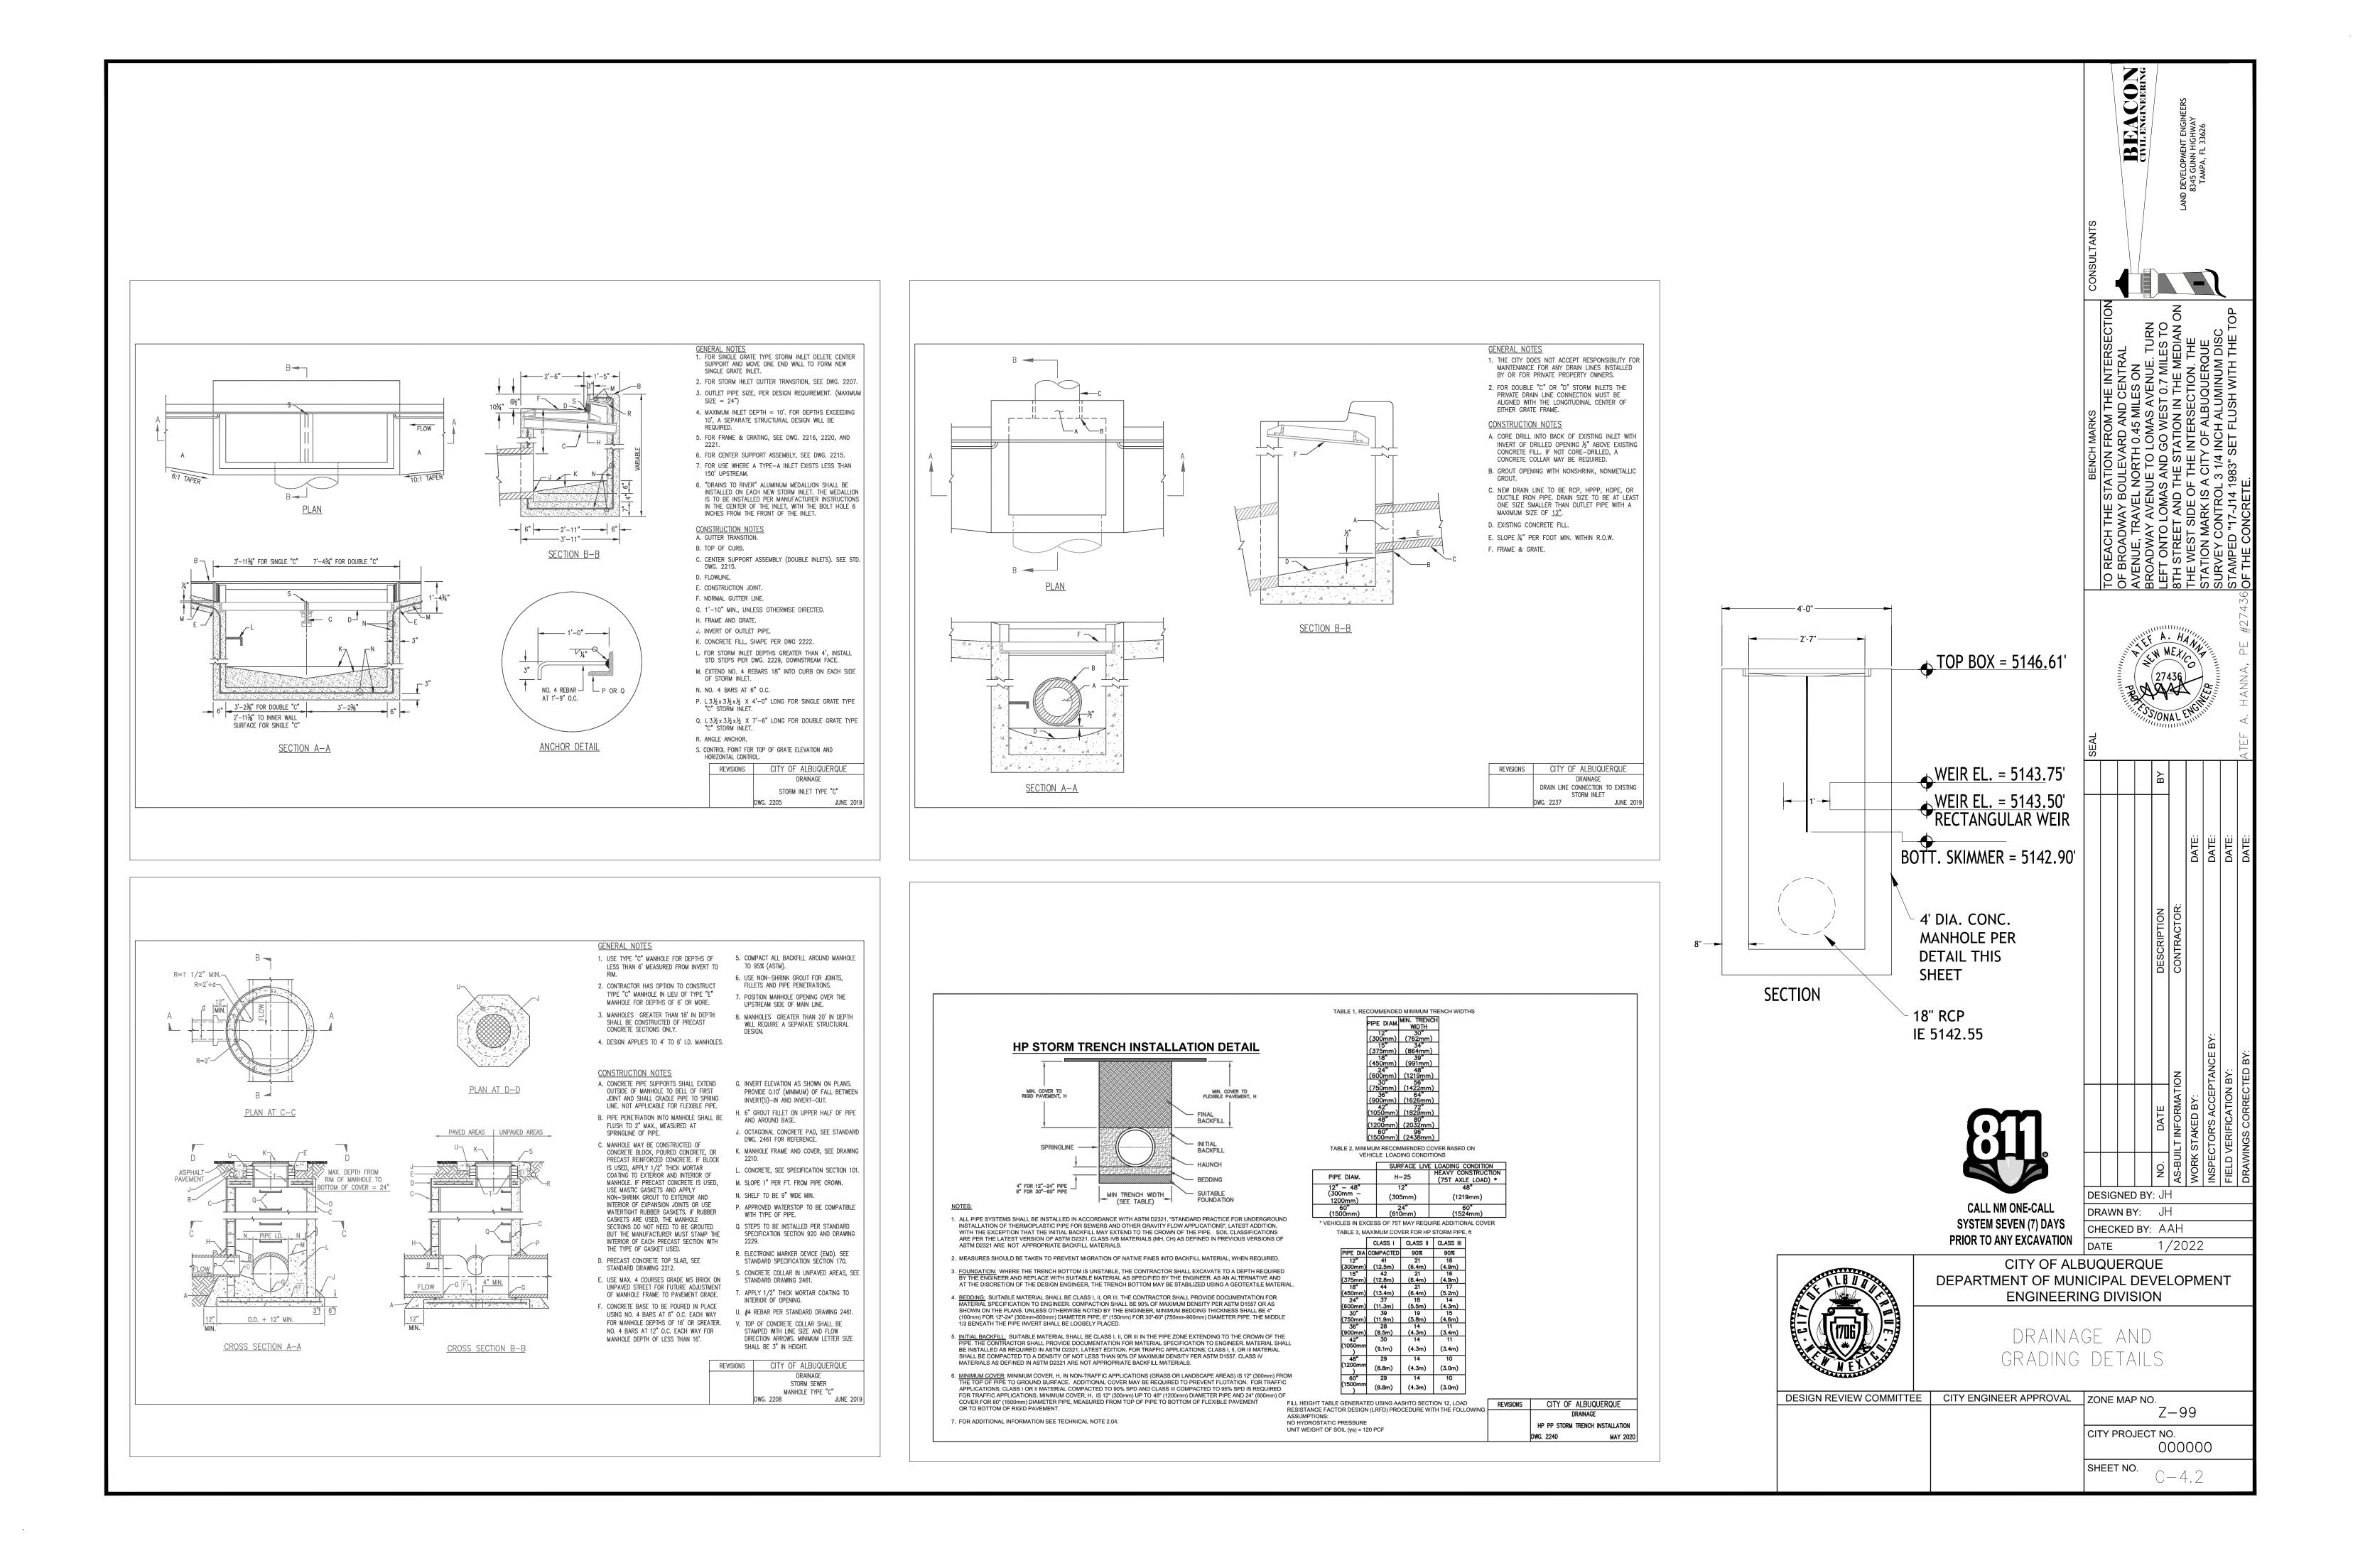

AND PROPOS STRUCTURE
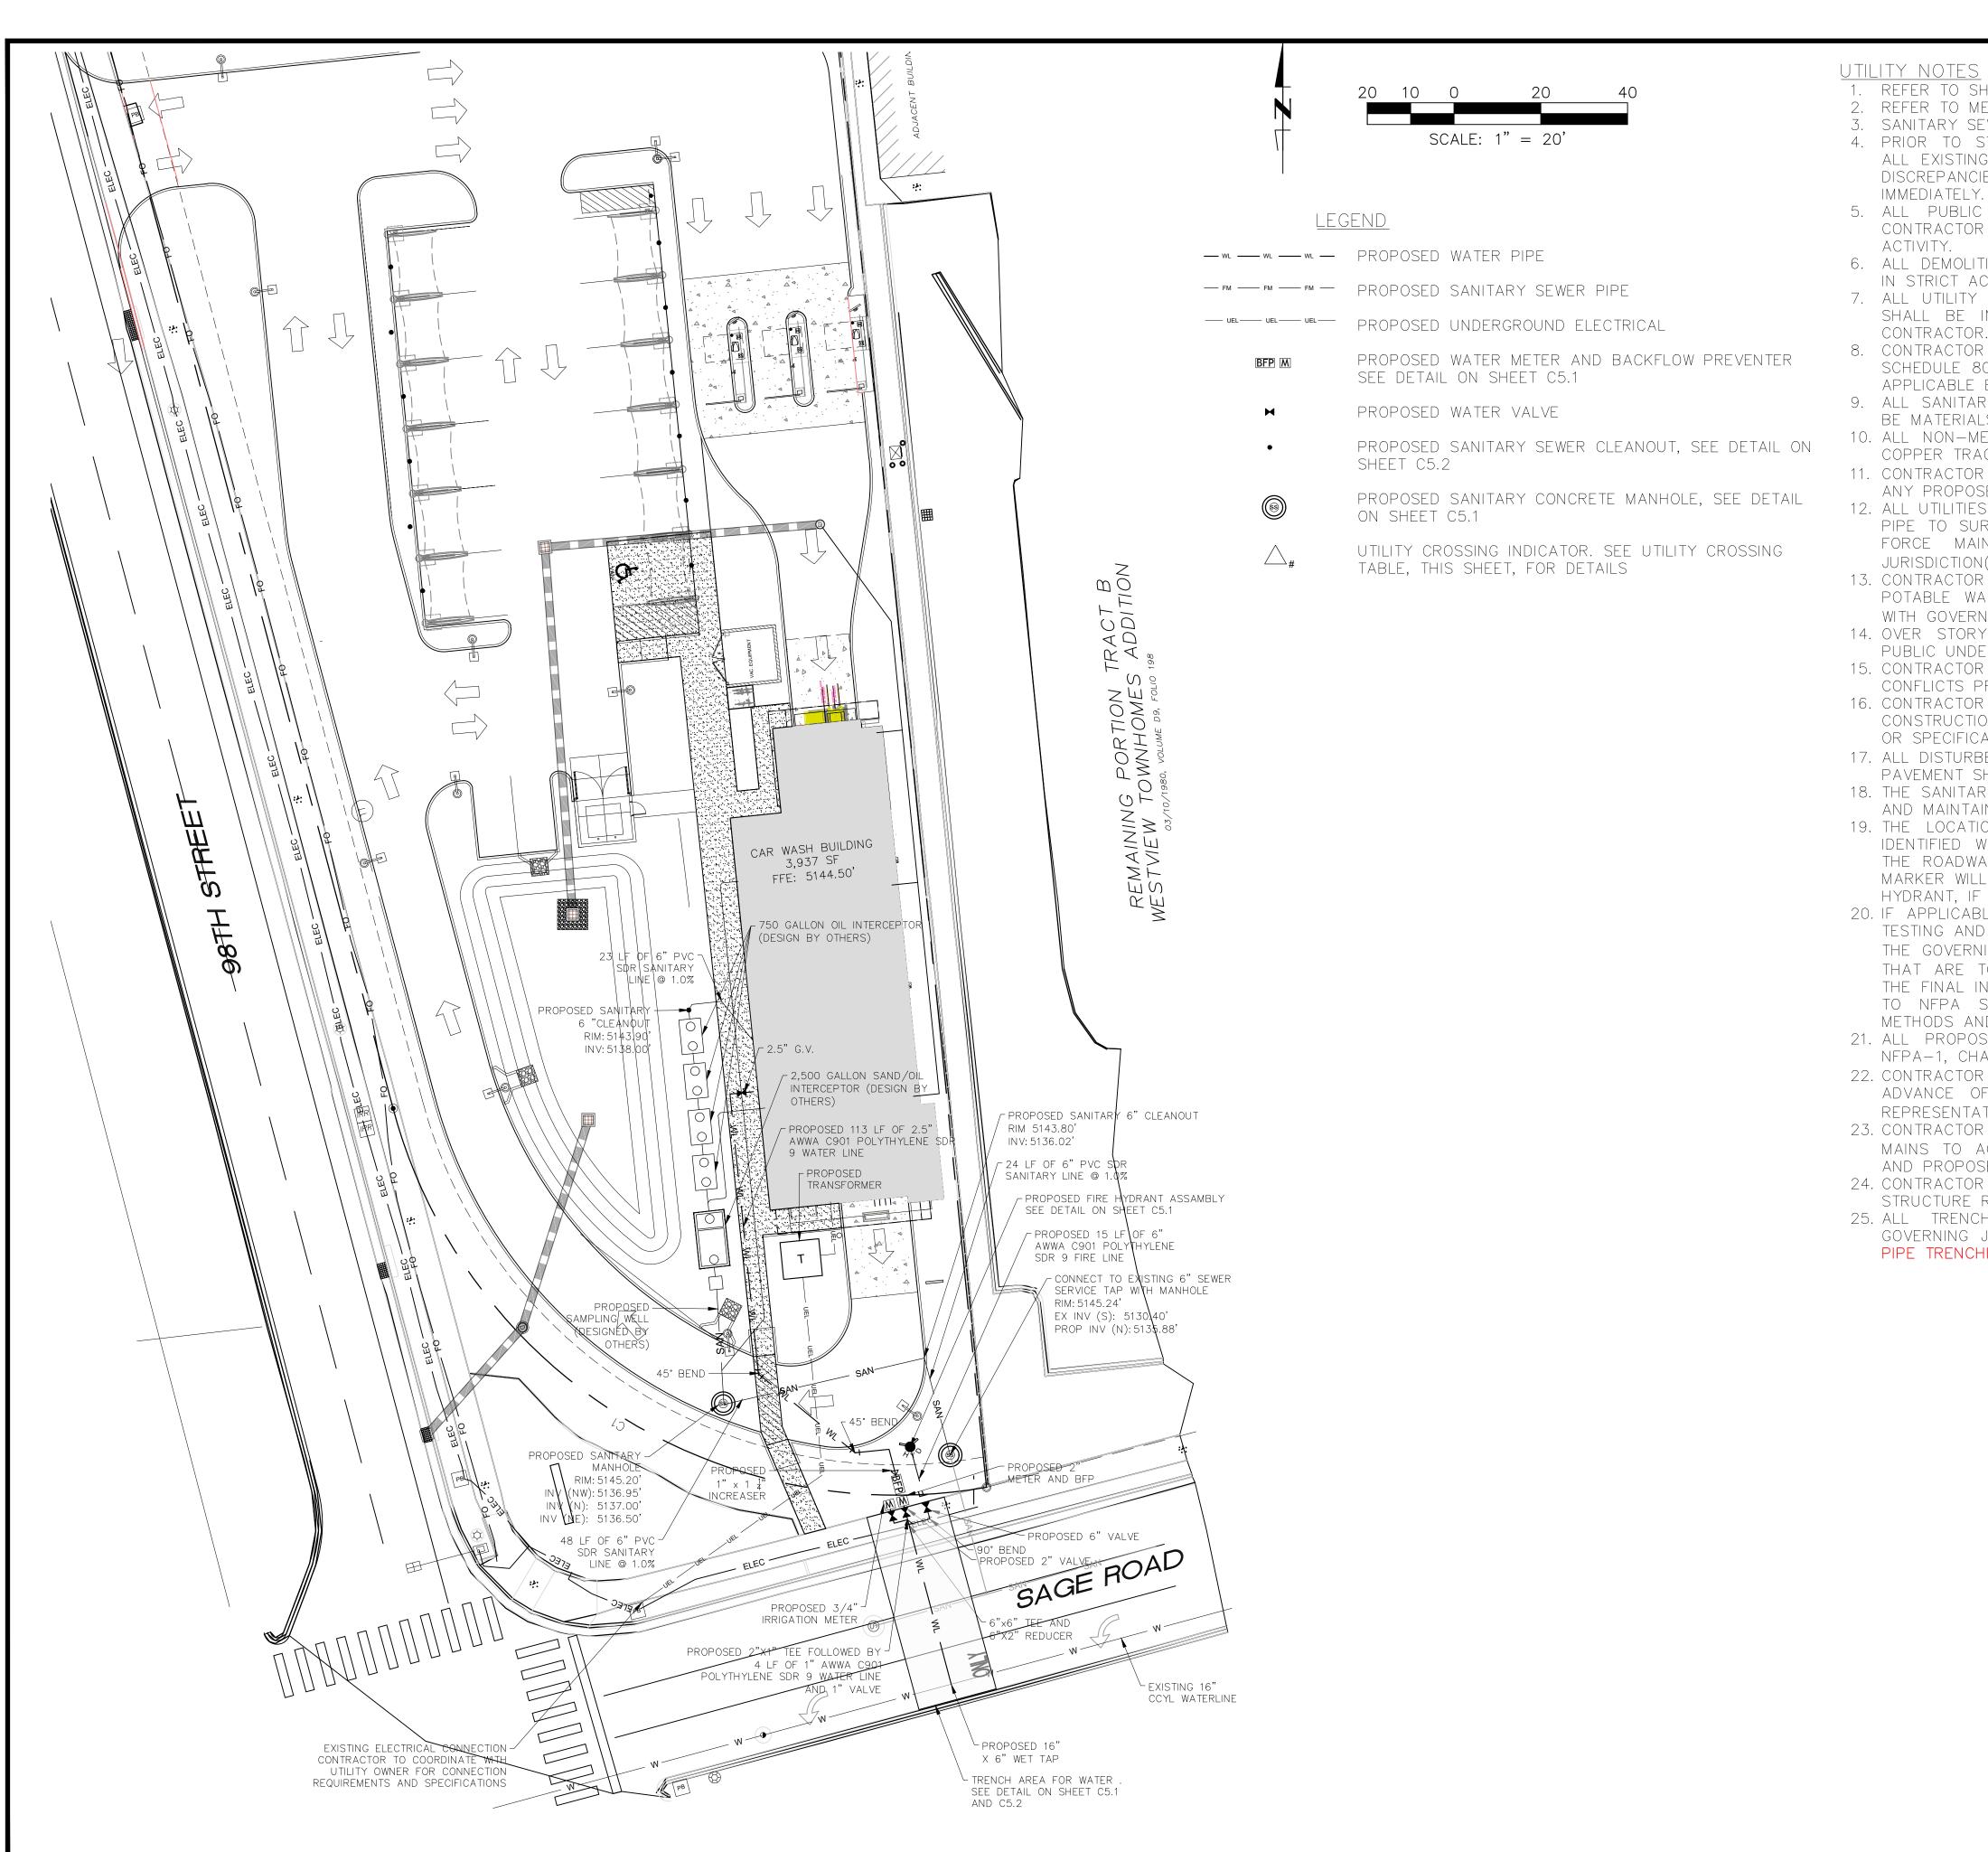
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EP PLANS FOR ALL WER PIPES SHALL STARTING CONSTRU G UTILITIES AND T ES OCCUR, THE UTILITIES INSPE AT LEAST 72	CTIONS SHALL BE HOURS PRIOR TO JCTION WORK PERFOR GOVERNING JURISDICTION AL FOR TELEPHONE, (BUILDING. DPE OF 1.00%. SHALL FIELD VERIFY ELEVATIONS. IF ANY LL ALERT ENGINEER SCHEDULED BY THE ANY CONSTRUCTION	CONSULTANTS	BRACON	CIVIL ENGINEERING	LAND DEVELOPMENT ENGINEERS	8345 GUNN HIGHWAY TAMPA FI 33676			
0 PVC CONDUIT A BY ELECTRIC COMI RY GRAVITY PIPES S APPROVED BY ETALLIC PIPE WILL CE WIRE. SHALL COORDIN, GED WET TAPS AND SHALL COORDIN, RFACE ELEVATION. NS AS NECESS (S) SEPARATION R MUST COORDIN ATER, WASTEWATER NING JURISDICTION (TREES SHALL I ERGROUND OR OVE SHALL VERIFY RIOR TO CONSTRU	PANY. , SERVICE LATERALS, THE GOVERNING JURISE BE INSTALLED WITH ATE WITH GOVERNING ATE WITH GOVERNING ATE WITH GOVERNING AT LEAST 3 FEET OF CONTRACTOR SHALL ARY TO ACHIEVE REQUIREMENTS. ATE THE SHUTDOWN R FORCEMAIN, OR RE S), IF NECESSARY. NOT BE LOCATED WI RHEAD UTILITY LINE. LOOP DETECTORS CTION, IF APPLICABLE. CT ALL UTILITIES	AND FITTINGS SHALL DICTION. 2 PAIR, 10 GAUGE, JURISDICTION(S) FOR COVER FROM TOP OF DEFLECT WATER AND MINIMUM GOVERNING N OF THE EXISTING CLAIMED WATER MAIN THIN 12 FT OF ANY TO AVOID UTILITY	TO REACH THE STATION EROM THE INTERSECTION		DWAY AVENUE TO LOMAS AVEI DWAY AVENUE TO LOMAS AVEI DNTO LOMAS AND GO WEST 0.7	HE STATION IN THE ME			STAMPED "17-J14 1983" SET FLUSH WIT	
ATIONS. ED AREAS WITHIN HALL BE RESTORE Y SEWER SYSTEM NED WITHIN PROPE ON OF ALL NEWI (ITH A BLUE REFI AY, PERPENDICULA BE LOCATED IN APPLICABLE. LE, THE CONTRAC	THE SIDEWALK/ CURE D TO ITS ORIGINAL OR IN ALL ITS ENTIRETY ERTY BOUNDARIES. LY INSTALLED FIRE H LECTIVE PAVEMENT M R TO THE FIRE HYDR THE CENTER OF THE L TOR WILL BE RESPON	B AND GUTTER/ ROAD BETTER CONDITIONS. IS PRIVATELY OWNED HYDRANTS SHALL BE ARKER INSTALLED ON ANT. THE REFLECTIVE ANE CLOSEST TO THE SIBLE FOR THE FLOW ED FIRE HYDRANTS IN	SEAL	PRO		. HA AEX 436	NN FO			TATEF A. HANNA, PE #2743(
ING JURISDICTION(TO BE DEDICATED NSPECTION OF THE STANDARD 291 F D PROCEDURES. SED WATER SUPP APTER 18.3 SHALL NOTIFY E F ALL INSPECTION TIVE'S PRESENCE. SHALL DEFLECT ACHIEVE 18" MIN. SED UTILITIES. SHALL ADJUST RIMS TO BE FLUSH HING AND BACK	S) RIGHT OF WAY AN TO GOVERNING JURIS PROJECT. THE CONT FOR FLOW TESTING PLY AND FIRE HYDRA NGINEER OF RECORD NS THAT REQUIRE T ALL PROPOSED WATE VERTICAL CLEARANCE TOP OF ALL CLEAN WITH FINAL GRADE. FILL OPERATIONS S	D UTILITY EASEMENTS SDICTION(S) PRIOR TO RACTOR SHALL REFER AND COLOR CODING ANTS SHALL COMPLY (E.O.R.) 72 HOURS IN HE E.O.R. OR E.O.R.			DESCRIPTION BY	CONTRACTOR:	DATE:	DATE:	DATE:	DATE
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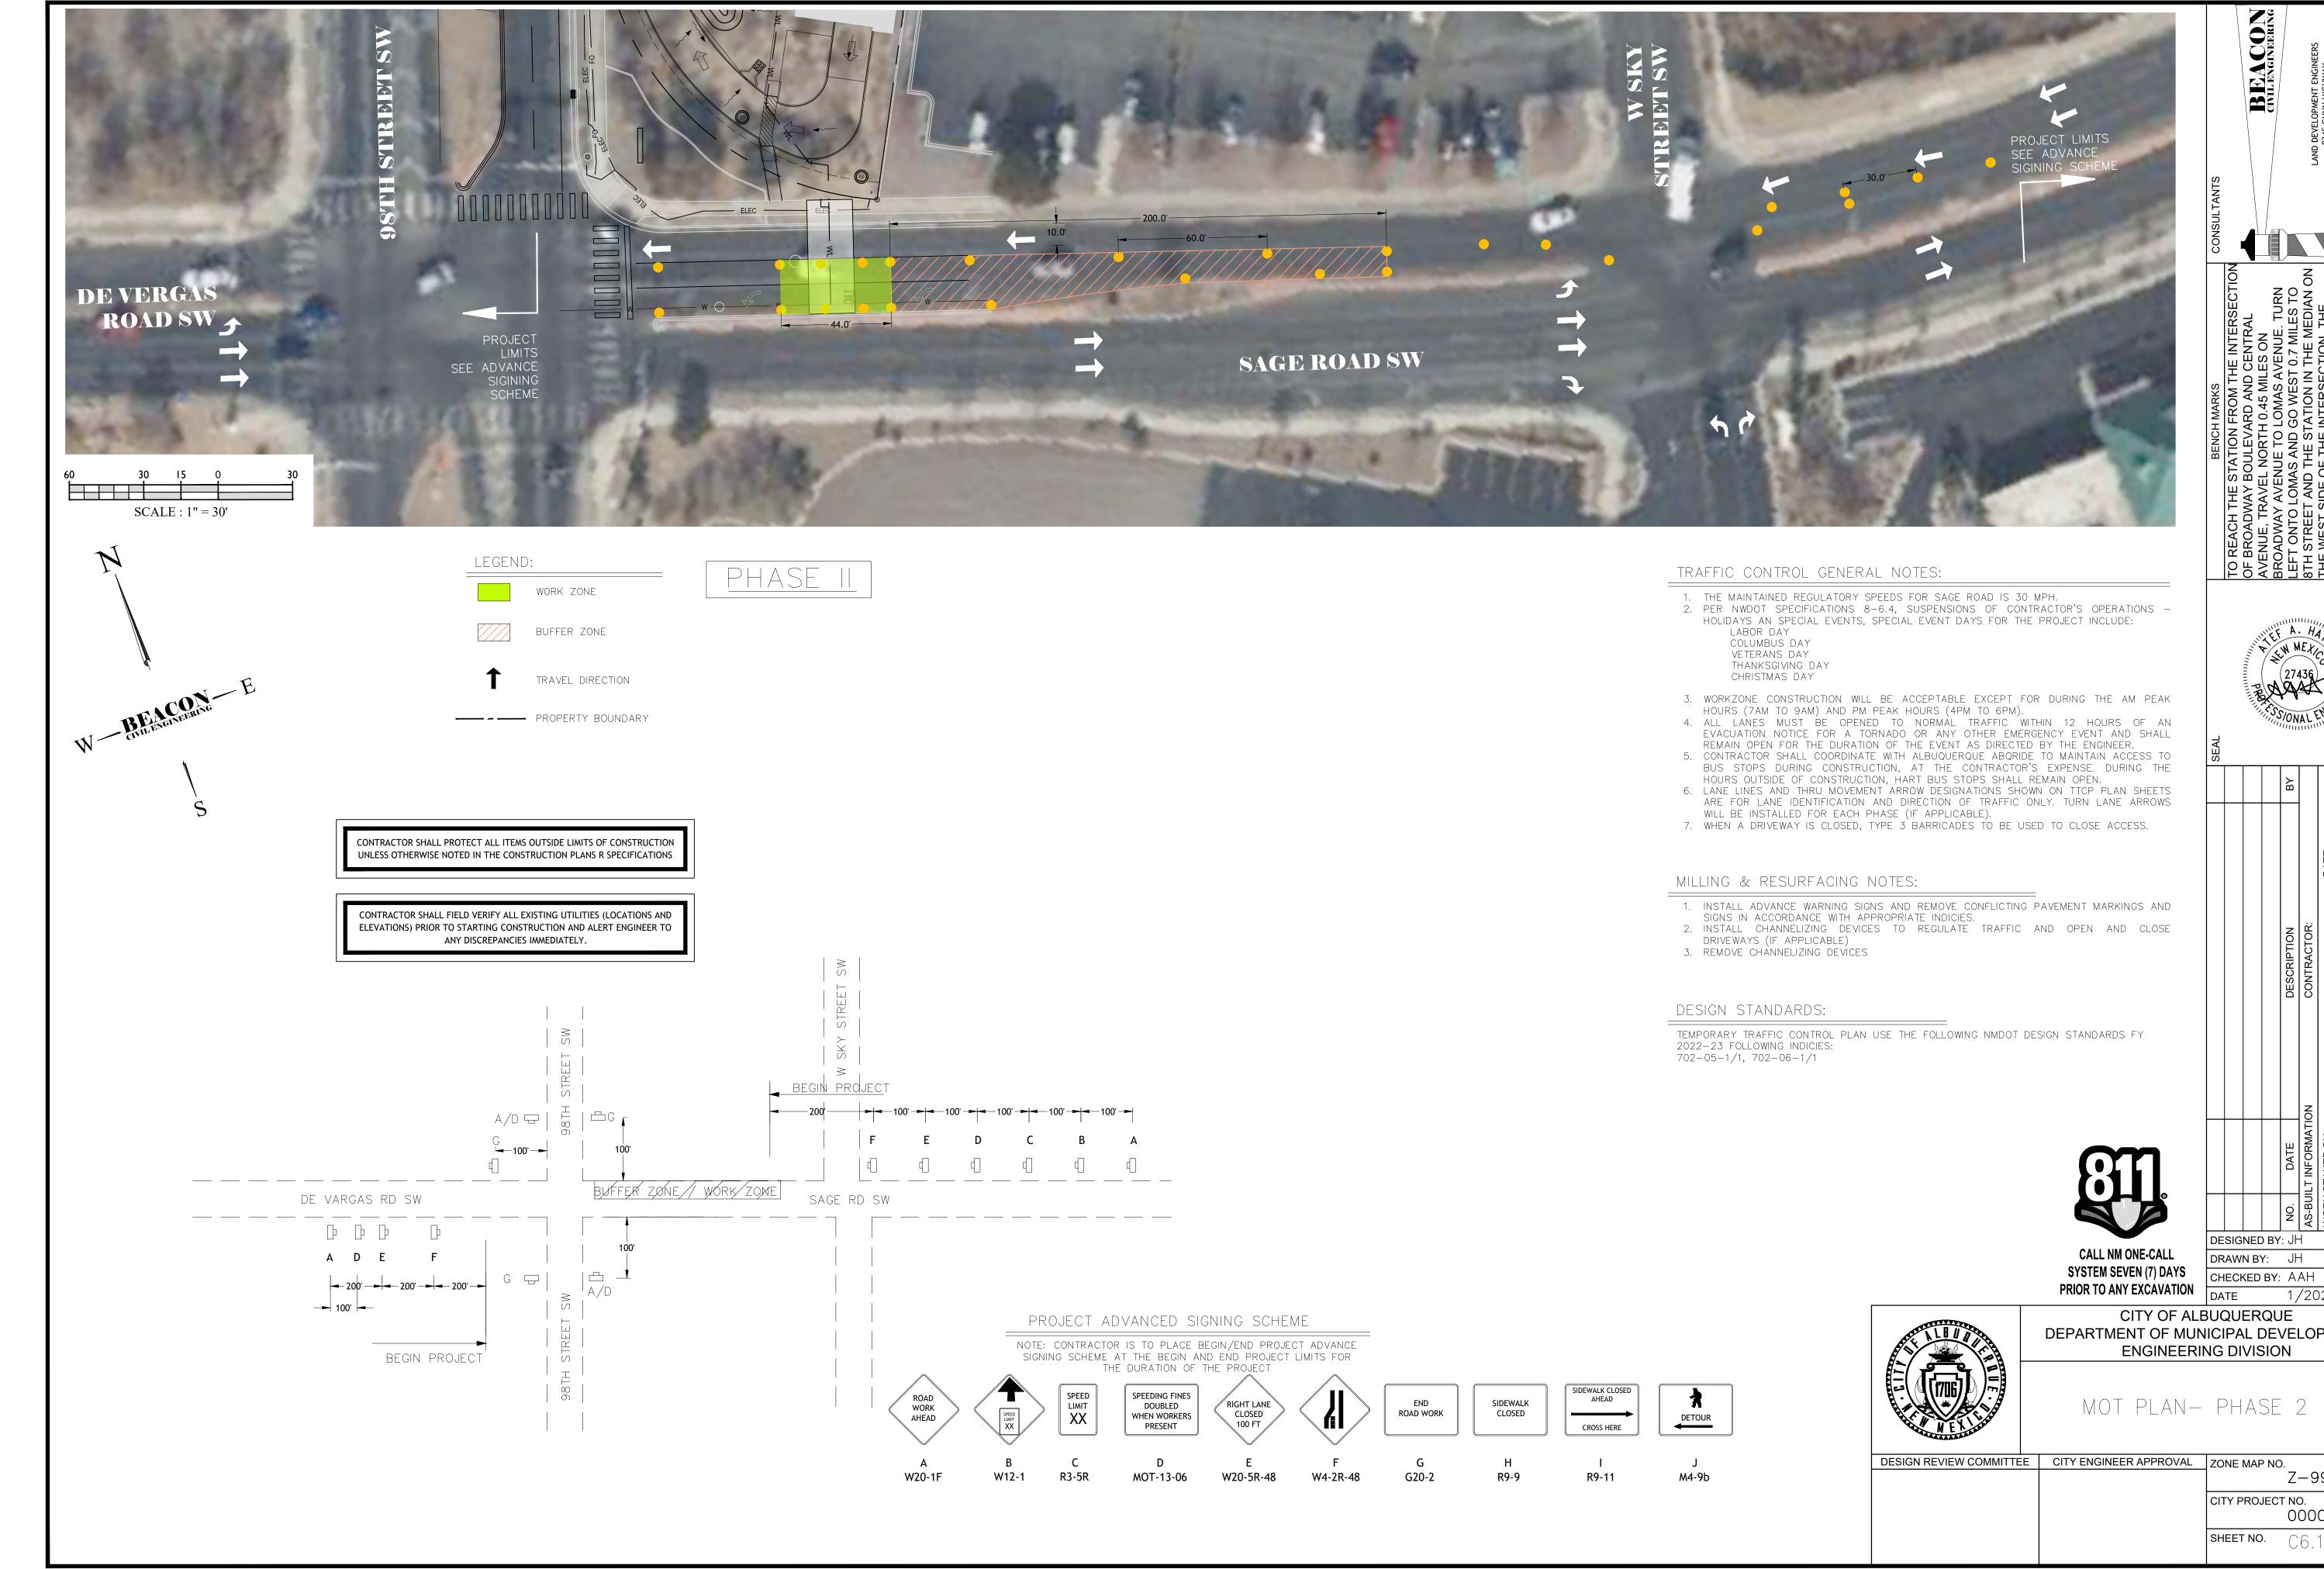
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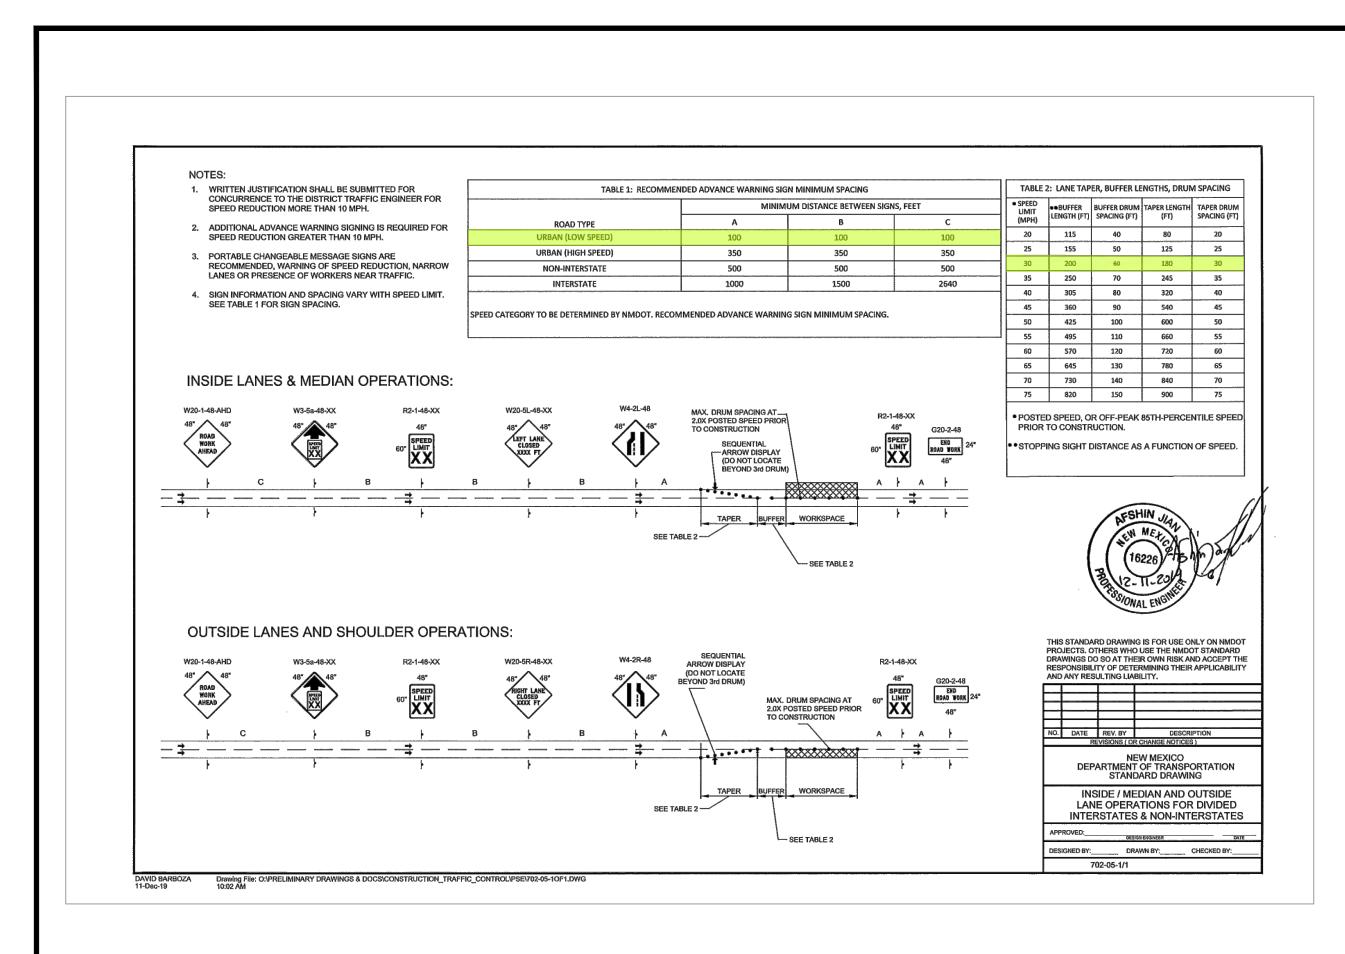
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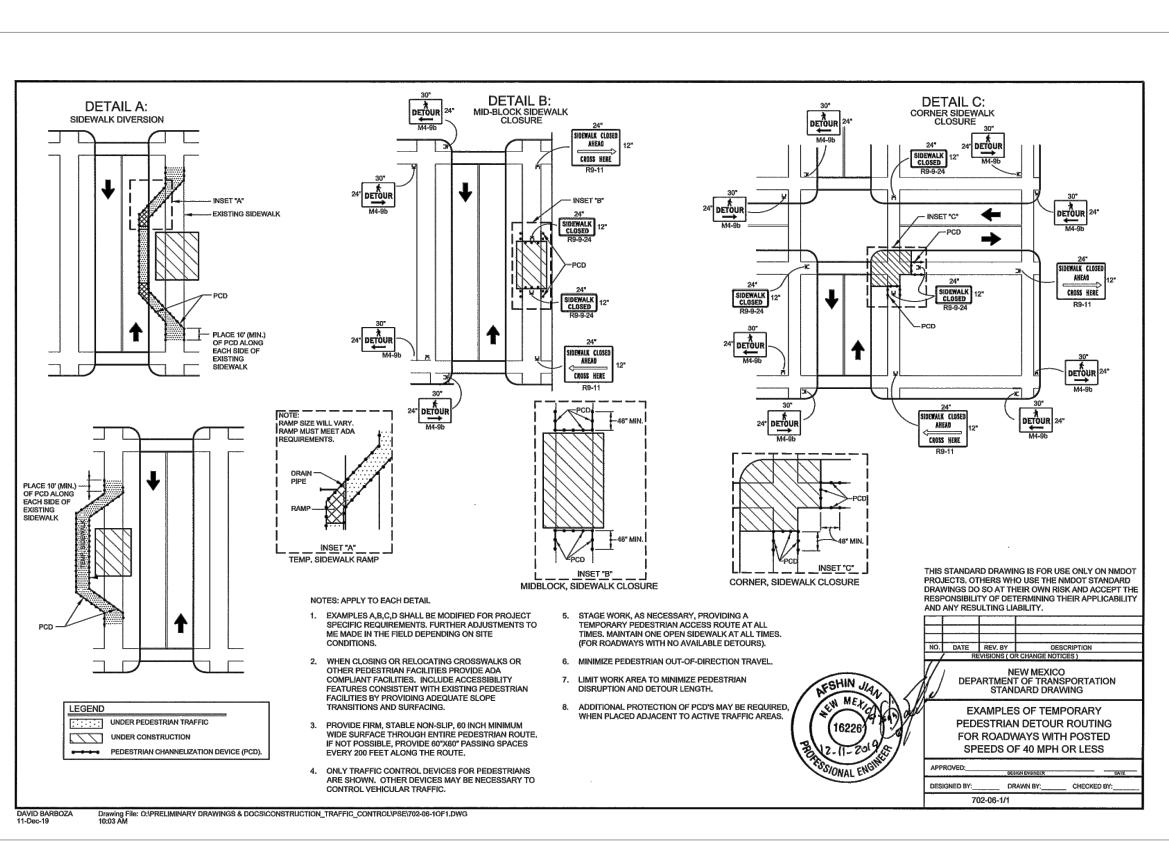
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