

DEVELOPMENT PLAN/CONSTRUCTION PLAN/STORMWATER MANAGEMENT PLAN FOR SNOW VISTA ALBUQUERQUE, NEW MEXICO

W—BEACON— E

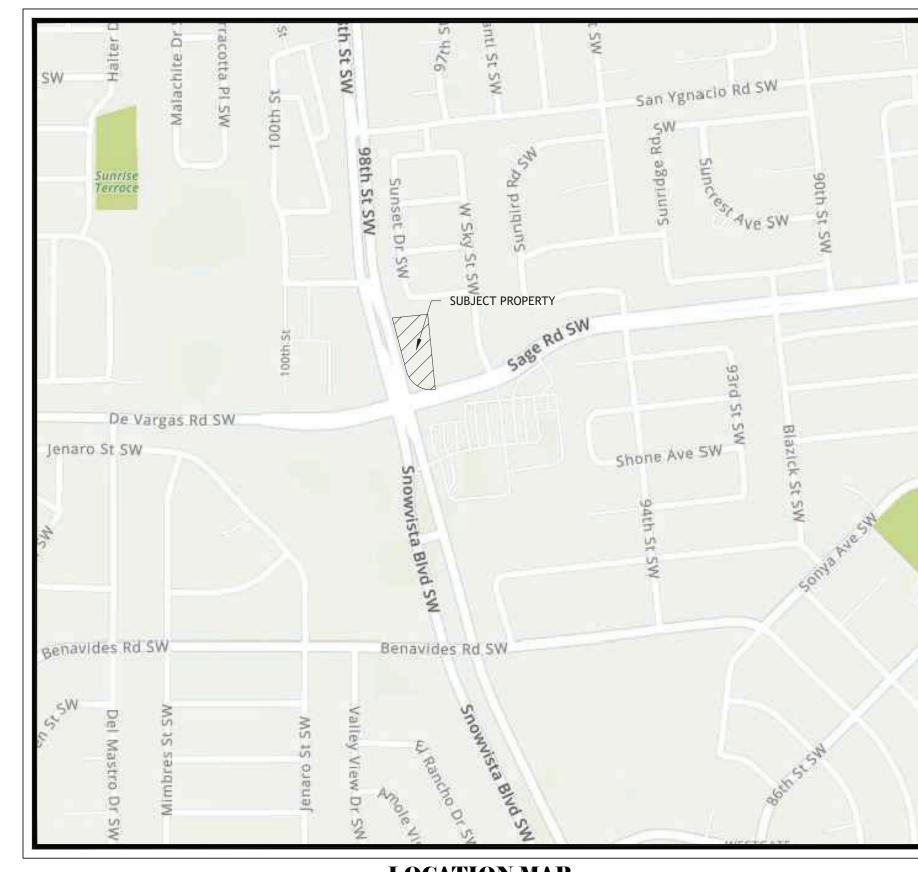

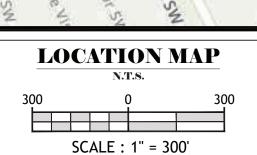

DRAWING LIST

SHEET TITLE

EXISTING CONDITIONS AND DEMOLITON PLAN

SHEET NO.

C-3.0

C-3.1

C-4.0

C-5.0

C-5.2

C-0 COVER SHEET

SWPPP PHASING

SWPPP NOTES

DRAINAGE PLAN

UTILITY DETAILS

UTILITY DETAILS

C-6.2 MOT DETAILS
C-7.0 PAVEMENT PLAN

MOT PLAN-PHASE1

MOT PLAN- PHASE 2


PAVEMENT PLAN DETAILS


CIRCULATION PLAN DETAILS

CIRCULATION PLAN

C-8.1 CIRCULATION PLAN DETAILS

DRAINAGE AND GRADING DETAILS

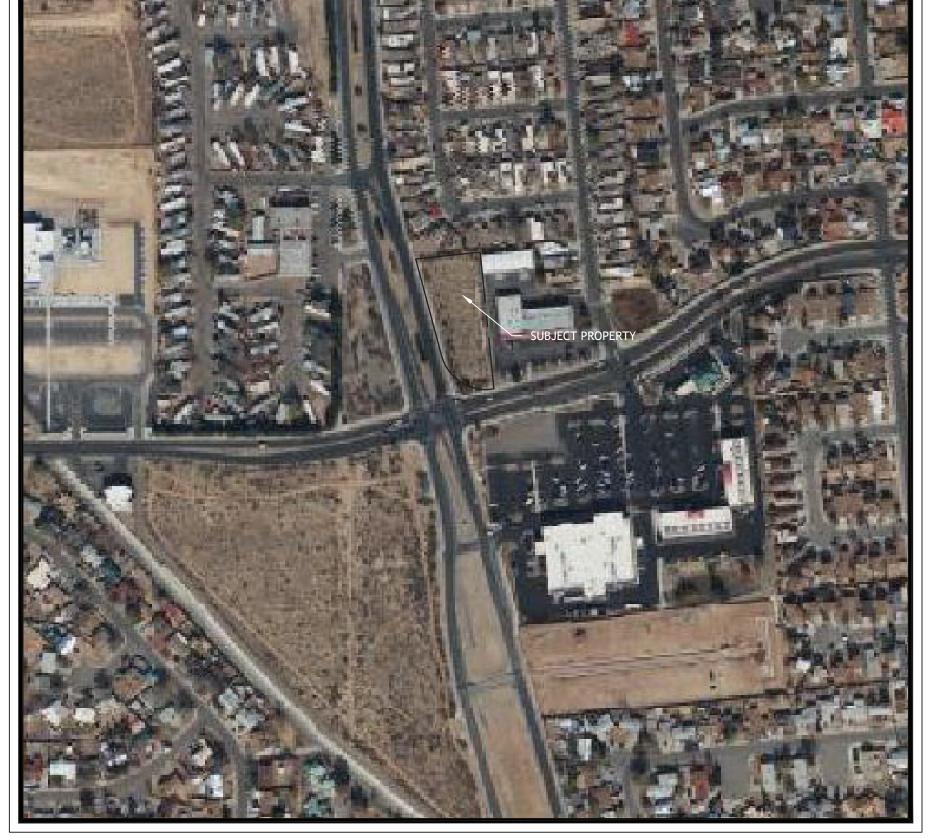

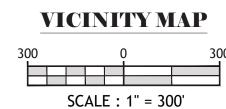

ISSUED FOR PERMITTYTING

IGNED BY: CB DRAWN BY: CB ISSUE DATE: 04/202:

CKED BY: AH APPROVED BY: AH JOB NO.: 21507

O. BY DATE REVISION DESCRIPTION

1 MK 04/11/2023 CITY COMMENTS





CIVIL ENGINEERING
CIVIL ENGINE

TAKE 5
CAR
WASH

OF NEW MEXICO SNOW VISTA


98TH STREET ALBUQUERQUE, NM

SHEET NAME:

COVER SHEET

SHEET NUMBER:

SHEET

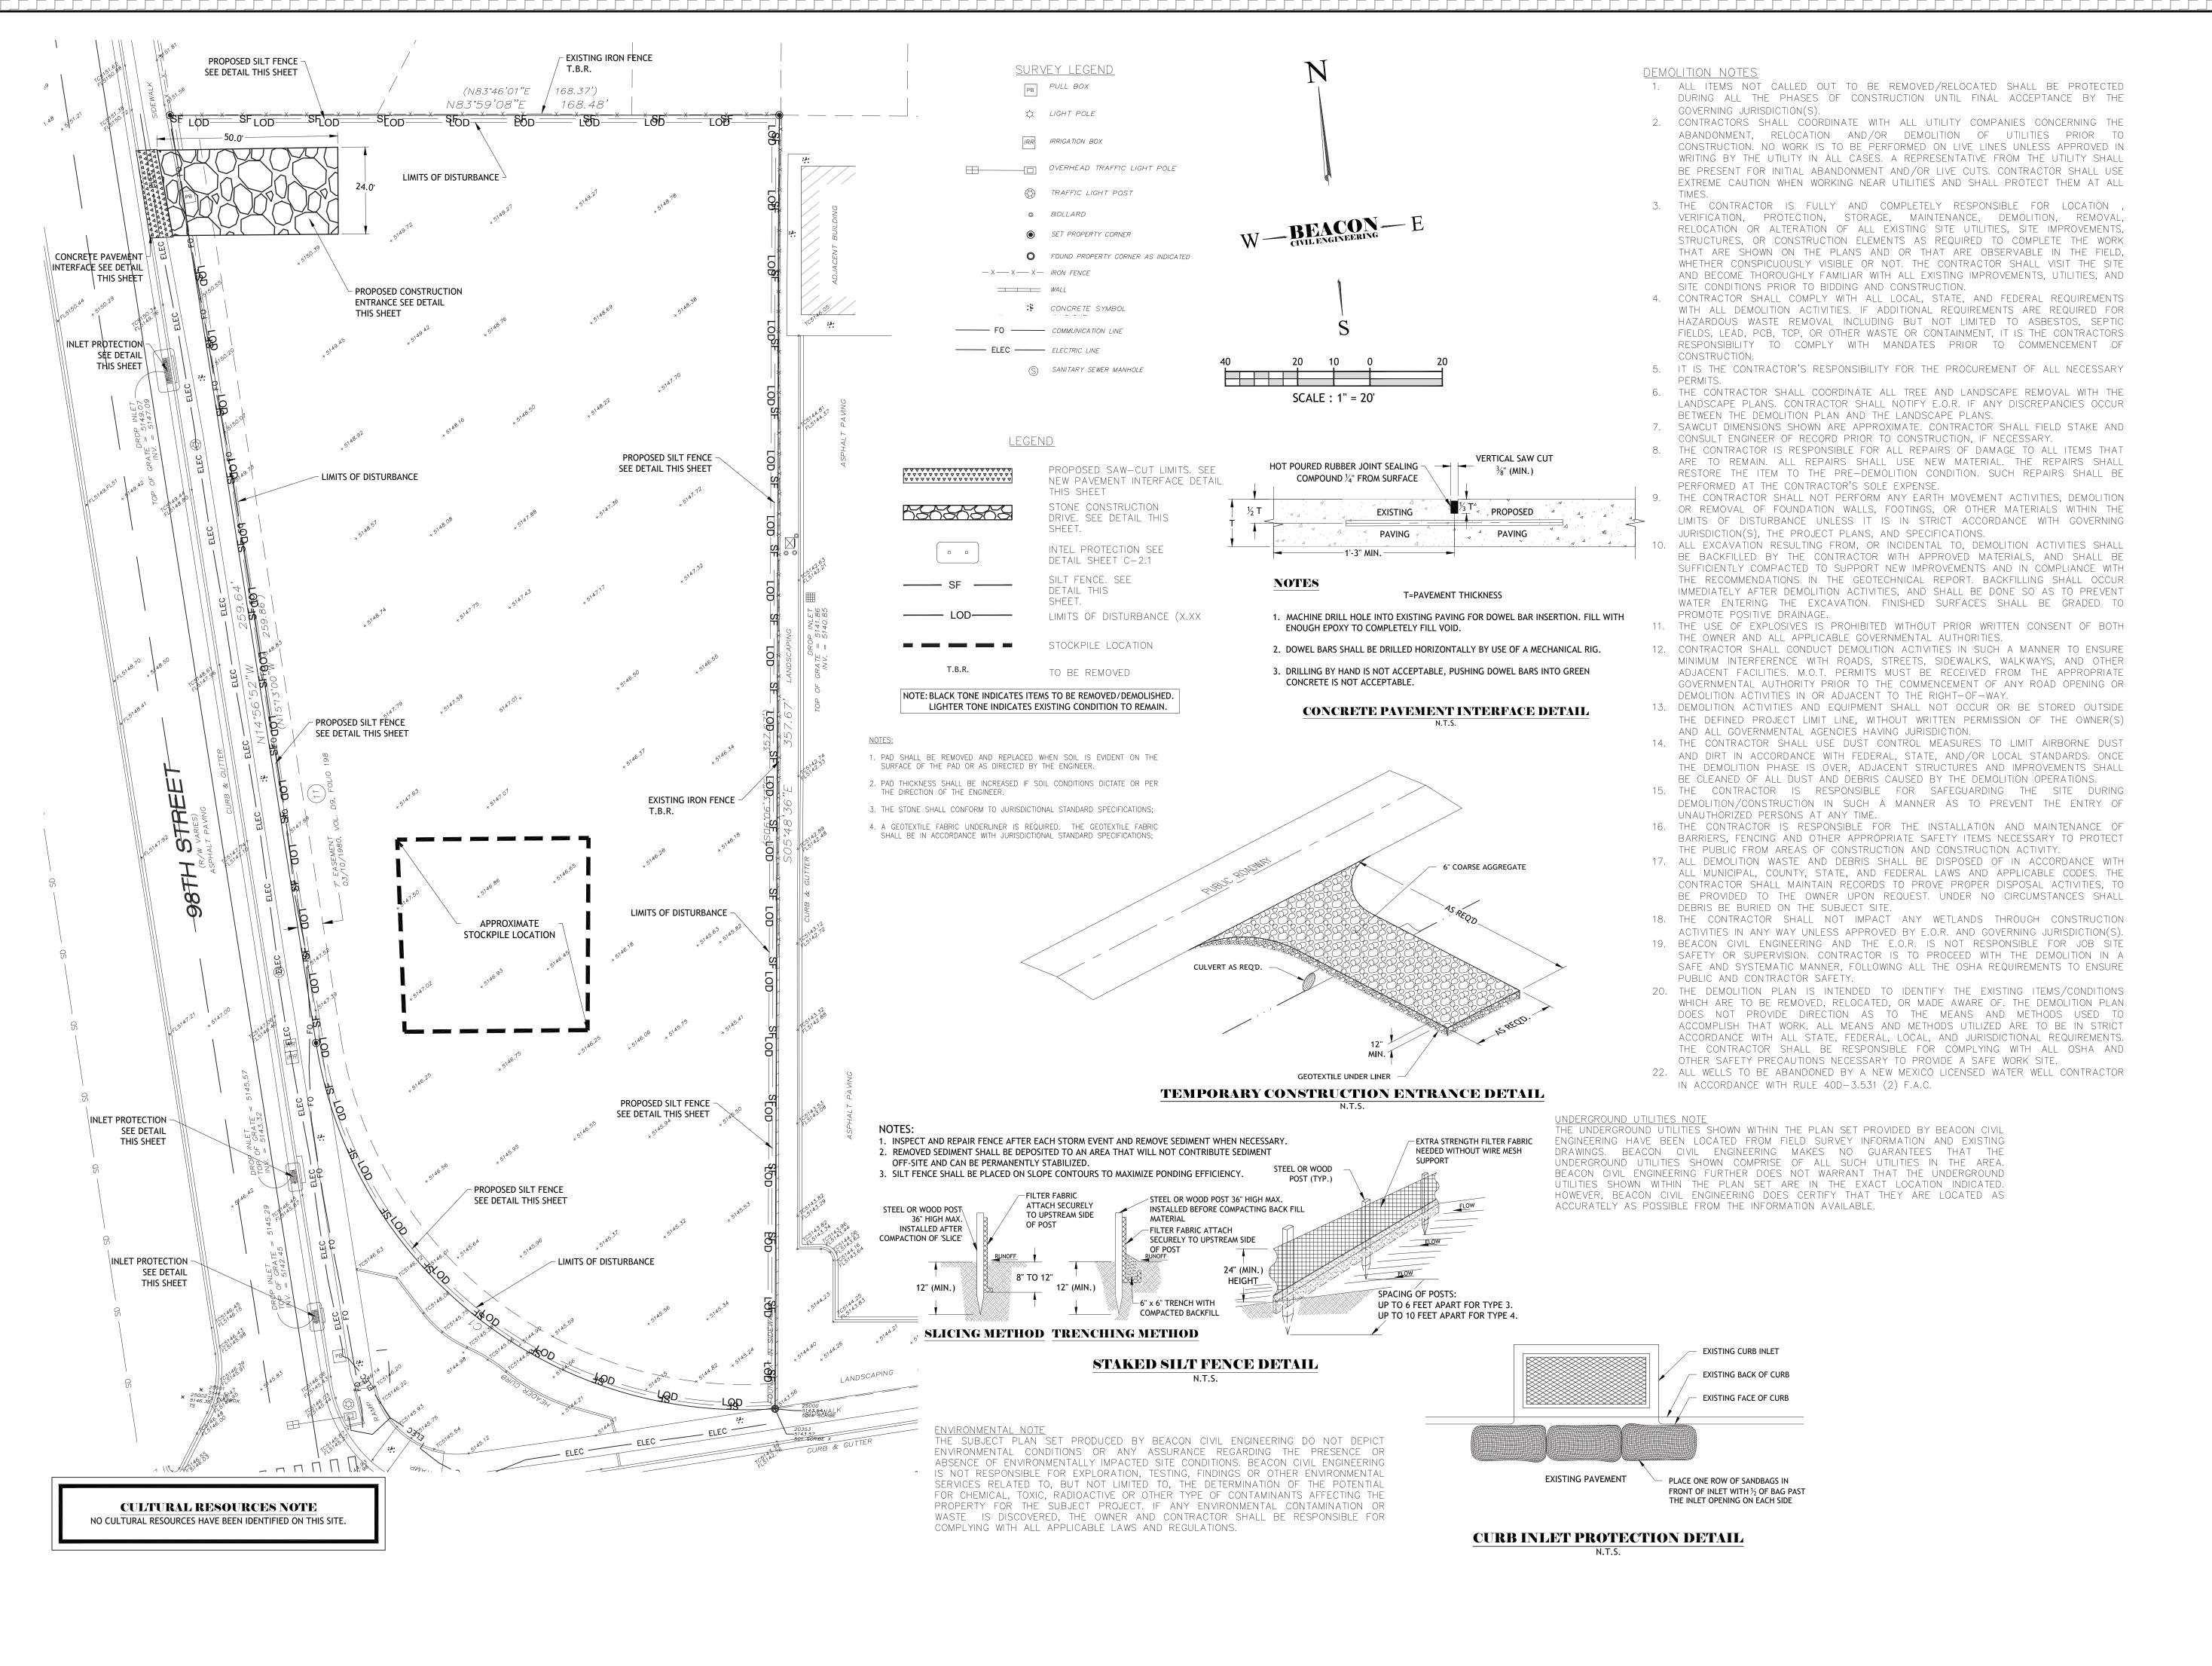

Know what's below.

Call before you dig.

27436 27436 27436

ATEF A. HANNA, PE #27436

CIVIL ENGINEERS

ND DEVELOPMENT ENGINEERS


TAKE 5
CAR
WASH


OF NEW MEXICO SNOW VISTA


98TH STREET ALBUQUERQUE, NM

EXISTING
CONDITIONS AND
DEMOLITON PLAN

SHEET NUMBER:

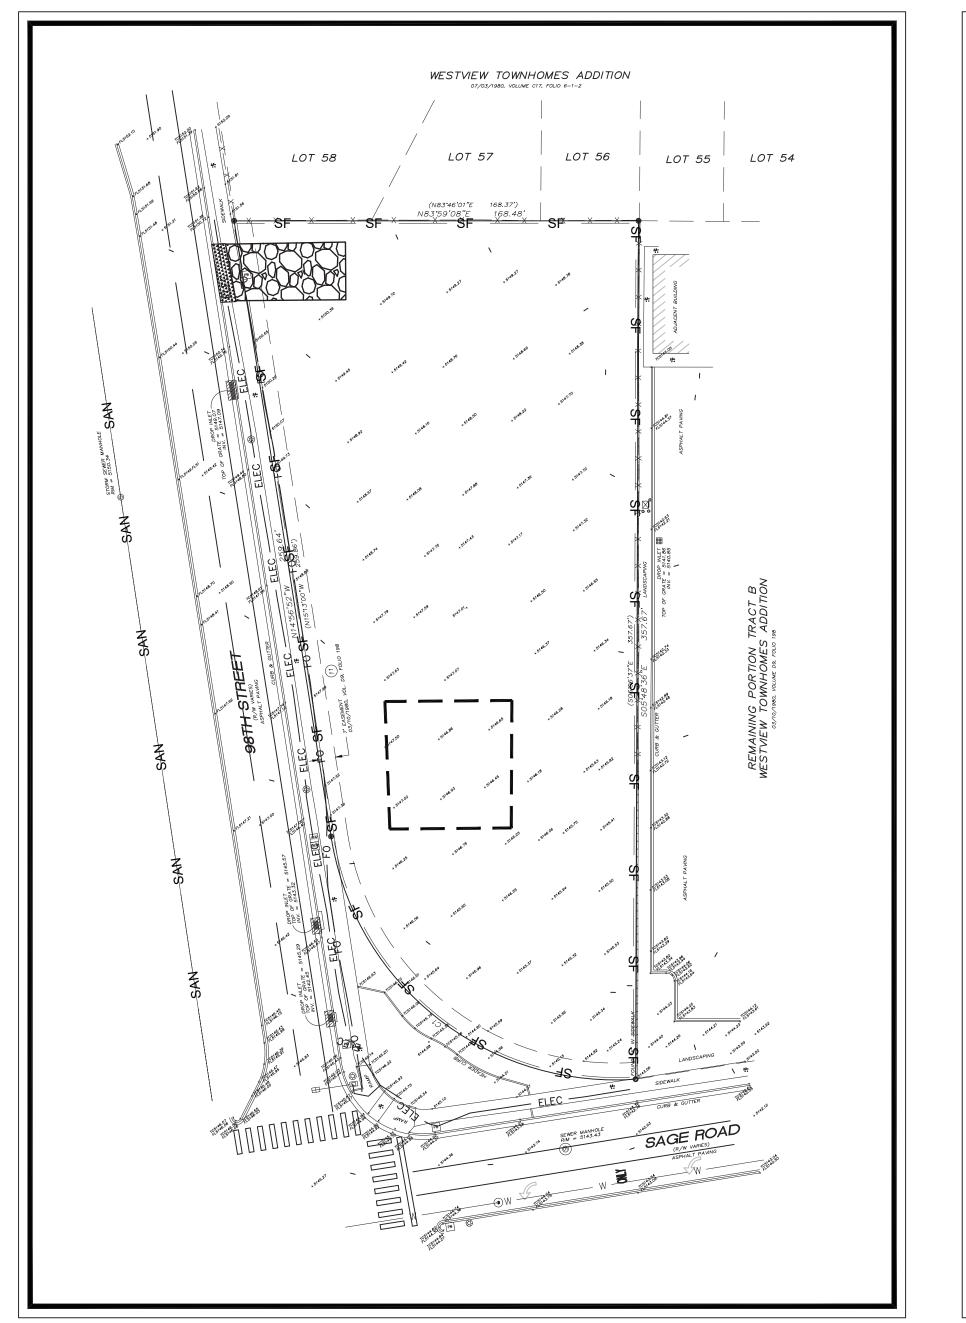

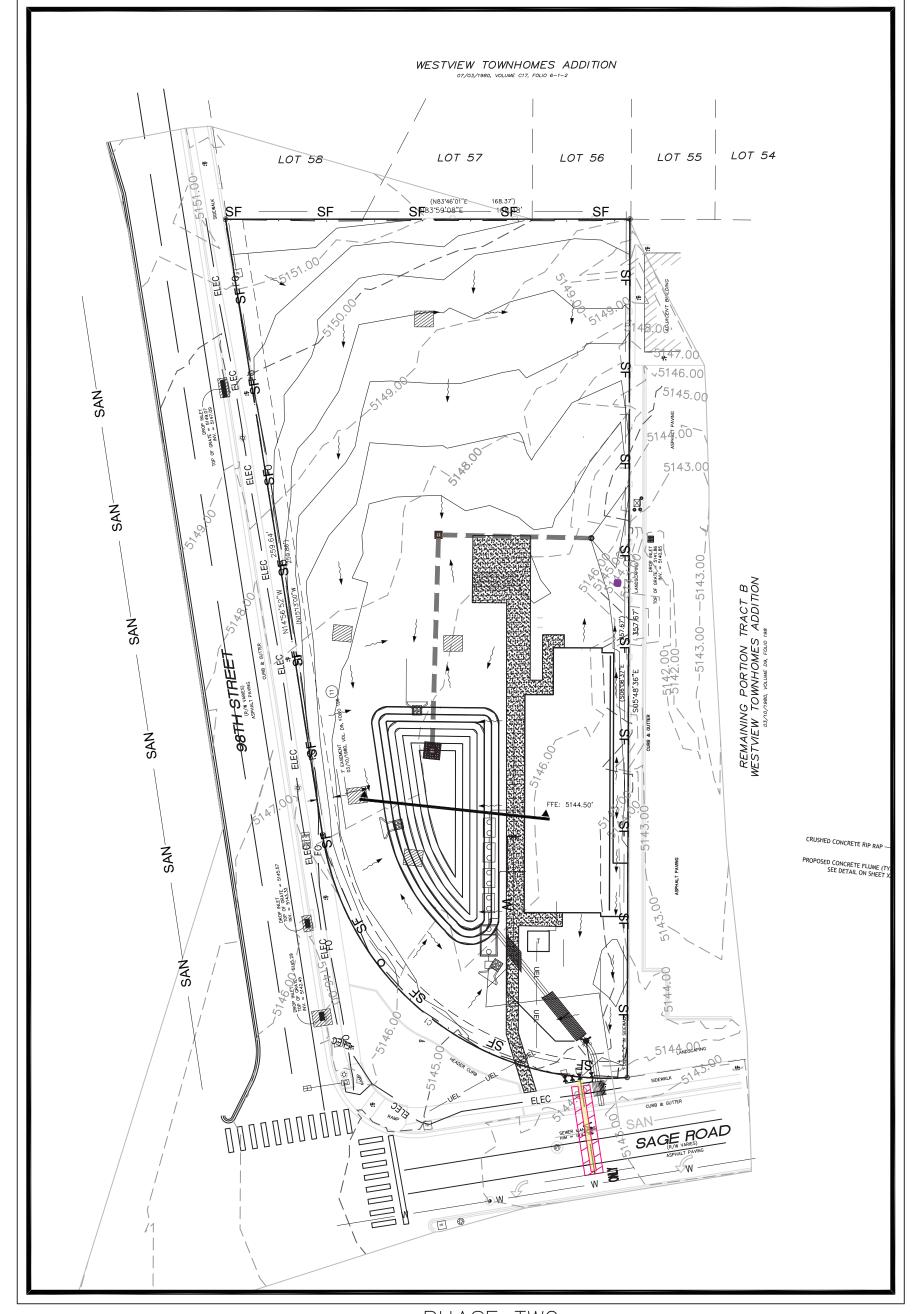

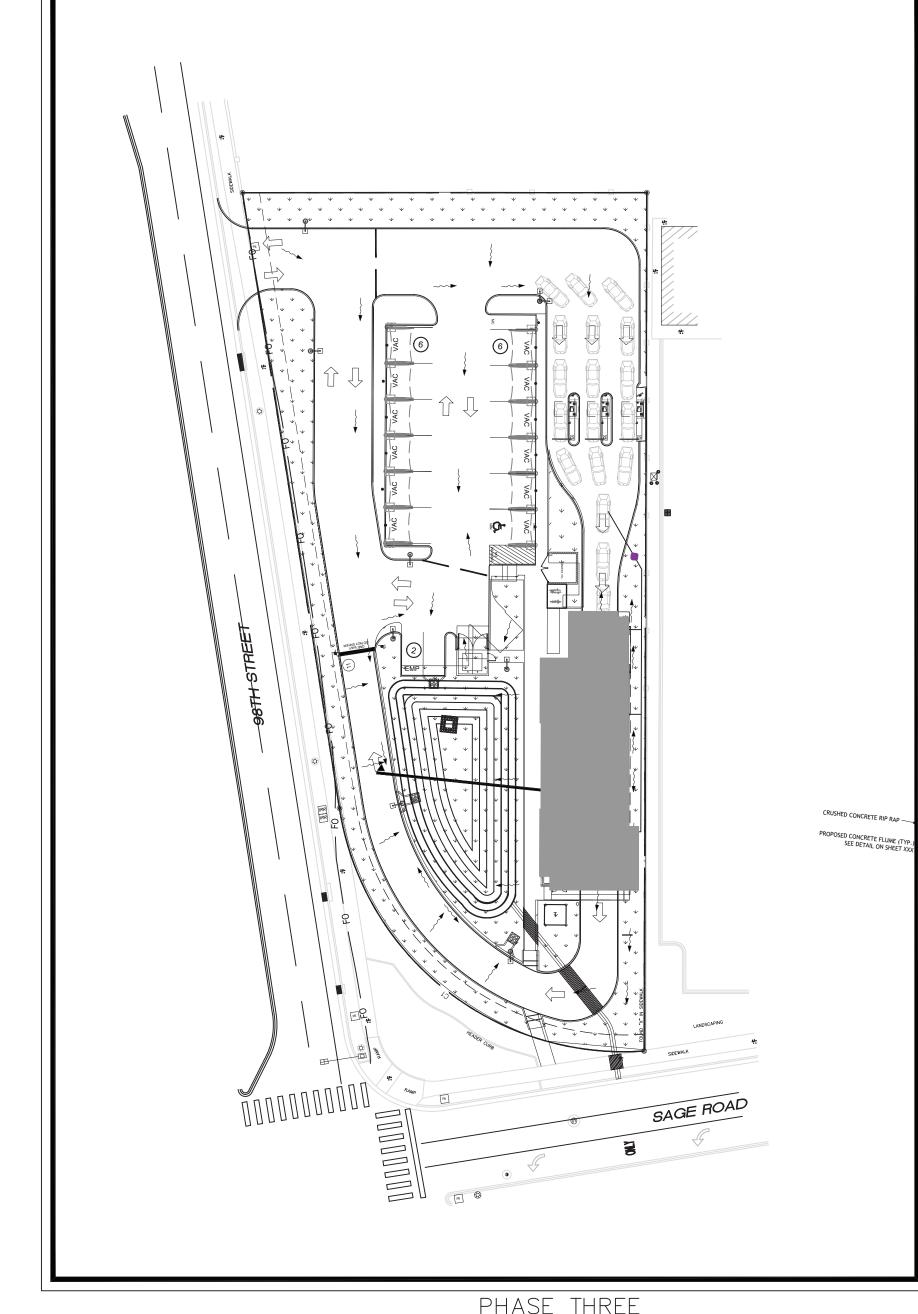

PHASE TWO PHASE THREE SCALE: 1"=40' SCALE: 1"=40'

PHASE ONE

SCALE: 1"=40'

PHASE I LEGEND

PROPOSED SAW—CUT LIMITS. SEE NEW PAVEMENT INTERFACE DETAIL SHEET C-2.0

CONSTRUCTION DRIVE. SEE DETAIL SHEET 2000

SILT FENCE. SEE DETAIL SHEET C - 2.0STOCKPILE LOCATION

INLET PROTECTION

TEMPORARY NATIVE SEED BLEND

PHASE II LEGEND

C - 2.0

OPEN TRENCH

MILLING

INLET PROTECTION

SILT FENCE. SEE DETAIL SHEET

TEMPORARY NATIVE SEED BLEND


PHASE III LEGEND


PERMANENT NATIVE SEED BLEND

CULTURAL RESOURCES NOTE NO CULTURAL RESOURCES HAVE BEEN IDENTIFIED ON THIS SITE.

NOTE: BLACK TONE INDICATES ITEMS TO BE REMOVED/DEMOLISHED. LIGHTER TONE INDICATES EXISTING CONDITION TO REMAIN.



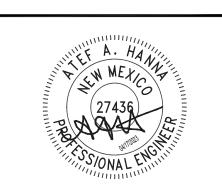

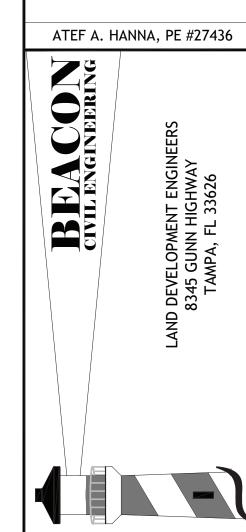

TAKE 5 CAR WASH

NEW MEXICO SNOW VISTA

98TH STREET ALBUQUERQUE,

SWPPP PHASING

SHEET NUMBER:

C - 3.0


SWPPP STANDARD NOTES

- 1. SEDIMENT CONTROL PRACTICES MUST BE ESTABLISHED ON ALL DOWN GRADIENT PERIMETERS BEFORE ANY UPGRADIENT LAND DISTURBING ACTIVITIES BEGIN. THESE PRACTICES MUST REMAIN IN PLACE UNTIL FINAL STABILIZATION HAS BEEN ACHIEVED IN ACCORDANCE WITH SECTION C EROSION CONTROL REQUIREMENTS.
- 2. IF DOWN GRADIENT TREATMENT SYSTEM IS OVERLOADED ADDITIONAL UP GRADIENT SEDIMENT CONTROL PRACTICES MUST BE INSTALLED TO ELIMINATE OVERLOADING. THE SWPPP MUST BE AMENDED TO IDENTIFY THE ADDITIONAL PRACTICES.
- 3. ALL STORM DRAIN INLETS MUST BE PROTECTED BY APPROVED BMPS DURING CONSTRUCTION UNTIL ALL POTENTIAL SOURCES FOR DISCHARGE HAVE BEEN STABILIZED. THESE DEVICES MUST BE MAINTAINED UNTIL FINAL STABILIZATION IS ACHIEVED. INLET PROTECTION MAY BE REMOVED IF A SPECIFIC SAFETY CONCERN (STREET FLOODING/FREEZING) HAS BEEN IDENTIFIED.
- 4. TEMPORARY STOCKPILES MUST HAVE SILT FENCE OR OTHER EFFECTIVE SEDIMENT CONTROLS ON THE DOWN GRADIENT SIDE OF THE STOCKPILE AND SHALL NOT BE PLACED AT LEAST 25 FEET FROM ANY ROAD, WETLAND, PROTECTED WATER, DRAINAGE CHANNEL, OR STORM WATER INLETS. STOCKPILE LEFT FOR MORE THAN 14 DAYS MUST BE STABILIZED WITH MULCH, VEGETATION, TARPS OR OTHER APPROVED MEANS.
- 5. VEHICLE TRACKING OF SEDIMENT FROM PROJECT SHALL BE MINIMIZED BY APPROVED BMPS. THESE SHALL BE INSTALLED AND MAINTAINED AT THE CITY APPROVED ENTRANCES. INDIVIDUAL LOTS SHALL EACH BE REQUIRED TO INSTALL AND MAINTAINED ENTRANCES THROUGHOUT THE CONSTRUCTION BUILDING UNTIL A PAVED DRIVEWAY IS INSTALL.
- 6. SEDIMENT THAT HAS WASHED OR TRACKED FROM SITE BY MOTOR VEHICLES OR EQUIPMENT SHALL BE CLEANED FROM PAVED SURFACES THROUGHOUT THE DURATION OF CONSTRUCTION.
- 7. SILT FENCE OR OTHER APPROVED SEDIMENT CONTROL DEVICES MUST BE INSTALLED IN ALL AREAS AS SHOWN ON THE SWPPP.
- 8. SILT FENCE OR OTHER APPROVED SEDIMENT CONTROL DEVICES SHALL BE REQUIRED ALONG THE ENTIRE CURB LINE, EXCEPT FOR APPROVED OPENING WHERE CONSTRUCTION ENTRANCE WILL BE INSTALLED OR DRAINAGE FLOWS AWAY FROM CURB. THIS DEVICE MUST BE MAINTAINED UNTIL FINAL STABILIZATION IS ACHIEVED. DITCH CHECKS SHALL BE REQUIRED IN DITCH BOTTOMS. SPACING FOR THE CHECK MUST BE AS FOLLOWS: [HEIGHT IN FEET (OF THE SEDIMENT DEVICE USED)] X 100 / SLOPE GRADIENT
- 9. DUST CONTROL MEASURES, SUCH AS APPLICATION OF WATER MUST BE PERFORMED PERIODICALLY DUE TO WEATHER, CONSTRUCTION ACTIVITY, AND/OR AS DIRECTED BY THE CITY.
- 10. FLOWS FROM DIVERSION CHANNELS OR PIPES (TEMPORARY OR PERMANENT) MUST BE ROUTED TO SEDIMENTATION BASINS OR APPROPRIATE ENERGY DISSIPATERS TO PREVENT THE TRANSPORT OF SEDIMENT TO OUTFLOW OR LATERAL CONVEYORS AND TO PREVENT EROSION AND SEDIMENT BUILDUP WHEN RUNOFF FLOWS INTO THE CONVEYORS.
- 11. A CONCRETE WASHOUT SHALL BE INSTALLED ON PROJECTS THAT REQUIRE THE USE OF CONCRETE. ALL LIQUID AND SOLID WASTES GENERATED BY CONCRETE WASHOUT OPERATIONS MUST BE CONTAINED IN A LEAK-PROOF ONTAINMENT FACILITY OR IMPERMEABLE LINER. A SIGN MUST BE INSTALLED ADJACENT TO EACH WASHOUT FACILITY TO INFORM OPERATORS TO UTILIZE THE PROPER FACILITIES.
- 12. ALL SEDIMENT CONTROL MEASURES SHALL BE USED AND MAINTAINED FOR THE DURATION OF THE PROJECT UNTIL FINAL STABILIZATION HAS BEEN ACHIEVED ACCORDANCE WITH SECTION C EROSION CONTROL REQUIREMENTS. IF CONSTRUCTION OPERATIONS OR NATURAL EVENTS DAMAGE OR INTERFERE WITH ANY EROSION CONTROL MEASURES, THEY MUST BE RESTORED TO SERVE THEIR INTENDED FUNCTION.
- 13. ADDITIONAL SEDIMENT CONTROL MEASURES SHALL BE ADDED AS NECESSARY TO EFFECTIVELY PROTECT THE NATURAL RESOURCES OF THE CITY. THE TEMPORARY AND PERMANENT EROSION CONTROL PLANS SHALL BE REVISED AS NEEDED BASED ON CURRENT SITE CONDITIONS AND TO COMPLY WITH ALL APPLICABLE REQUIREMENTS.
- 14. RESTRICT CLEARING AND GRADING WITHIN 20 FEET OF AN EXISTING WETLAND BOUNDARY TO PROVIDE FOR A PROTECTIVE BUFFER STRIP OF NATURAL VEGETATION.

AREA SUMMARY (A	ACRES)
TOTAL PARCEL AREA	1.099
ON-SITE DISTURBED AREA	1.099
OFF-SITE DISTURBED AREA	0.00
TOTAL DISTURBED AREA	1.099
PROPOSED IMPERVIOUS AREA AT COMPLETION WITHIN PROPERTY AREA	0.819
PROPOSED PERVIOUS AREA AT COMPLETION WITHIN PROPERTY AREA	0.280

CONSTRUCTION SCHEDULE

CONSTRUCTION SEQUENCE	SEP	OCT	NOV	DEC	JAN	FEB	MAR	APR	MAY	JUN	JUL	AUG
STARTING AND COMPLETION DATES												
INITIAL EROSION CONTROL BMPS INSTALLATION												
INTERMEDIATE EROSION CONTROL BMPS												
FINAL PHASE E&SC BMPS												
MAINTENACE OF E&SC PRACTICES												
DEMOLITION												
INSTALLATION / REMOVAL OF TEMPORARY SEDIMENT	BASI											
RETROFITTING OF DENTENTION POND (N/A)												
CLEARING AND GRUBBING												
GRADING												
STORM AND SANITARY SEWER INSTALLATION												
PAVING												
BUILDING CONSTRUCTION												
TEMPORARY GRASSING @ 14 DAY INTERVALS												
PERMANENT GRASSING @ 30 DAY INTERVALS												
REMOVAL OF TEMPORARY BMPS												
FINAL CLEAN-UP												

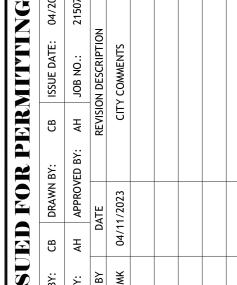





ATEF A. HANNA, PE #27436

BEACON

CIVIL ENGINEERING

LAND DEVELOPMENT ENGINEERS

8345 GUNN HIGHWAY

TAKE 5
CAR
WASH

OF NEW MEXICO SNOW VISTA


98TH STREET ALBUQUERQUE, NM


SHEET NAMI

SWPPP NOTES

SHEET NUMBER:

C - 3.1

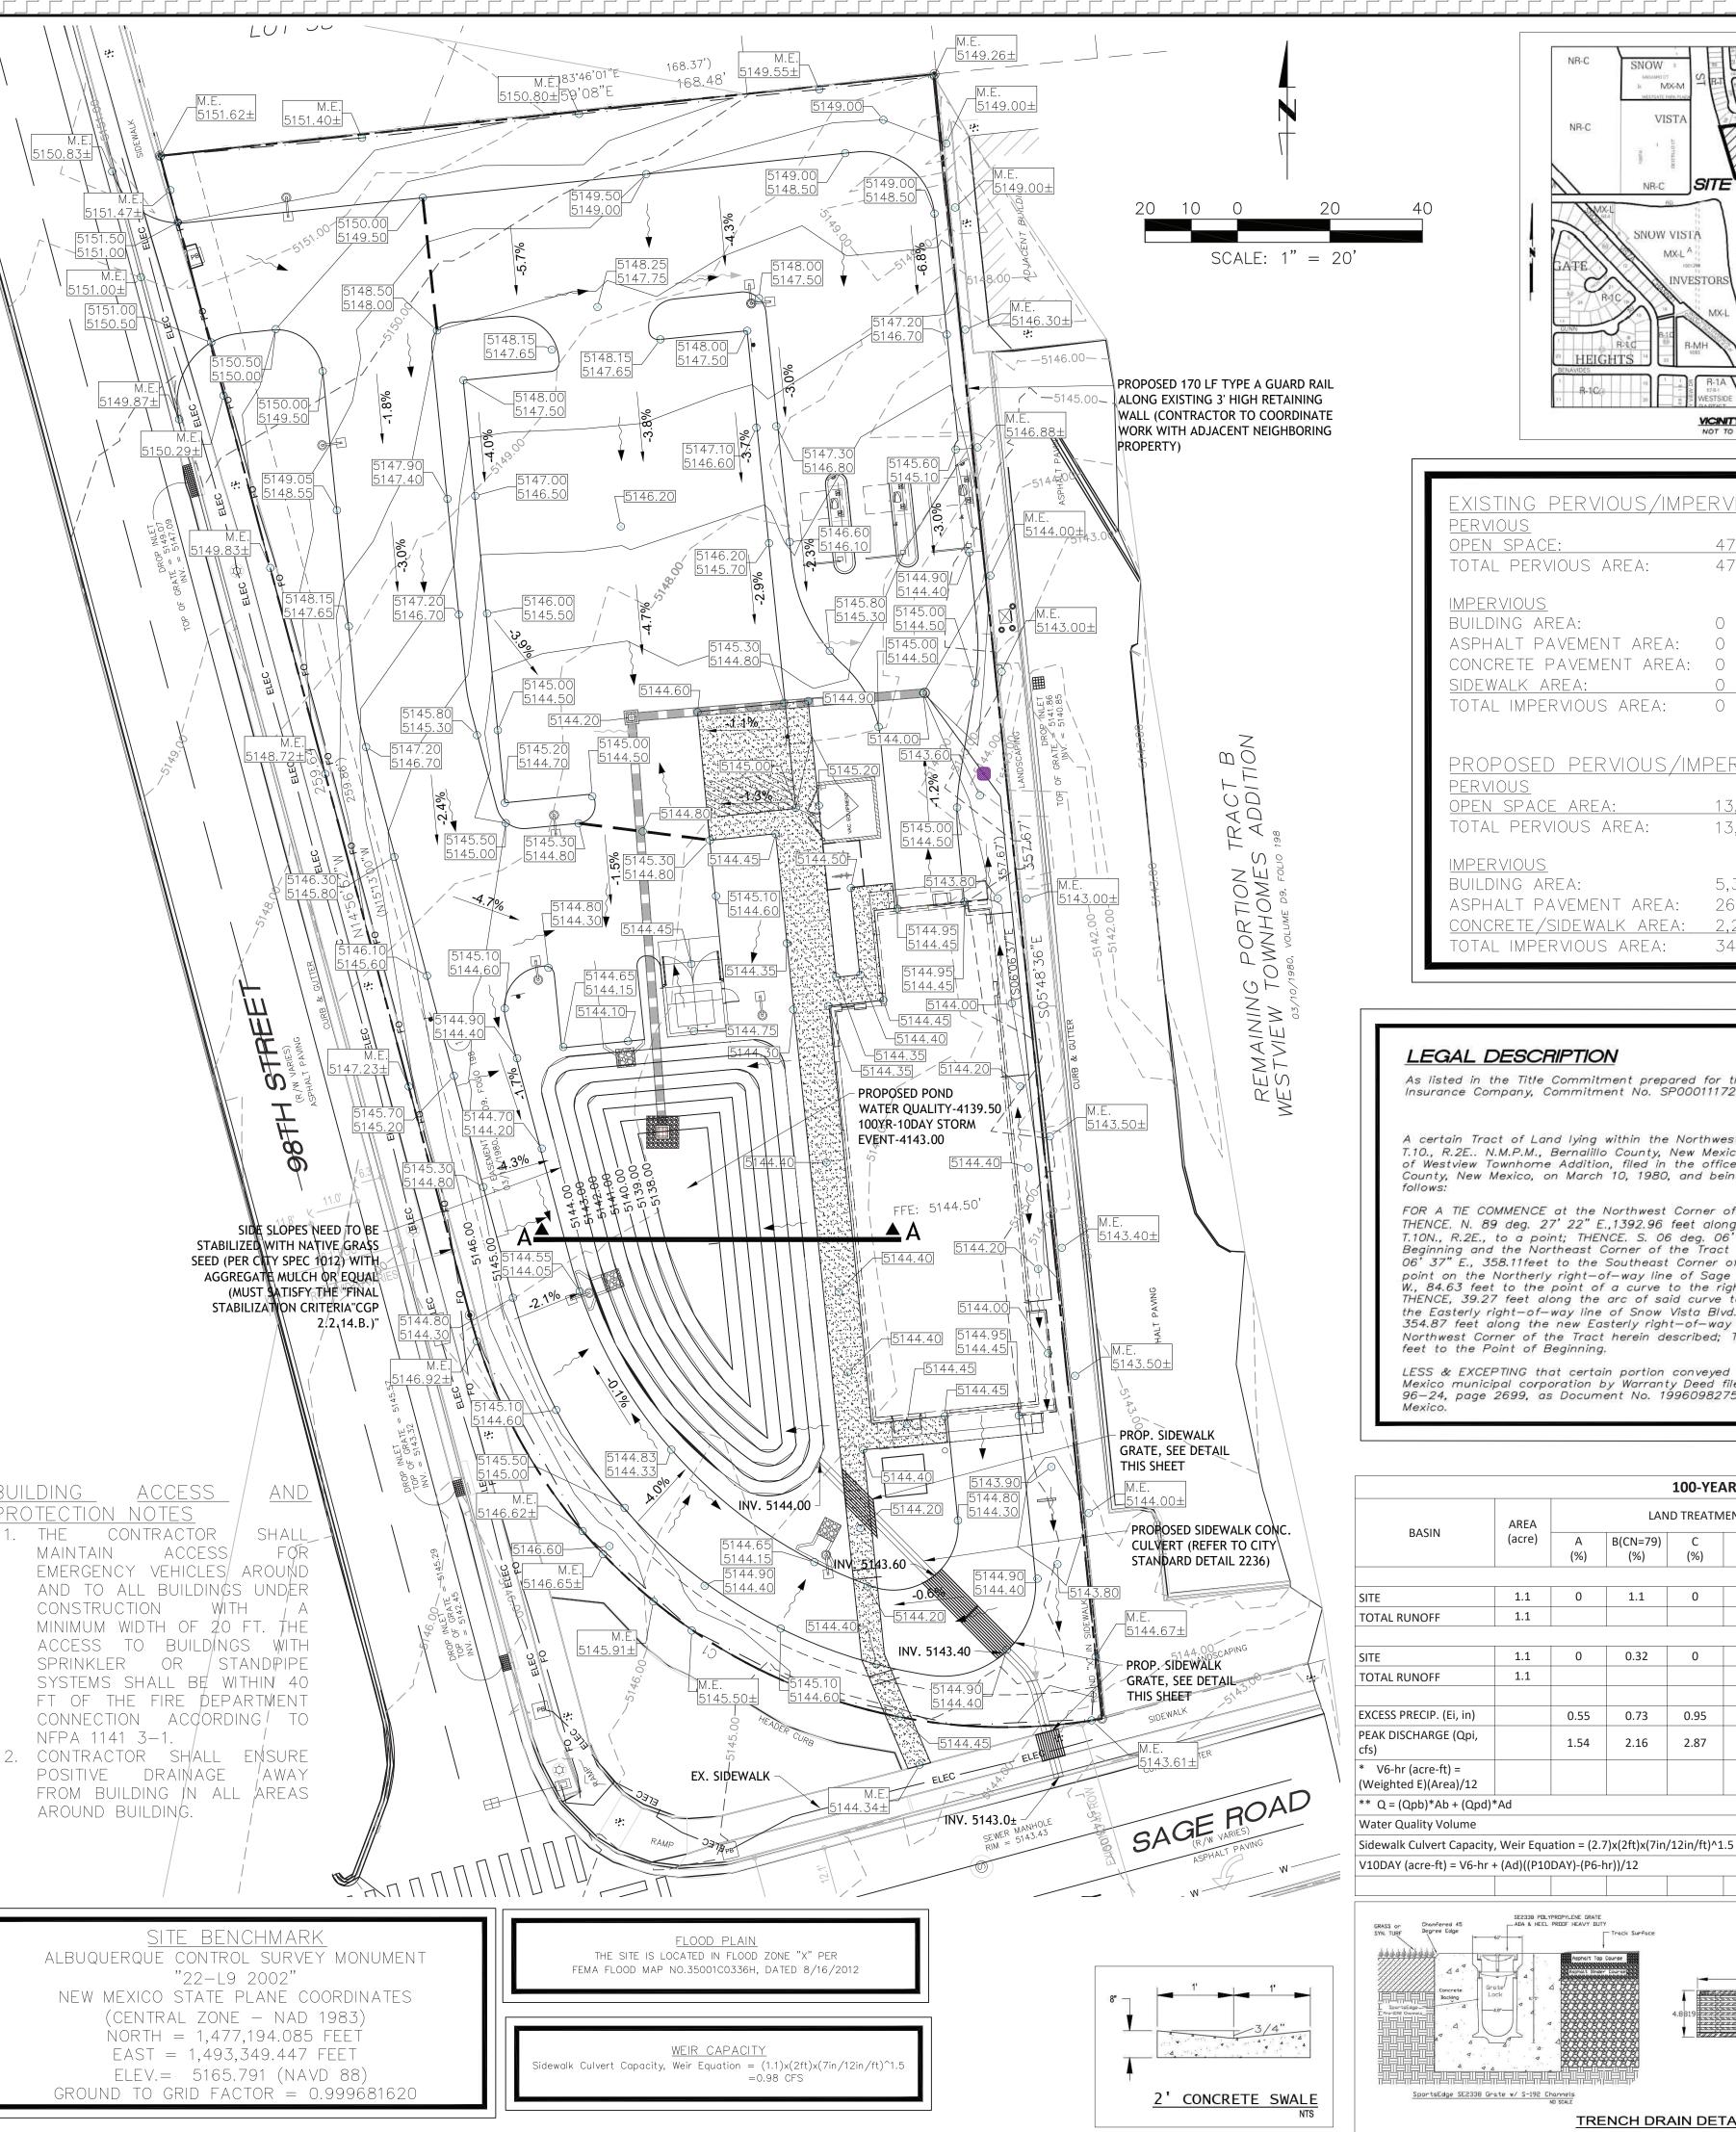

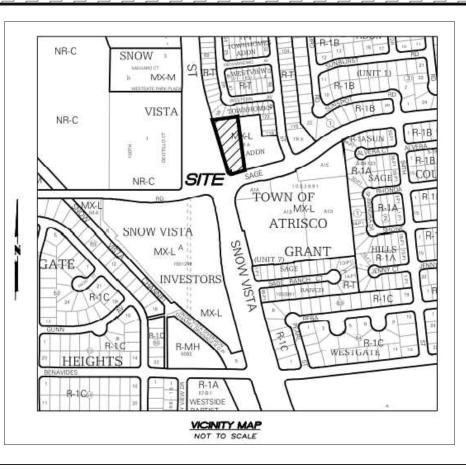

EXISTING PERVIOUS/IMPERVIOUS PEN SPACE: 47,916 SF/ 1.10 AC/ 100% 47,916 SF/ 1.10 AC/ 100% TOTAL PERVIOUS AREA: IMPERVIOUS BUILDING AREA: 0 SF/ 0 AC/ 0% ASPHALT PAVEMENT AREA: 0 SF/ 0 AC/ 0% CONCRETE PAVEMENT AREA: 0 SF/ 0 AC/ 0% SIDEWALK AREA: 0 SF/ 0 AC/ 0% TOTAL IMPERVIOUS AREA: PROPOSED PERVIOUS/IMPERVIOUS 13.800 SF/ 0.3<u>2 AC/ 29%</u> OPEN SPACE AREA: TOTAL PERVIOUS AREA: 13,800 SF/ 0.32 AC/ 29% <u>IMPERVIOUS</u> BUILDING AREA: 5,358 SF/ 0.12 AC/ 11% ASPHALT PAVEMENT AREA: 26,516 SF / 0.61 AC / 55%

LEGAL DESCRIPTION

As listed in the Title Commitment prepared for this property by Fidelity National Title Insurance Company, Commitment No. SP000111723, commitment date June 17, 2021.

2,242 SF/ 0.05 AC/ 5%

34,116 SF/ 0.78 AC/ 71%

A certain Tract of Land lying within the Northwest One—Quarter (N1/4) of Section 33, T.10., R.2E.. N.M.P.M., Bernalillo County, New Mexico, and being a portion of Tract "B" of Westview Townhome Addition, filed in the office of the County Clerk of Bernalillo County, New Mexico, on March 10, 1980, and being more particularly described as

FOR A TIE COMMENCE at the Northwest Corner of said Section 33. T.10N., R.2E., THENCE. N. 89 deg. 27' 22" E.,1392.96 feet along the North line of said Section 33, T.10N., R.2E., to a point; THENCE. S. 06 deg. 06' 37" E., 581.12 feet to the Point of Beginning and the Northeast Corner of the Tract herein described; THENCE, S. 06 deg. 06 37" E., 358.11feet to the Southeast Corner of the Tract herein described, being a point on the Northerly right—of—way line of Sage Rd. SW; THENCE, S. 74 deg. 47' 25' W., 84.63 feet to the point of a curve to the right, having a radius of 25.00 feet; THENCE, 39.27 feet along the arc of said curve to the right to a point of tangent on the Easterly right-of-way line of Snow Vista Blvd. SW; THENCE, N. 15 deg. 13' 00" W., 354.87 feet along the new Easterly right-of-way line of Snow Vista Blvd, SW to the Northwest Corner of the Tract herein described; THENCE, N. 83 deg. 46' 01" E., 168.37 feet to the Point of Beginning.

LESS & EXCEPTING that certain portion conveyed to the City of Albuquerque, a New Mexico municipal corporation by Warranty Deed filed September 4, 1996, in Book 96-24, page 2699, as Document No. 1996098275, records of Bernalillo County, New

---- X.XX ---- PROPOSED MINOR CONTOUR GRADING & DRAINAGE NOTES

⊗ 1.00

LEGEND

JURISDICTIONAL LAND DISTURBANCE PERMIT SHALL BE DISPLAYED ON SITE AT ALL TIMES DURING CONSTRUCTION AND BE VISIBLE TO THE PUBLIC.

EXISTING DIRECTIONAL DRAINAGE FLOW ARROW

TWO PERMANENT BENCHMARKS ON-SITE SHALL BE ESTABLISHED BY CONTRACTOR PRIOR TO STARTING CONSTRUCTION.

ADA PARKING STALLS. 2% MAX SLOPES IN ALL DIRECTIONS

PROPOSED TOP OF CURB/BOTTOM OF CURB SPOT ELEVATION

- 3. PROPOSED SPOT ELEVATIONS ARE TO THE TOP OF PAVEMENT UNLESS OTHERWISE NOTED.
- 4. ALL REQUIRED FILL SHALL BE CLEAN, SUITABLE MATERIAL.

PROPOSED SPOT ELEVATION

MATCH EXISTING ELEVATION

PROPOSED SLOPE INDICATOR

PROPOSED RIDGE LINE

---- PROPOSED MAJOR CONTOUR

DIRECTIONAL DRAINAGE FLOW ARROW


- 5. ALL AREAS DISTURBED OUTSIDE LIMITS OF GRADING SHOWN ON THE PLANS SHALL BE RESTORED TO EXISTING CONDITIONS OR BETTER BY THE CONTRACTOR
- 6. CONTRACTOR SHALL MEET AND MATCH EXISTING (M.E.) PAVEMENT ALONG SAW-CUT LIMITS.
- 7. LENGTH OF PROPOSED RIP-RAP PADS AT PIPE OUTLET STRUCTURES SHALL BE A MINIMUM LENGTH OF SIX TIMES THE DIAMETER OF THE PIPE. IF APPLICABLE.
- 8. ALL FILL SHOULD BE PLACED IN THIN, HORIZONTAL LOOSE LIFTS, MAXIMUM 6 INCHES, AND COMPACTED TO AT LEAST 98% OF THE STANDARD PROCTOR MAXIMUM DRY DENSITY (ASTM D698). A FLORIDA REGISTERED PROFESSIONAL SOILS ENGINEER SHALL CERTIFY THE SOIL COMPACTION PRIOR TO THE INSTALLATION OF PAVEMENTS, CURBS, SIDEWALKS OR FOOTINGS OF ANY TYPE. COMPACTION OF THE UPPER 8 INCHES OF SOIL BENEATH PAVEMENTS AND SLAB-ON-GRADE SHOULD BE COMPACTED TO AT LEAST 98%.
- 9. STORMWATER PONDS AND OUTLET STRUCTURES SHALL BE FULLY CONSTRUCTED AND OPERATIONAL PRIOR TO ANY OTHER CONSTRUCTION OR GRADING ON THE SITE AND MAINTAINED UNTIL PERMANENT GROUND COVER IS ESTABLISHED.
- 10. REFER TO LANDSCAPE PLAN FOR REQUIRED TREE AND GROUND COVER PLANTINGS.
- 11. SURFACE GRADE SLOPES SHALL BE A MINIMUM OF 1.00%
- 12. 4:1 MAXIMUM CUT AND FILL SLOPES
- 13. ADA ACCESSIBLE AREAS SHALL NOT HAVE A MAXIMUM CROSS-SLOPE THAT EXCEEDS 2.00% AND MAX LONGITUDINAL SLOPE OF 5.00% UNLESS A RAMP IS SPECIFIED. IF DISCREPANCIES OCCUR CONTRACTOR SHALL NOTIFY ENGINEER OF RECORD IMMEDIATELY TO CONFIRM DESIGN TO ENSURE ADA ACCESSIBLE STANDARDS ARE MET.
- 14. ALL TRENCHING AND BACKFILL OPERATIONS SHALL COMPLY WITH GOVERNING JURISDICTIONAL STANDARDS. SEE SHEET C4-2 FOR PIPE TRENCHING DETAILS.
- 15. SEE SHEET C4.1-C4.3 FOR DETAILS.
- 16. ALL INLET GRATES SUBJECTED TO VEHICLE LOADING SHALL MEET H-20 TRAFFIC LOADING STANDARDS

Private Drainage Facilities within City Right-of-Way

Notice to Contractor (Special Order 19 ~ "SO-19")

- Build sidewalk culvert per COA STD DWG 2236. Work is permitted and inspected by DMD Construction Services Division.
- An excavation permit will be required before beginning any work within City Right-Of-Way.
- All work on this project shall be performed in accordance with applicable federal, state and local laws, rules and regulations concerning construction safety and health.
- Prior to any excavation, the contractor must contact New Mexico One Call, dial "811" [or (505) 260-1990] for the location of existing utilities.
- Prior to construction, the contractor shall excavate and verify the locations of all obstructions. Should a conflict exist, the contractor shall notify the engineer so that the conflict can be
- resolved with a minimum amount of delay. Backfill compaction shall be 95%.
- Maintenance of the facility shall be the responsibility of the owner of the property being
- Work on arterial streets may be required on a 24-hour basis. For excavation and barricading inspections, contact DMD
- 10. Construction Services Division.

				100-YEA	R HYDROLOGIC C	ALCULATIONS						Pond Volume						
BASIN	AREA		LAN	D TREATM	ENT	WEIGHTED	100-YEAR PRECIPITATION				Q** (CFS)			Surface	Surface	Incr.	Total	Total
	(acre)	А	B(CN=79)	С	D(CN=98)	(IN)	V(6-hr)* V(6-hr) (acre-ft) (cu-ft)	V(6-hr)		V(24-hr) (cu-ft)		EI	ev.	Area	Area	Volume	Volume	Volume
		(%)	(%)	(%)	(%)	(,		(cu-ft)				150	۸-	(square	((0 0 m 0 ft)	/a ava ft \	/ ala : a £t \
					EXISTING CONDITI	ONS						(TE	et)	ft.)	(acres)	(acre ft.)	(acre ft.)	(cubic ft.)
	1.1	0	1.1	0	0	0.79	0.07	3,154	0.07	3,154	2.38					0.00	0.00	0
RUNOFF	1.1						0.07	3,154	0.07	3,154	2.38	4143	.00	3,401	0.08	0.07	0.21	9,015
					DEVELOPED CONDIT	TIONS												
	1.1	0	0.32	0	0.78	0.92	0.08	3,692	0.08	3,692	3.90	4142	.00	2,674	0.06	0.05	0.14	5,985
RUNOFF	1.1						0.08	3,692	0.08	3,692	3.90	4141	.00	2,033	0.05	0.04	0.08	3,639
												4140	.00	1,449	0.03	0.03	0.04	1,906
PRECIP. (Ei, in)		0.55	0.73	0.95	2.24			ZONE 1				4139	00	940	0.02	0.02	0.02	721
ISCHARGE (Qpi,		1.54	2.16	2.87	4.12		P6-hr (in)		2.17			Pond Bottom = > 4138			0.01	0.02	0.02	721
nr (acre-ft) = ted E)(Area)/12							P24-hr (in)		2.49			Available voulume in					> 8,591, therefor	
(Qpb)*Ab + (Qpd)*	Ad			1			P10day (in)		3.90			Retention Pond =			9,015	CF	e OK	
Quality Volume					=	1,202	CF					!						
lk Culvert Capacity	Weir Equa	ation = (2.	7)x(2ft)x(7in/	12in/ft)^1	.5 =	2.41	CFS											

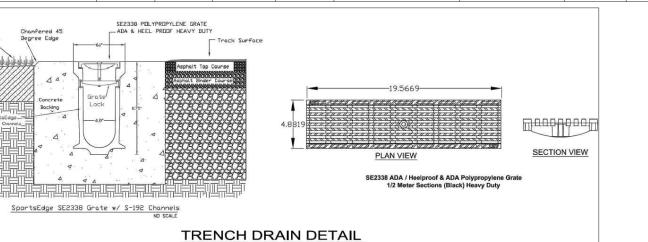

= 0.197

8,591 CF


EXISTING GRADE 100-YEAR-10 DAY STORM EVENT ELEV. = 5143.00 TOB: 5144 WATER QUALITY ELEV; = 5139.50 PROPOSED GRADE TOE: 5138 SECTION A-A

Know what's **below**. **Call** before you dig.



ATEF A. HANNA, PE #27436

SEA VILENG

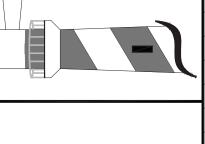

TAKE 5 CAR WASH

NEW MEXICO SNOW VISTA


98TH STREET ALBUQUERQUE,


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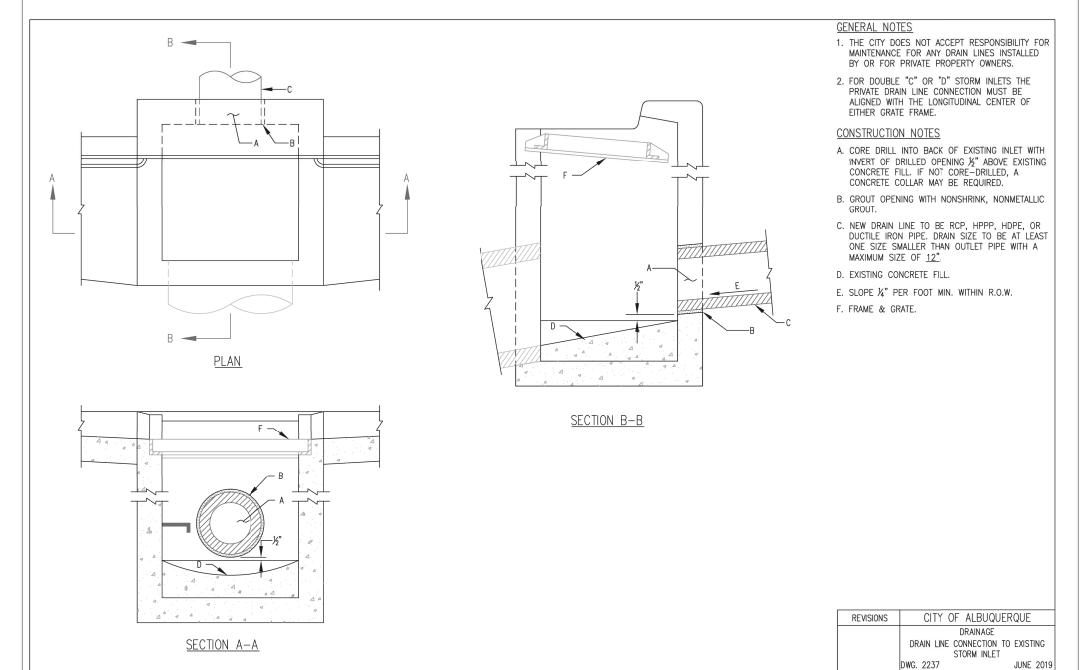
GRADING PLAN


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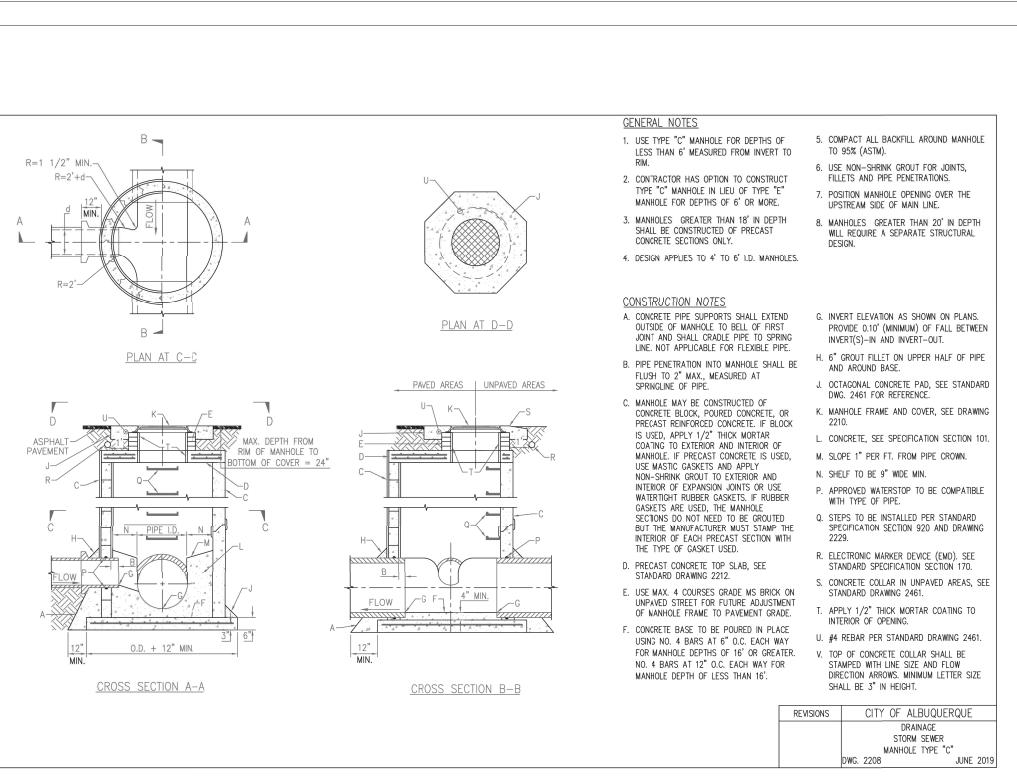
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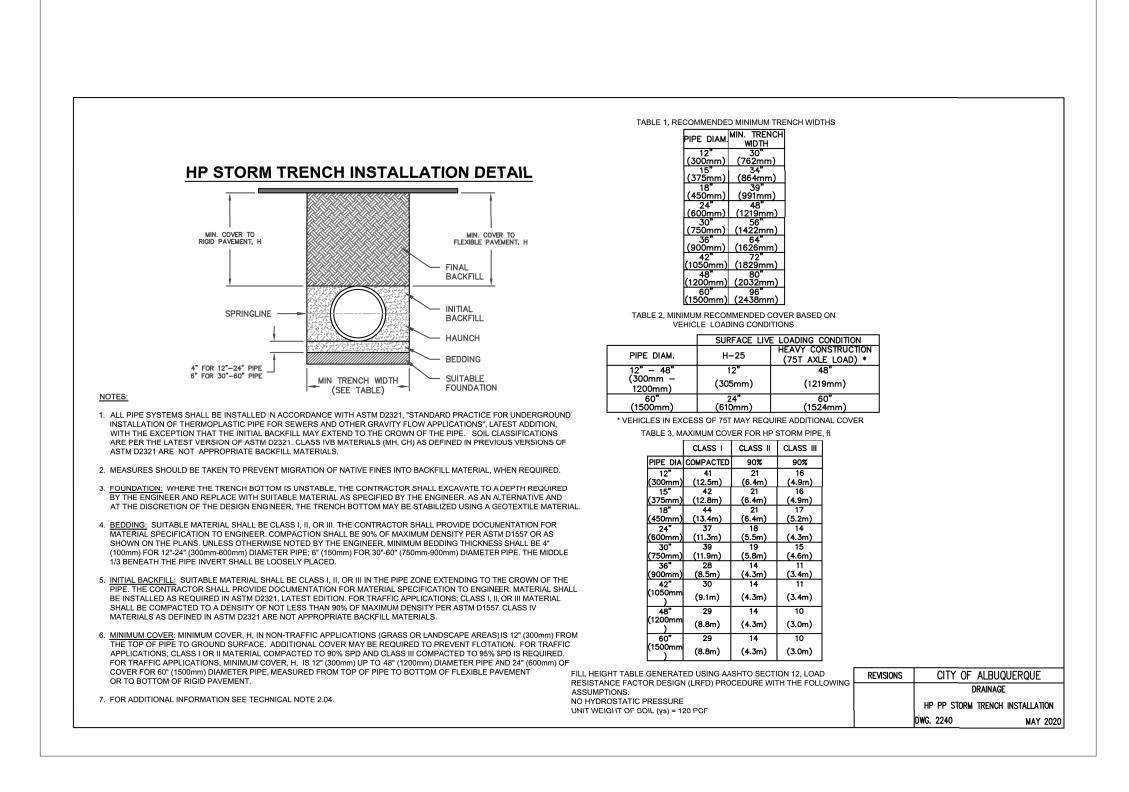







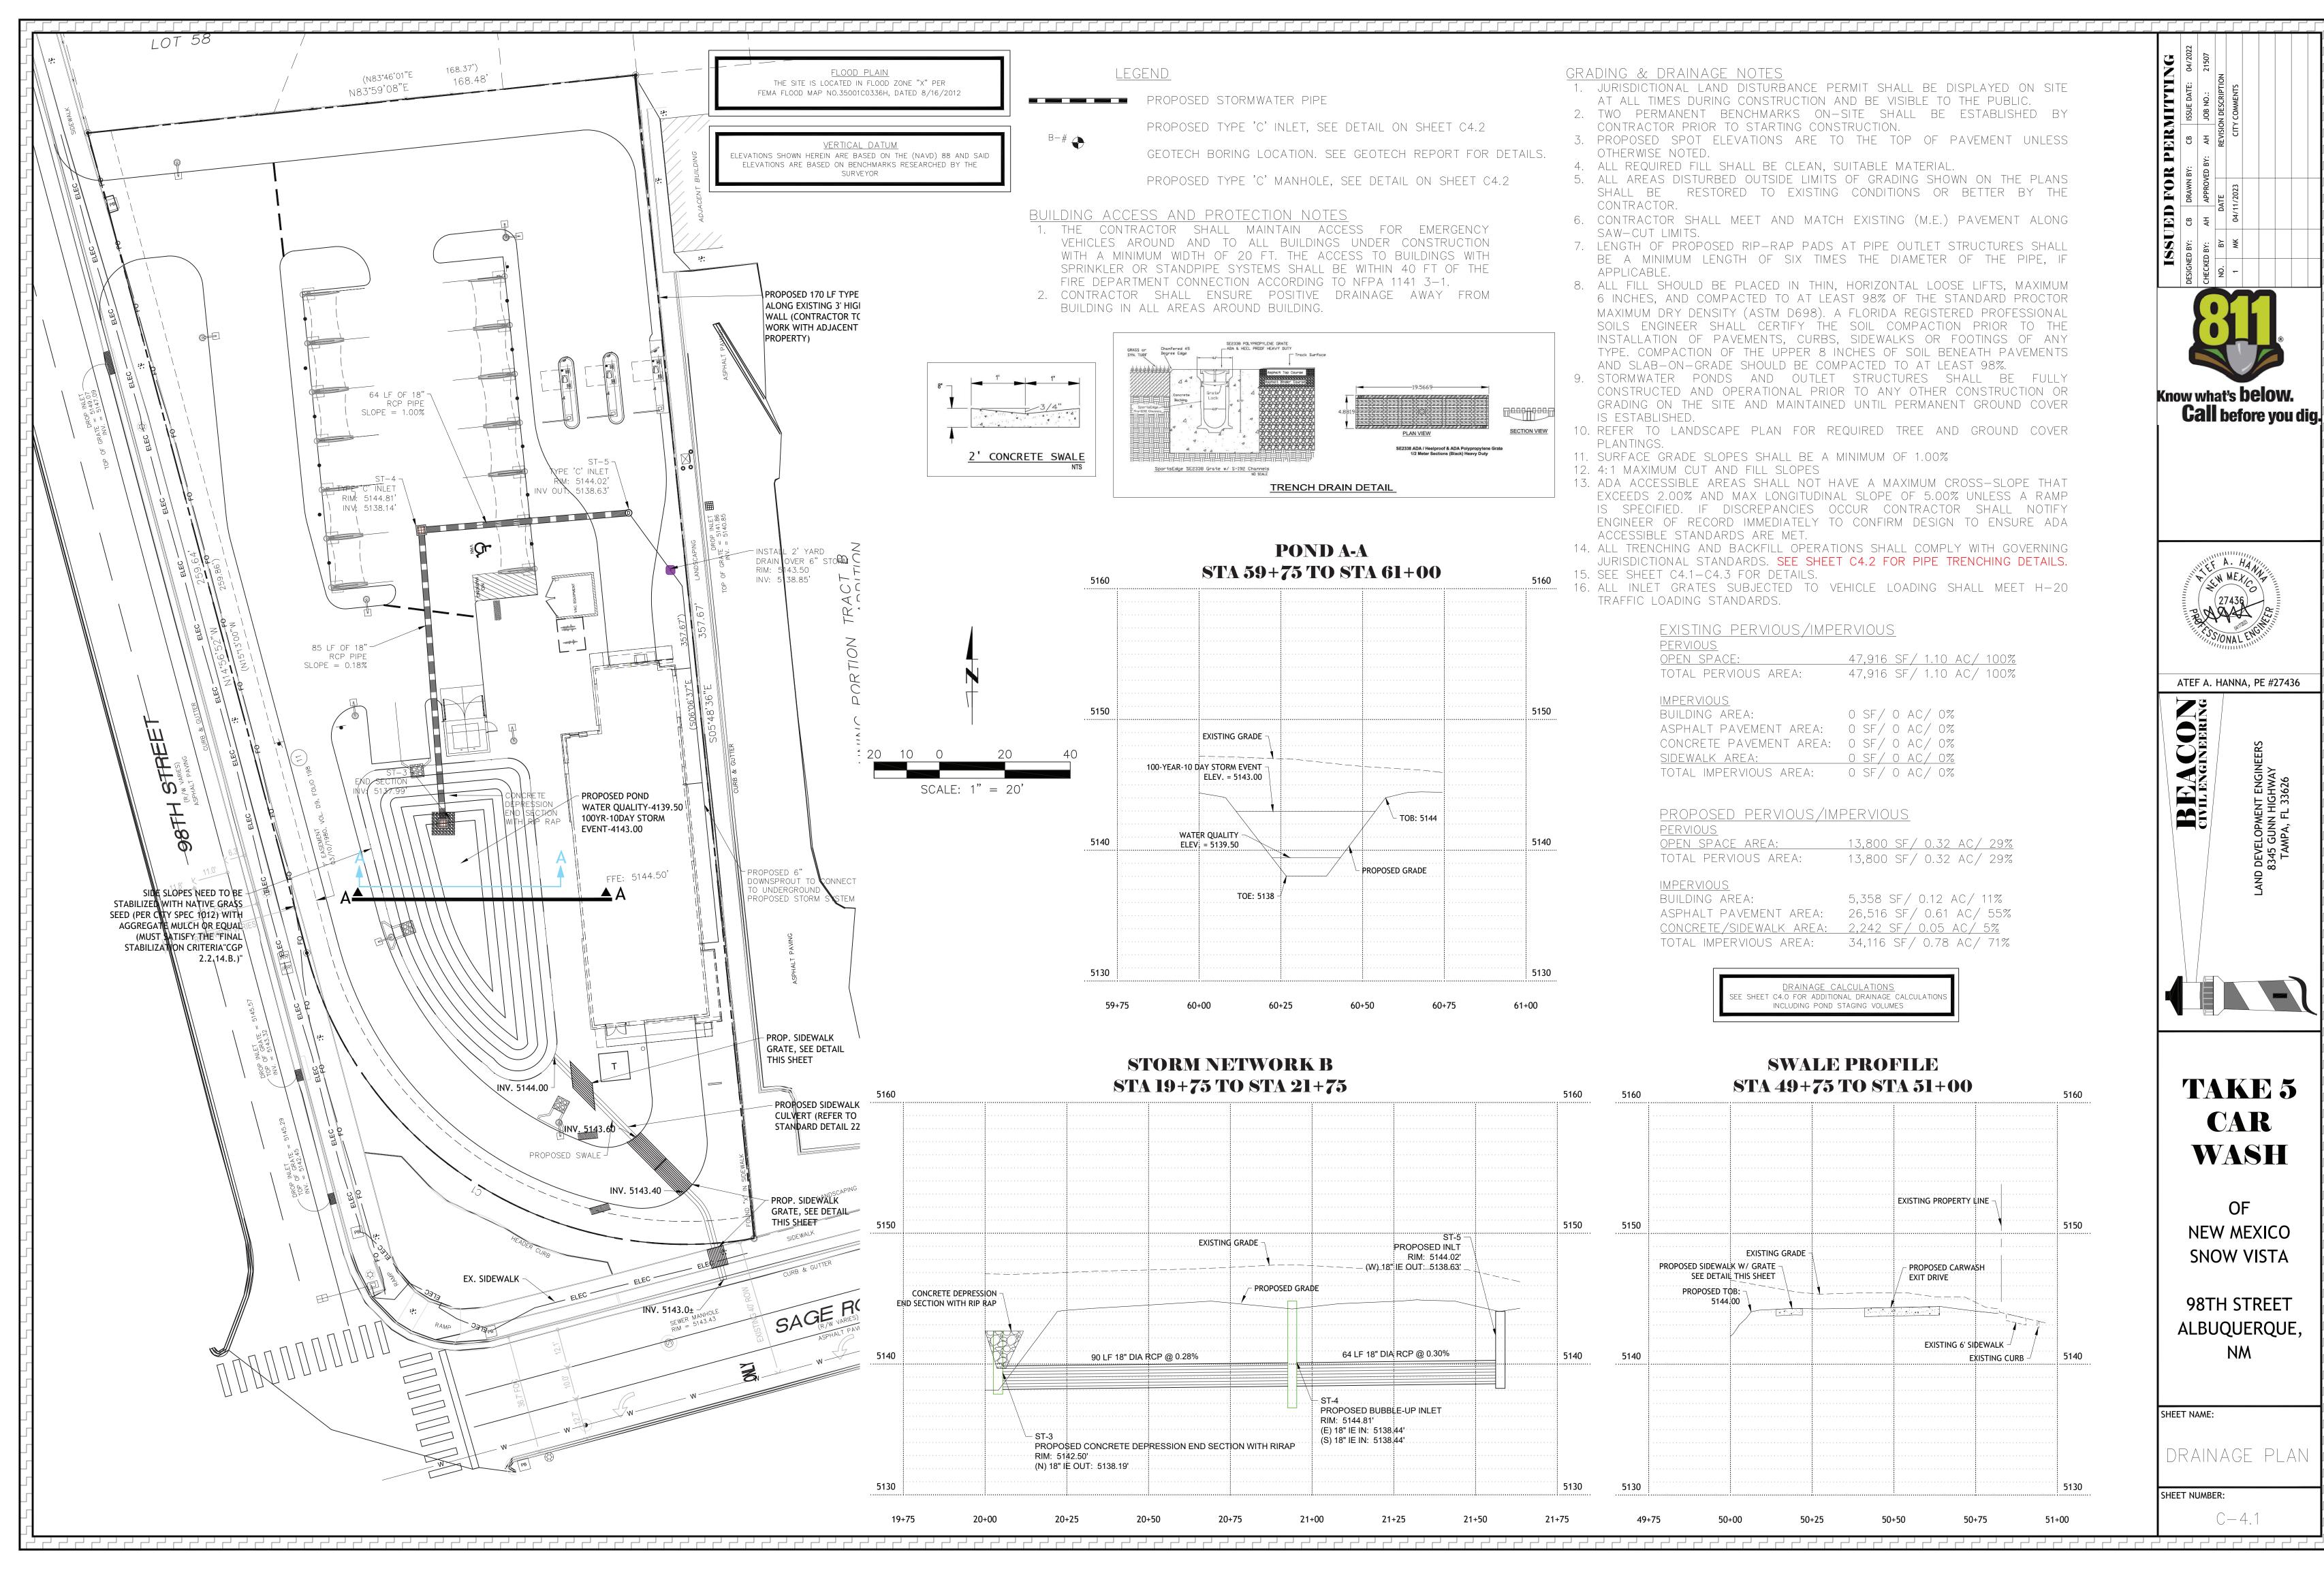

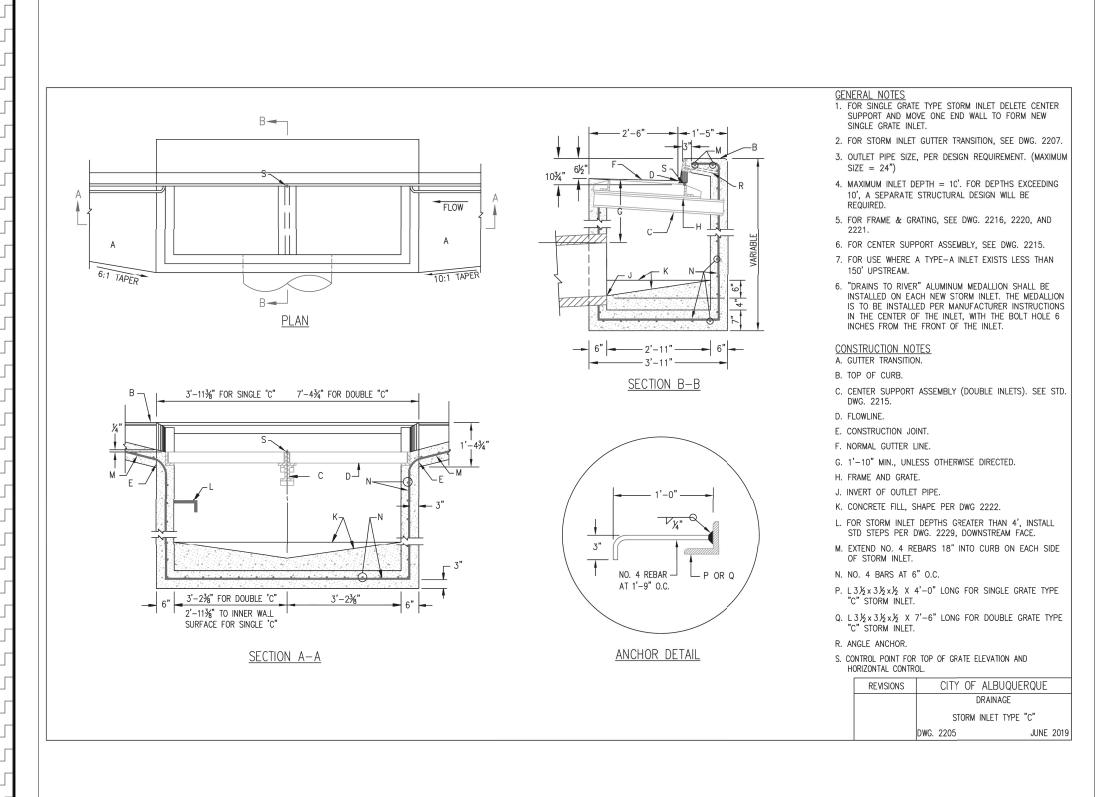

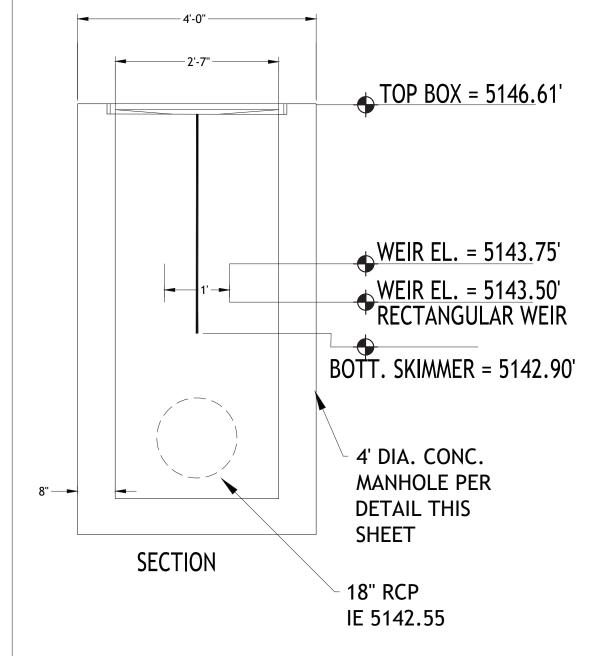

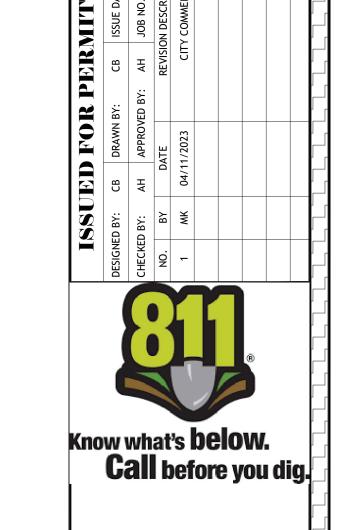



ATEF A. HANNA, PE #27436

CIVIL ENGINEERING
CIVIL ENGINEERING
LAND DEVELOPMENT ENGINEERS
8345 GUNN HIGHWAY
TAMPA, FL 33626

TAKE 5 CAR WASH

OF NEW MEXICO SNOW VISTA


98TH STREET ALBUQUERQUE, NM


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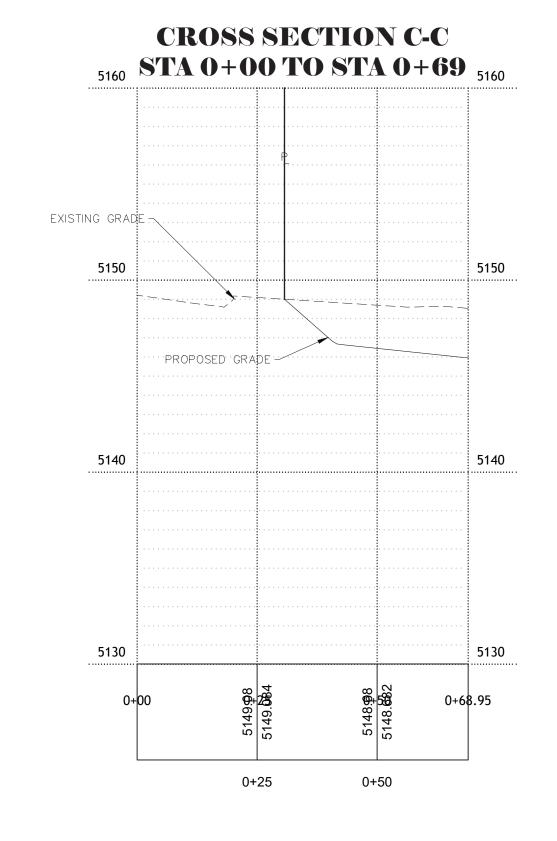
DRAINAGE AND GRADING DETAIL


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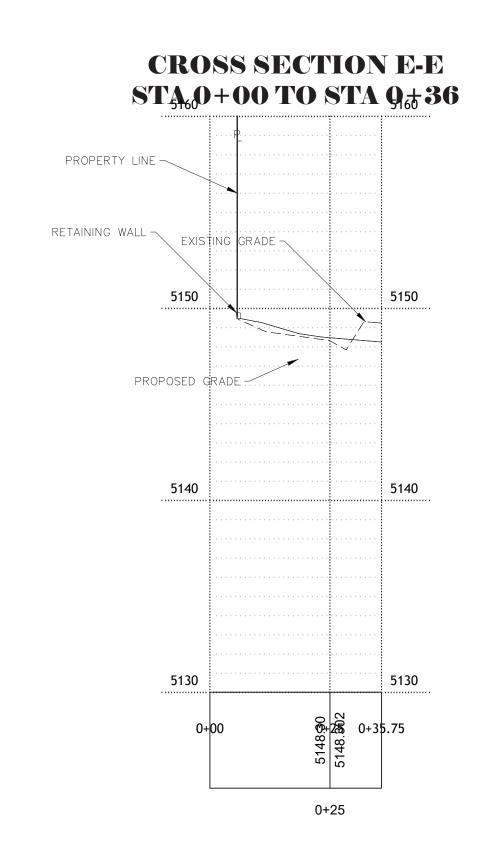
C - 4.2







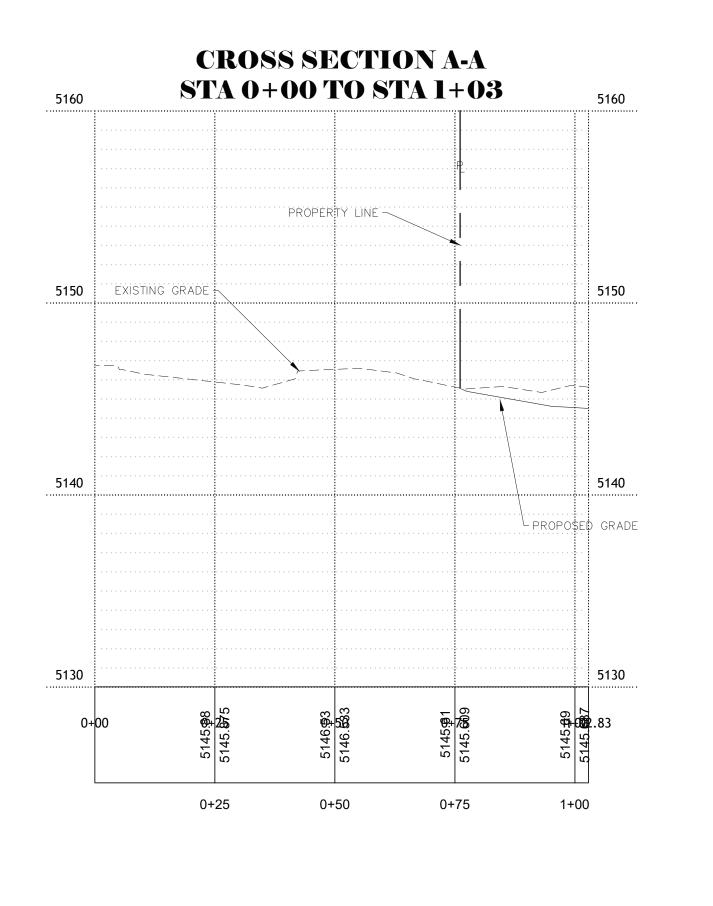

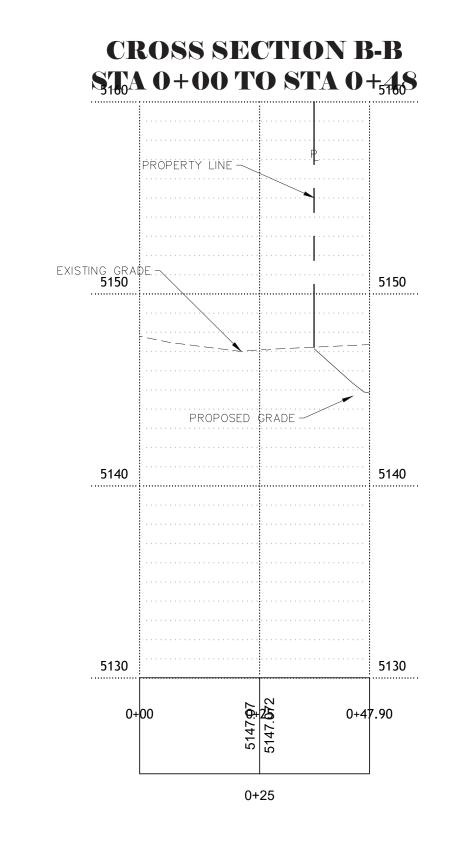

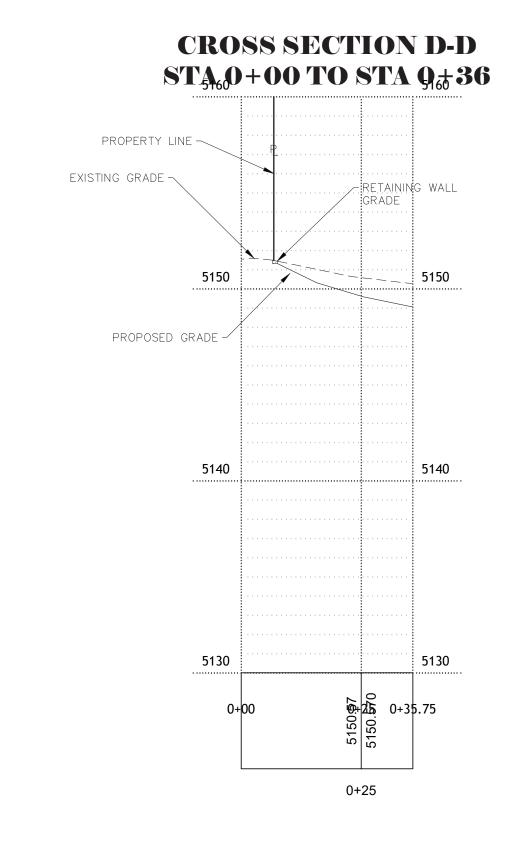


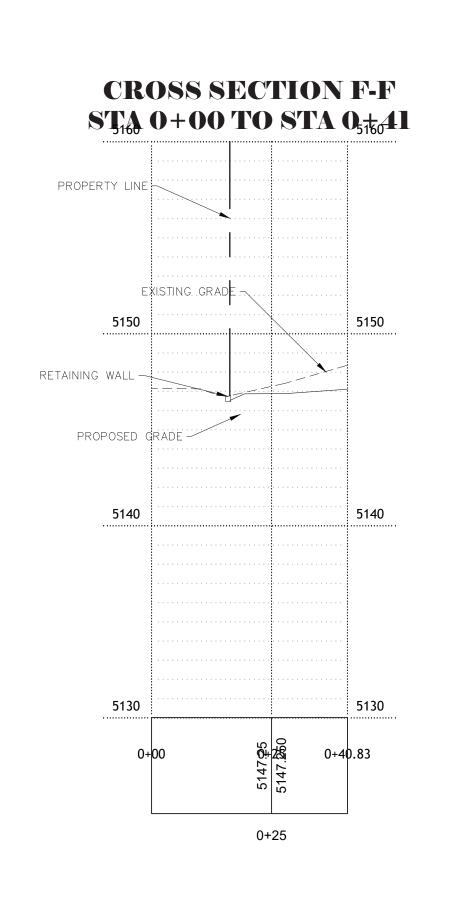

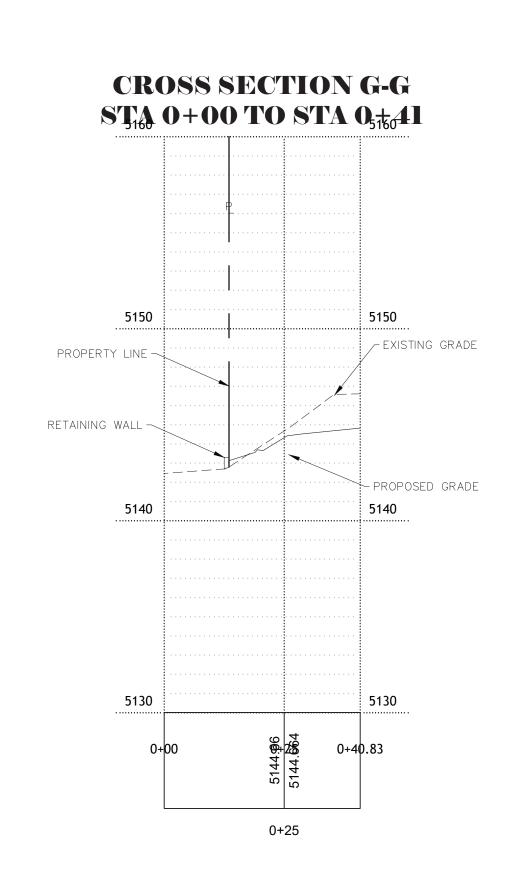

DESIGNED BY: CB DRAWN BY: CB ISSUE DATE: 04/2
CHECKED BY: AH APPROVED BY: AH JOB NO.: 2150
NO. BY DATE REVISION DESCRIPTION
1 MK 04/11/2023 CITY COMMENTS



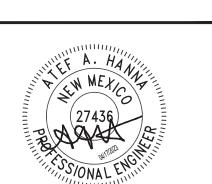

ATEF A. HANNA, PE #27436

LAND DEVELOPMENT ENGINEERS
8345 GUNN HIGHWAY
TAMPA, FL 33626

TAKE 5
CAR
WASH


OF NEW MEXICO SNOW VISTA

98TH STREET ALBUQUERQUE,

SHEET NAME:

GRADING DETAIL

SHEET NUMBER:

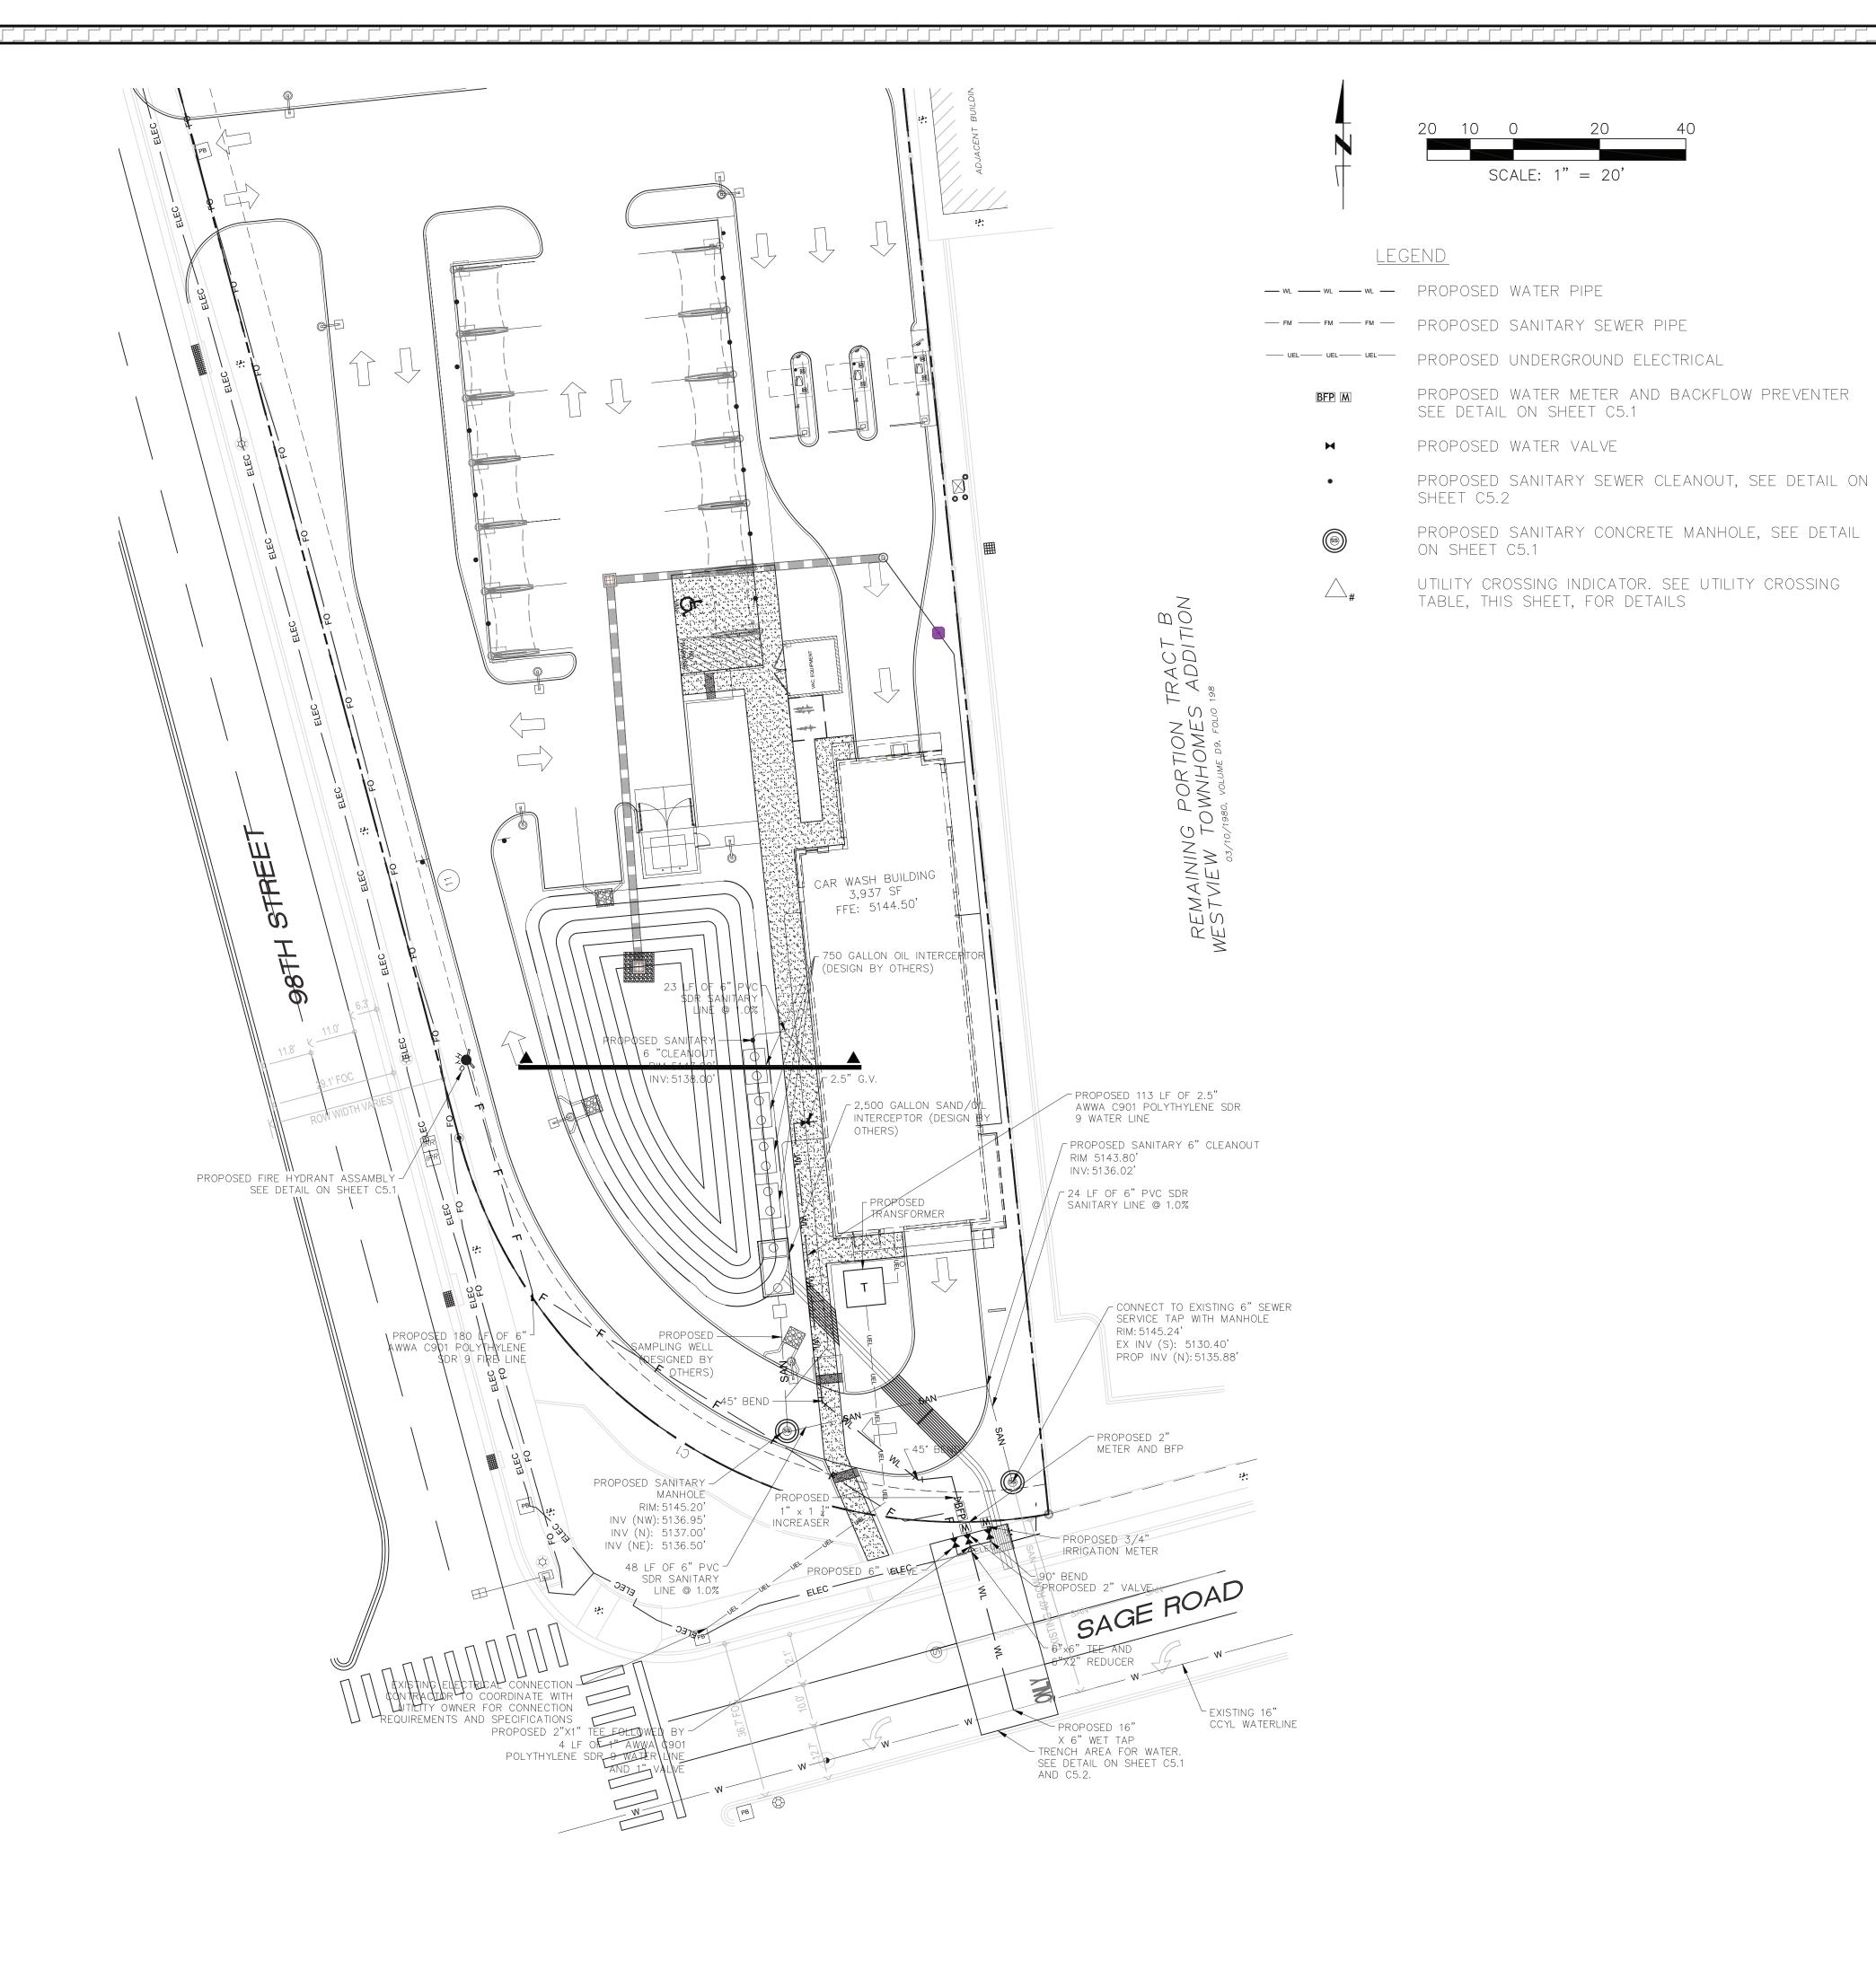

UTILITY NOTES

REFER TO SHEET C5.1 AND SHEET C5.2 OR UTILITY DETAILS.

REFER TO MEP PLANS FOR ALL UTILITY LEADS INTO BUILDING. SANITARY SEWER PIPES SHALL HAVE A MINIMUM SLOPE OF 1.00%.

4. PRIOR TO STARTING CONSTRUCTION, CONTRACTOR SHALL FIELD VERIFY ALL EXISTING UTILITIES AND THEIR LOCATIONS AND ELEVATIONS. IF ANY DISCREPANCIES OCCUR, THE CONTRACTOR SHALL ALERT ENGINEER IMMEDIATELY.

5. ALL PUBLIC UTILITIES INSPECTIONS SHALL BE SCHEDULED BY THE CONTRACTOR AT LEAST 72 HOURS PRIOR TO ANY CONSTRUCTION

6. ALL DEMOLITION AND CONSTRUCTION WORK PERFORMED SHALL BE DONE IN STRICT ACCORDANCE WITH GOVERNING JURISDICTIONAL CODES.

7. ALL UTILITY CONDUIT MATERIAL FOR TELEPHONE, CABLE, AND ELECTRIC SHALL BE INSTALLED PER UTILITY PROVIDER SPECIFICATIONS BY THE CONTRACTOR.

8. CONTRACTOR SHALL BUILD CONCRETE TRANSFORMER PAD AND INSTALL SCHEDULE 80 PVC CONDUIT AND PULL STRING WITH SWEEPING BENDS, IF APPLICABLE BY ELECTRIC COMPANY.

9. ALL SANITARY GRAVITY PIPES, SERVICE LATERALS, AND FITTINGS SHALL BE MATERIALS APPROVED BY THE GOVERNING JURISDICTION.

10. ALL NON-METALLIC PIPE WILL BE INSTALLED WITH 2 PAIR, 10 GAUGE, COPPER TRACE WIRE.

11. CONTRACTOR SHALL COORDINATE WITH GOVERNING JURISDICTION(S) FOR ANY PROPOSED WET TAPS AND R.O.W. CONNECTIONS.

12. ALL UTILITIES SHALL MAINTAIN AT LEAST 3 FEET OF COVER FROM TOP OF PIPE TO SURFACE ELEVATION. CONTRACTOR SHALL DEFLECT WATER AND FORCE MAINS AS NECESSARY TO ACHIEVE MINIMUM GOVERNING JURISDICTION(S) SEPARATION REQUIREMENTS.

13. CONTRACTOR MUST COORDINATE THE SHUTDOWN OF THE EXISTING POTABLE WATER, WASTEWATER FORCEMAIN, OR RECLAIMED WATER MAIN WITH GOVERNING JURISDICTION(S), IF NECESSARY.

14. OVER STORY TREES SHALL NOT BE LOCATED WITHIN 12 FT OF ANY PUBLIC UNDERGROUND OR OVERHEAD UTILITY LINE.

15. CONTRACTOR SHALL VERIFY LOOP DETECTORS TO AVOID UTILITY CONFLICTS PRIOR TO CONSTRUCTION, IF APPLICABLE.

16. CONTRACTOR SHALL PROTECT ALL UTILITIES OUTSIDE LIMITS OF CONSTRUCTION UNLESS OTHERWISE NOTED IN THE CONSTRUCTIONS PLANS OR SPECIFICATIONS.

17. ALL DISTURBED AREAS WITHIN THE SIDEWALK / CURB AND GUTTER / ROAD PAVEMENT SHALL BE RESTORED TO ITS ORIGINAL OR BETTER CONDITIONS. 18. THE SANITARY SEWER SYSTEM IN ALL ITS ENTIRETY IS PRIVATELY OWNED

AND MAINTAINED WITHIN PROPERTY BOUNDARIES. 19. THE LOCATION OF ALL NEWLY INSTALLED FIRE HYDRANTS SHALL BE

IDENTIFIED WITH A BLUE REFLECTIVE PAVEMENT MARKER INSTALLED ON THE ROADWAY, PERPENDICULAR TO THE FIRE HYDRANT. THE REFLECTIVE MARKER WILL BE LOCATED IN THE CENTER OF THE LANE CLOSEST TO THE HYDRANT, IF APPLICABLE.

20. IF APPLICABLE, THE CONTRACTOR WILL BE RESPONSIBLE FOR THE FLOW TESTING AND COLOR CODING OF ALL NEWLY INSTALLED FIRE HYDRANTS IN THE GOVERNING JURISDICTION(S) RIGHT OF WAY AND UTILITY EASEMENTS THAT ARE TO BE DEDICATED TO GOVERNING JURISDICTION(S) PRIOR TO THE FINAL INSPECTION OF THE PROJECT. THE CONTRACTOR SHALL REFER TO NFPA STANDARD 291 FOR FLOW TESTING AND COLOR CODING METHODS AND PROCEDURES.

21. ALL PROPOSED WATER SUPPLY AND FIRE HYDRANTS SHALL COMPLY NFPA-1, CHAPTER 18.3

22. CONTRACTOR SHALL NOTIFY ENGINEER OF RECORD (E.O.R.) 72 HOURS IN ADVANCE OF ALL INSPECTIONS THAT REQUIRE THE E.O.R. OR E.O.R. REPRESENTATIVE'S PRESENCE.

23. CONTRACTOR SHALL DEFLECT ALL PROPOSED WATER MAINS AND FORCE MAINS TO ACHIEVE 18" MIN. VERTICAL CLEARANCE FROM ALL EXISTING AND PROPOSED UTILITIES.

24. CONTRACTOR SHALL ADJUST TOP OF ALL CLEANOUTS, VALVES, AND STRUCTURE RIMS TO BE FLUSH WITH FINAL GRADE.

25. ALL TRENCHING AND BACKFILL OPERATIONS SHALL COMPLY WITH GOVERNING JURISDICTIONAL STANDARDS. SEE SHEET C5.1 AND C5.2 FOR PIPE TRENCHING DETAILS.




Know what's **below**. **Call** before you dig.



ATEF A. HANNA, PE #27436



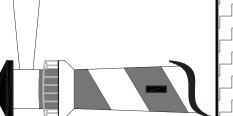

TAKE 5 CAR WASH


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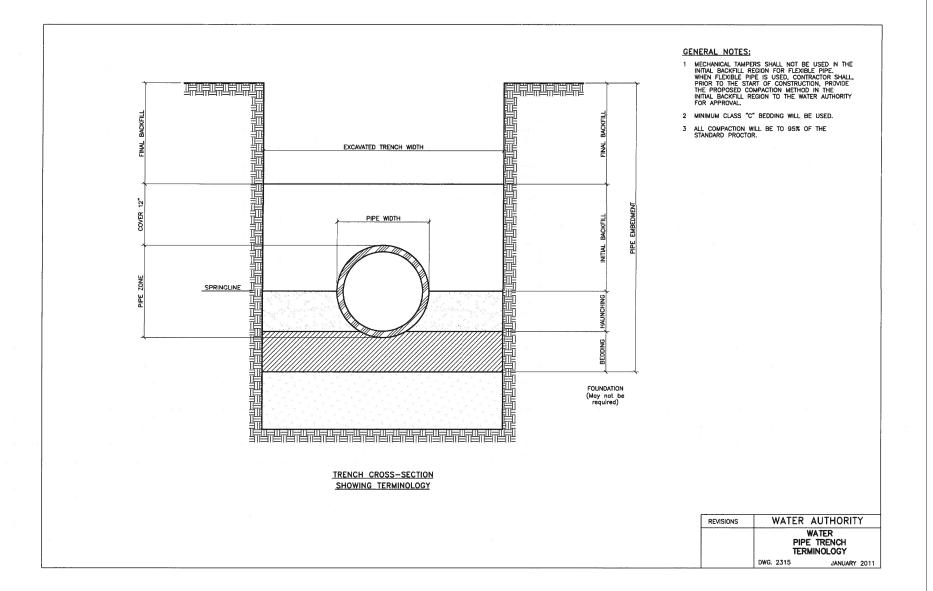
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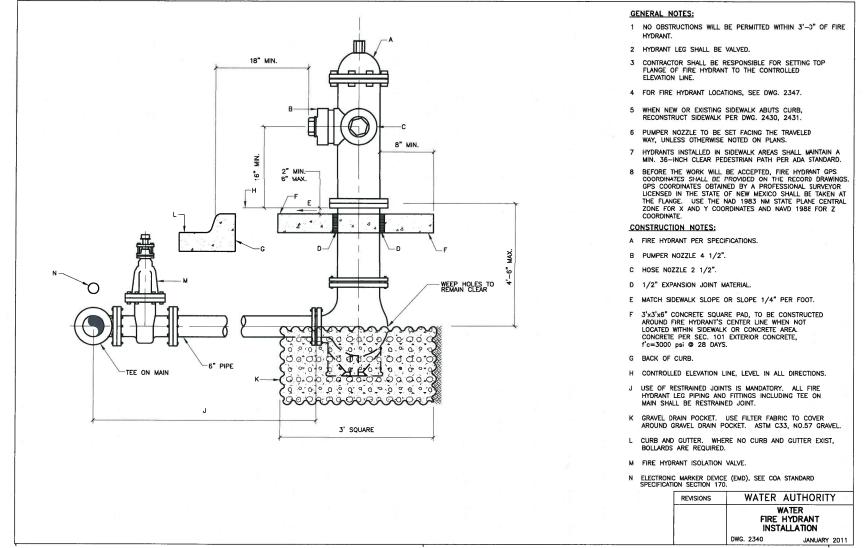
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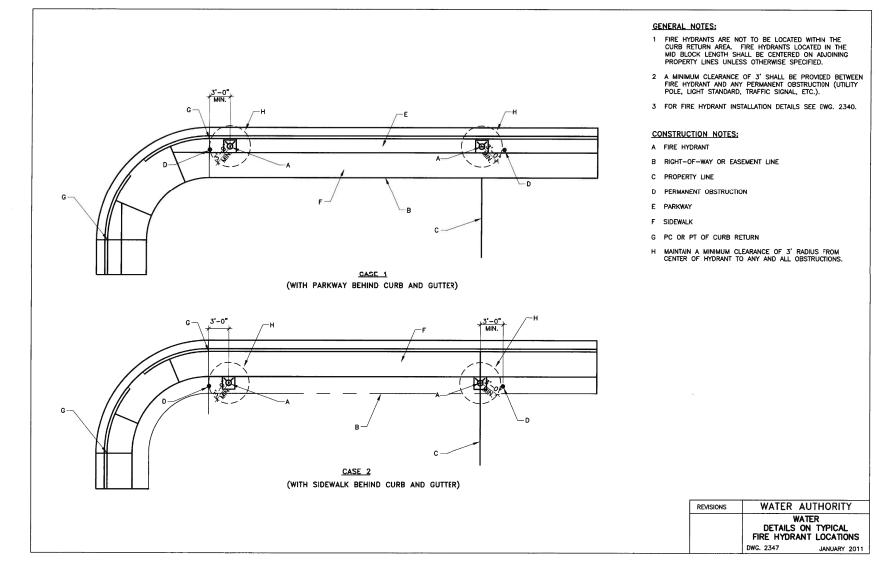
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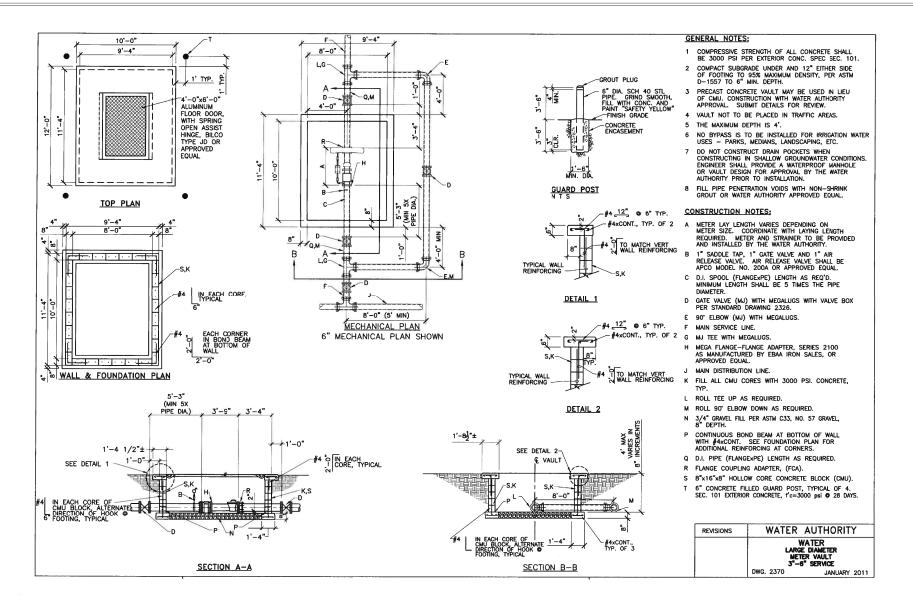
C - 5.0











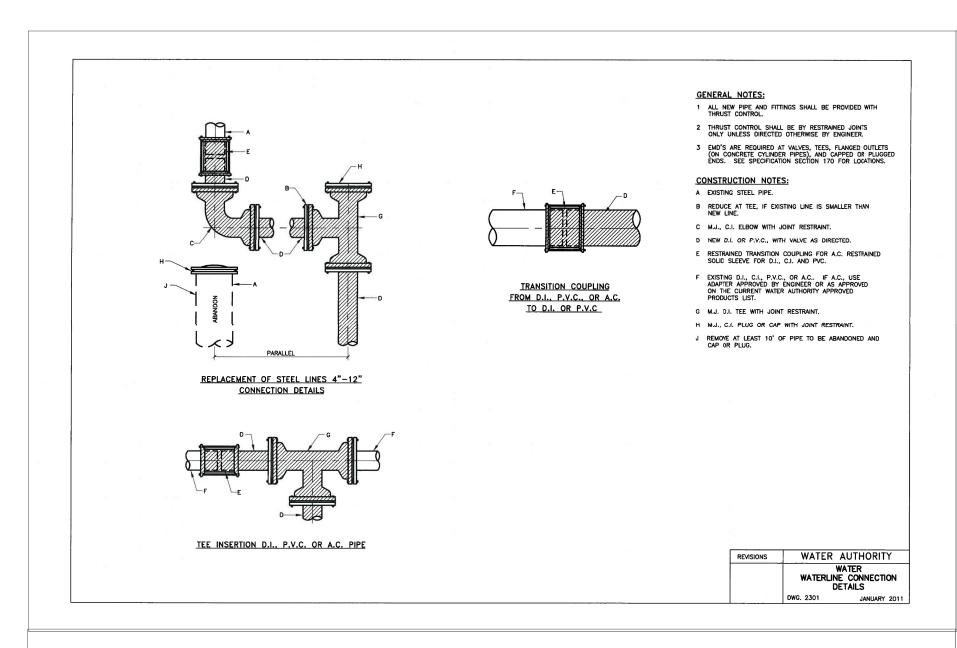

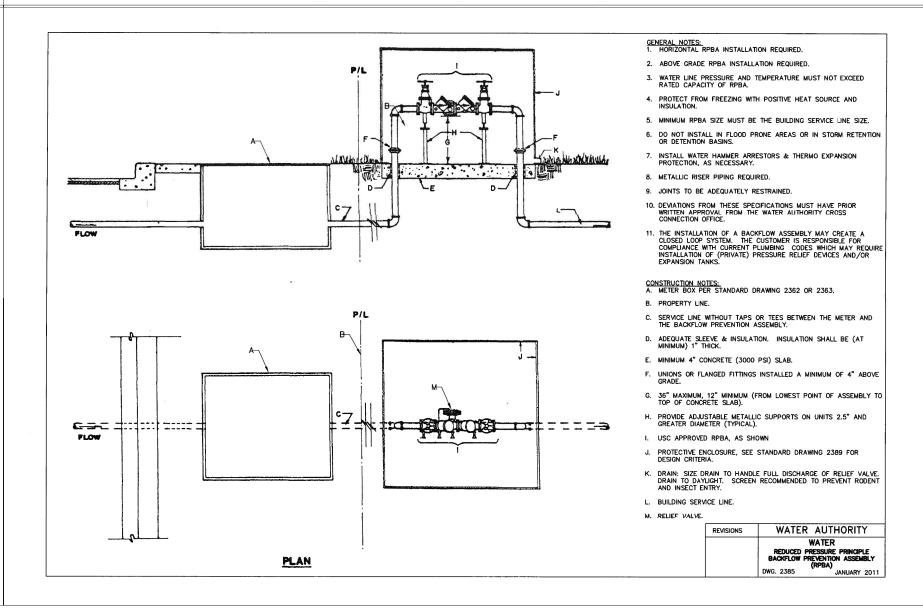

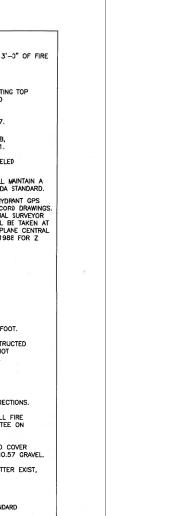





CIVIL ENGINEERING
CIVIL ENGINEERING
LAND DEVELOPMENT ENGINEERS
8345 GUNN HIGHWAY
TAMPA, FL 33626

TAKE 5 CAR WASH

OF NEW MEXICO SNOW VISTA


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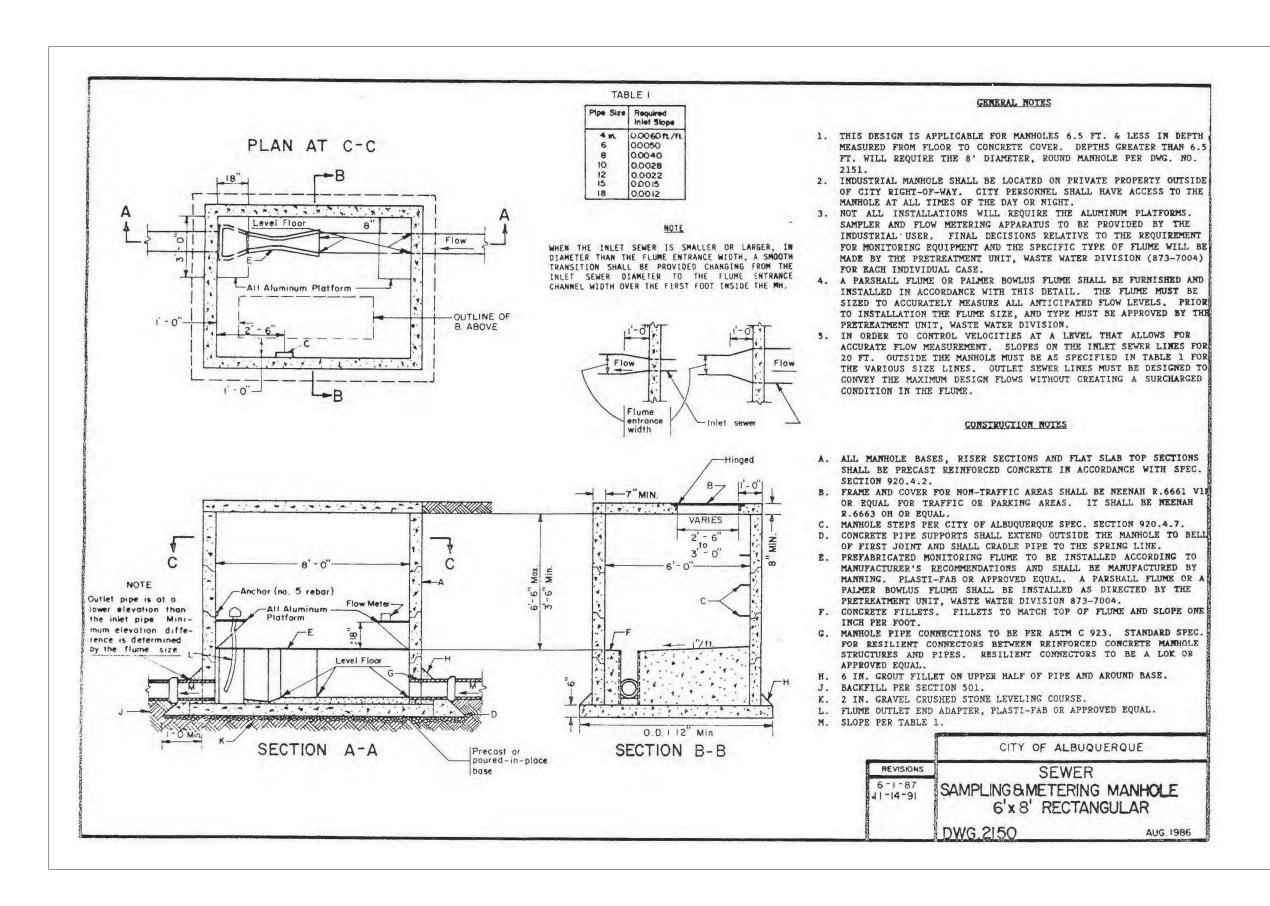
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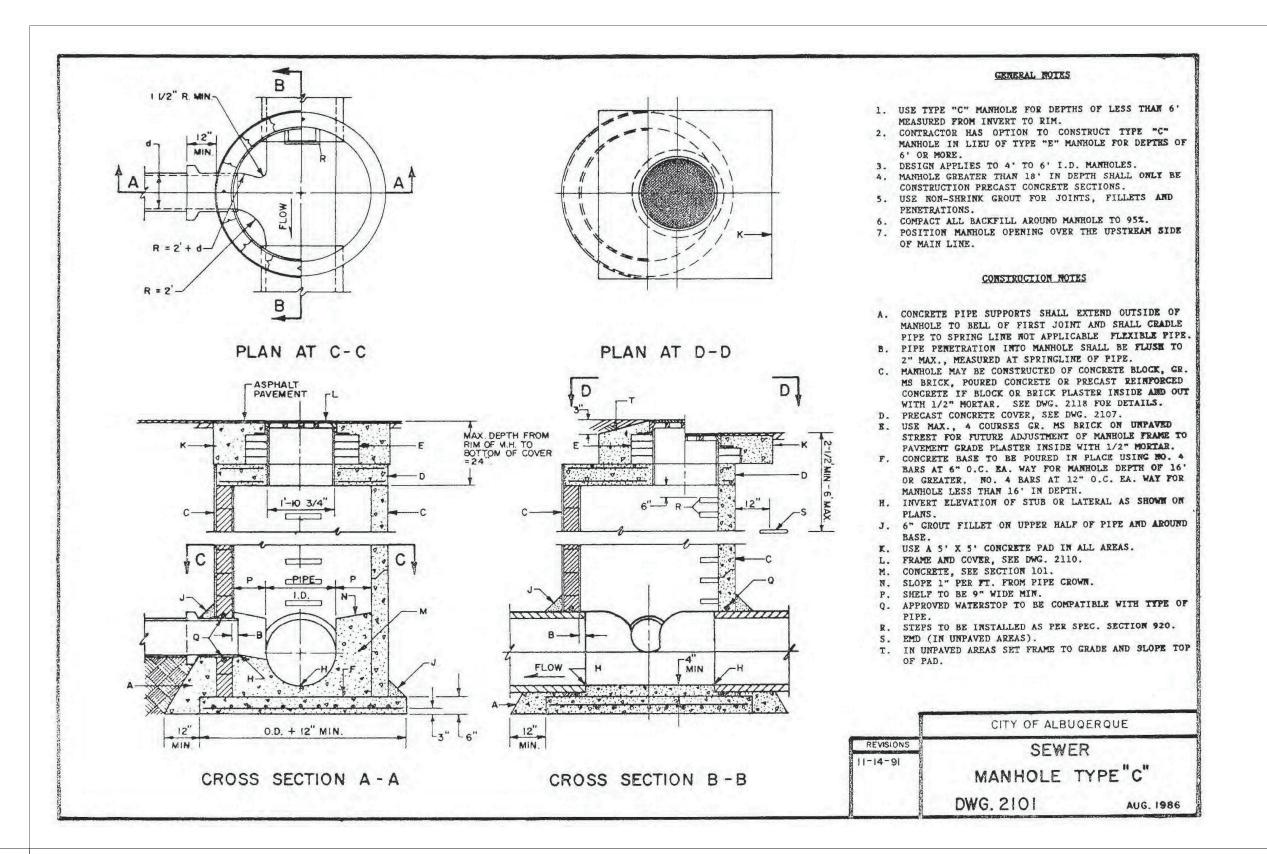
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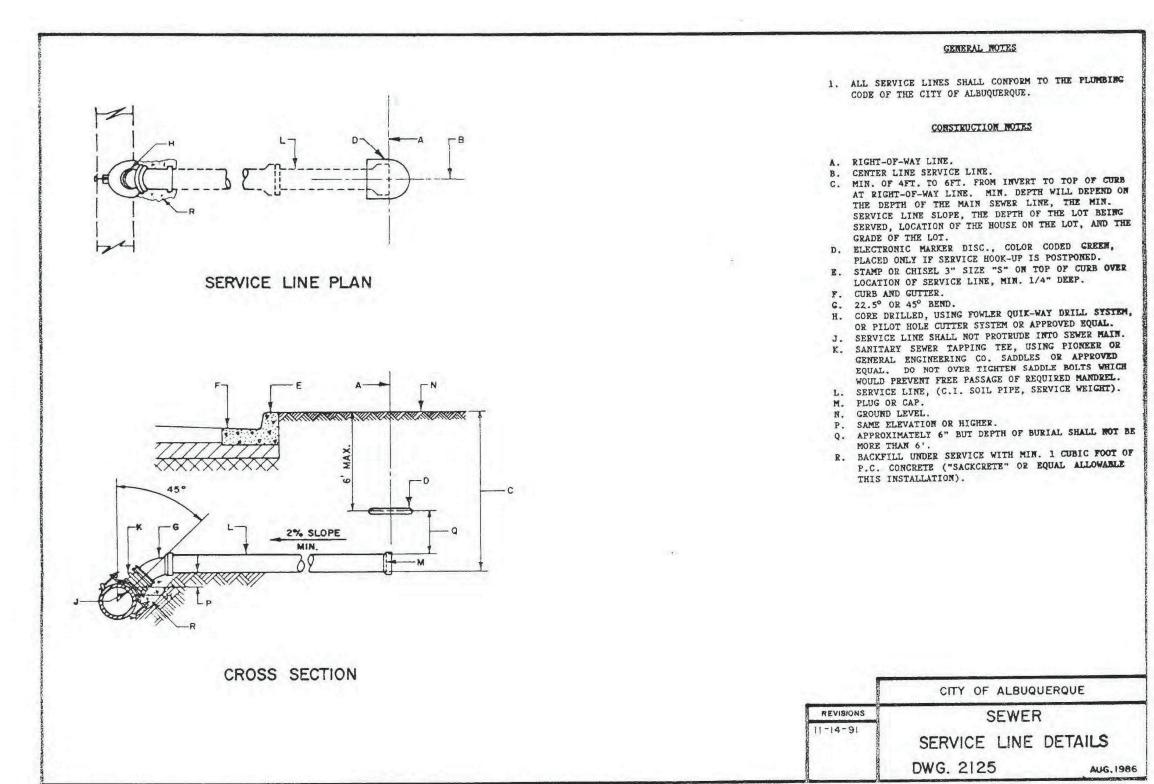
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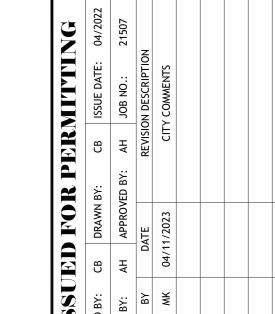
C - 5.1









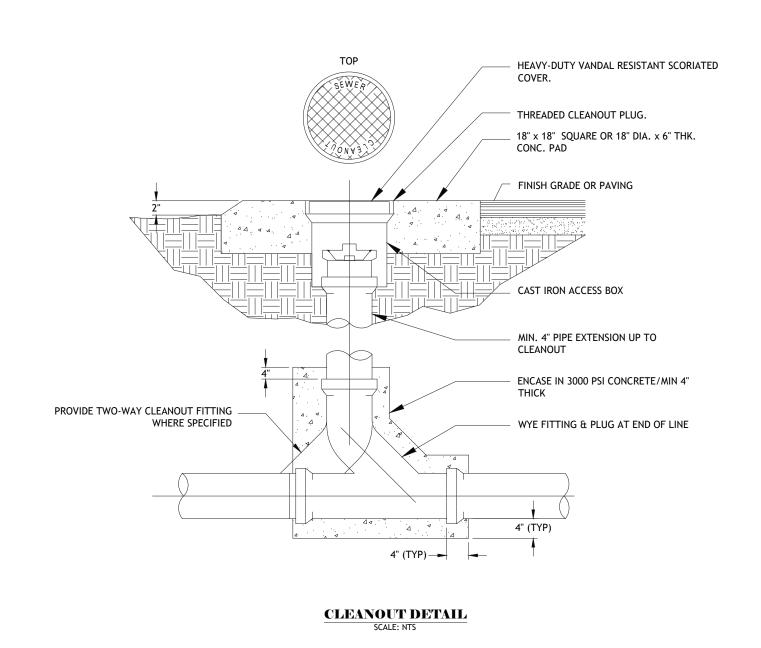





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8345 GUNN HIGHWAY
TAMPA, FL 33626

TAKE 5 CAR WASH

OF NEW MEXICO SNOW VISTA


98TH STREET ALBUQUERQUE, NM

SHEET NAME:

UTILITY DETAILS

SHEET NUMBER:

C - 5.2

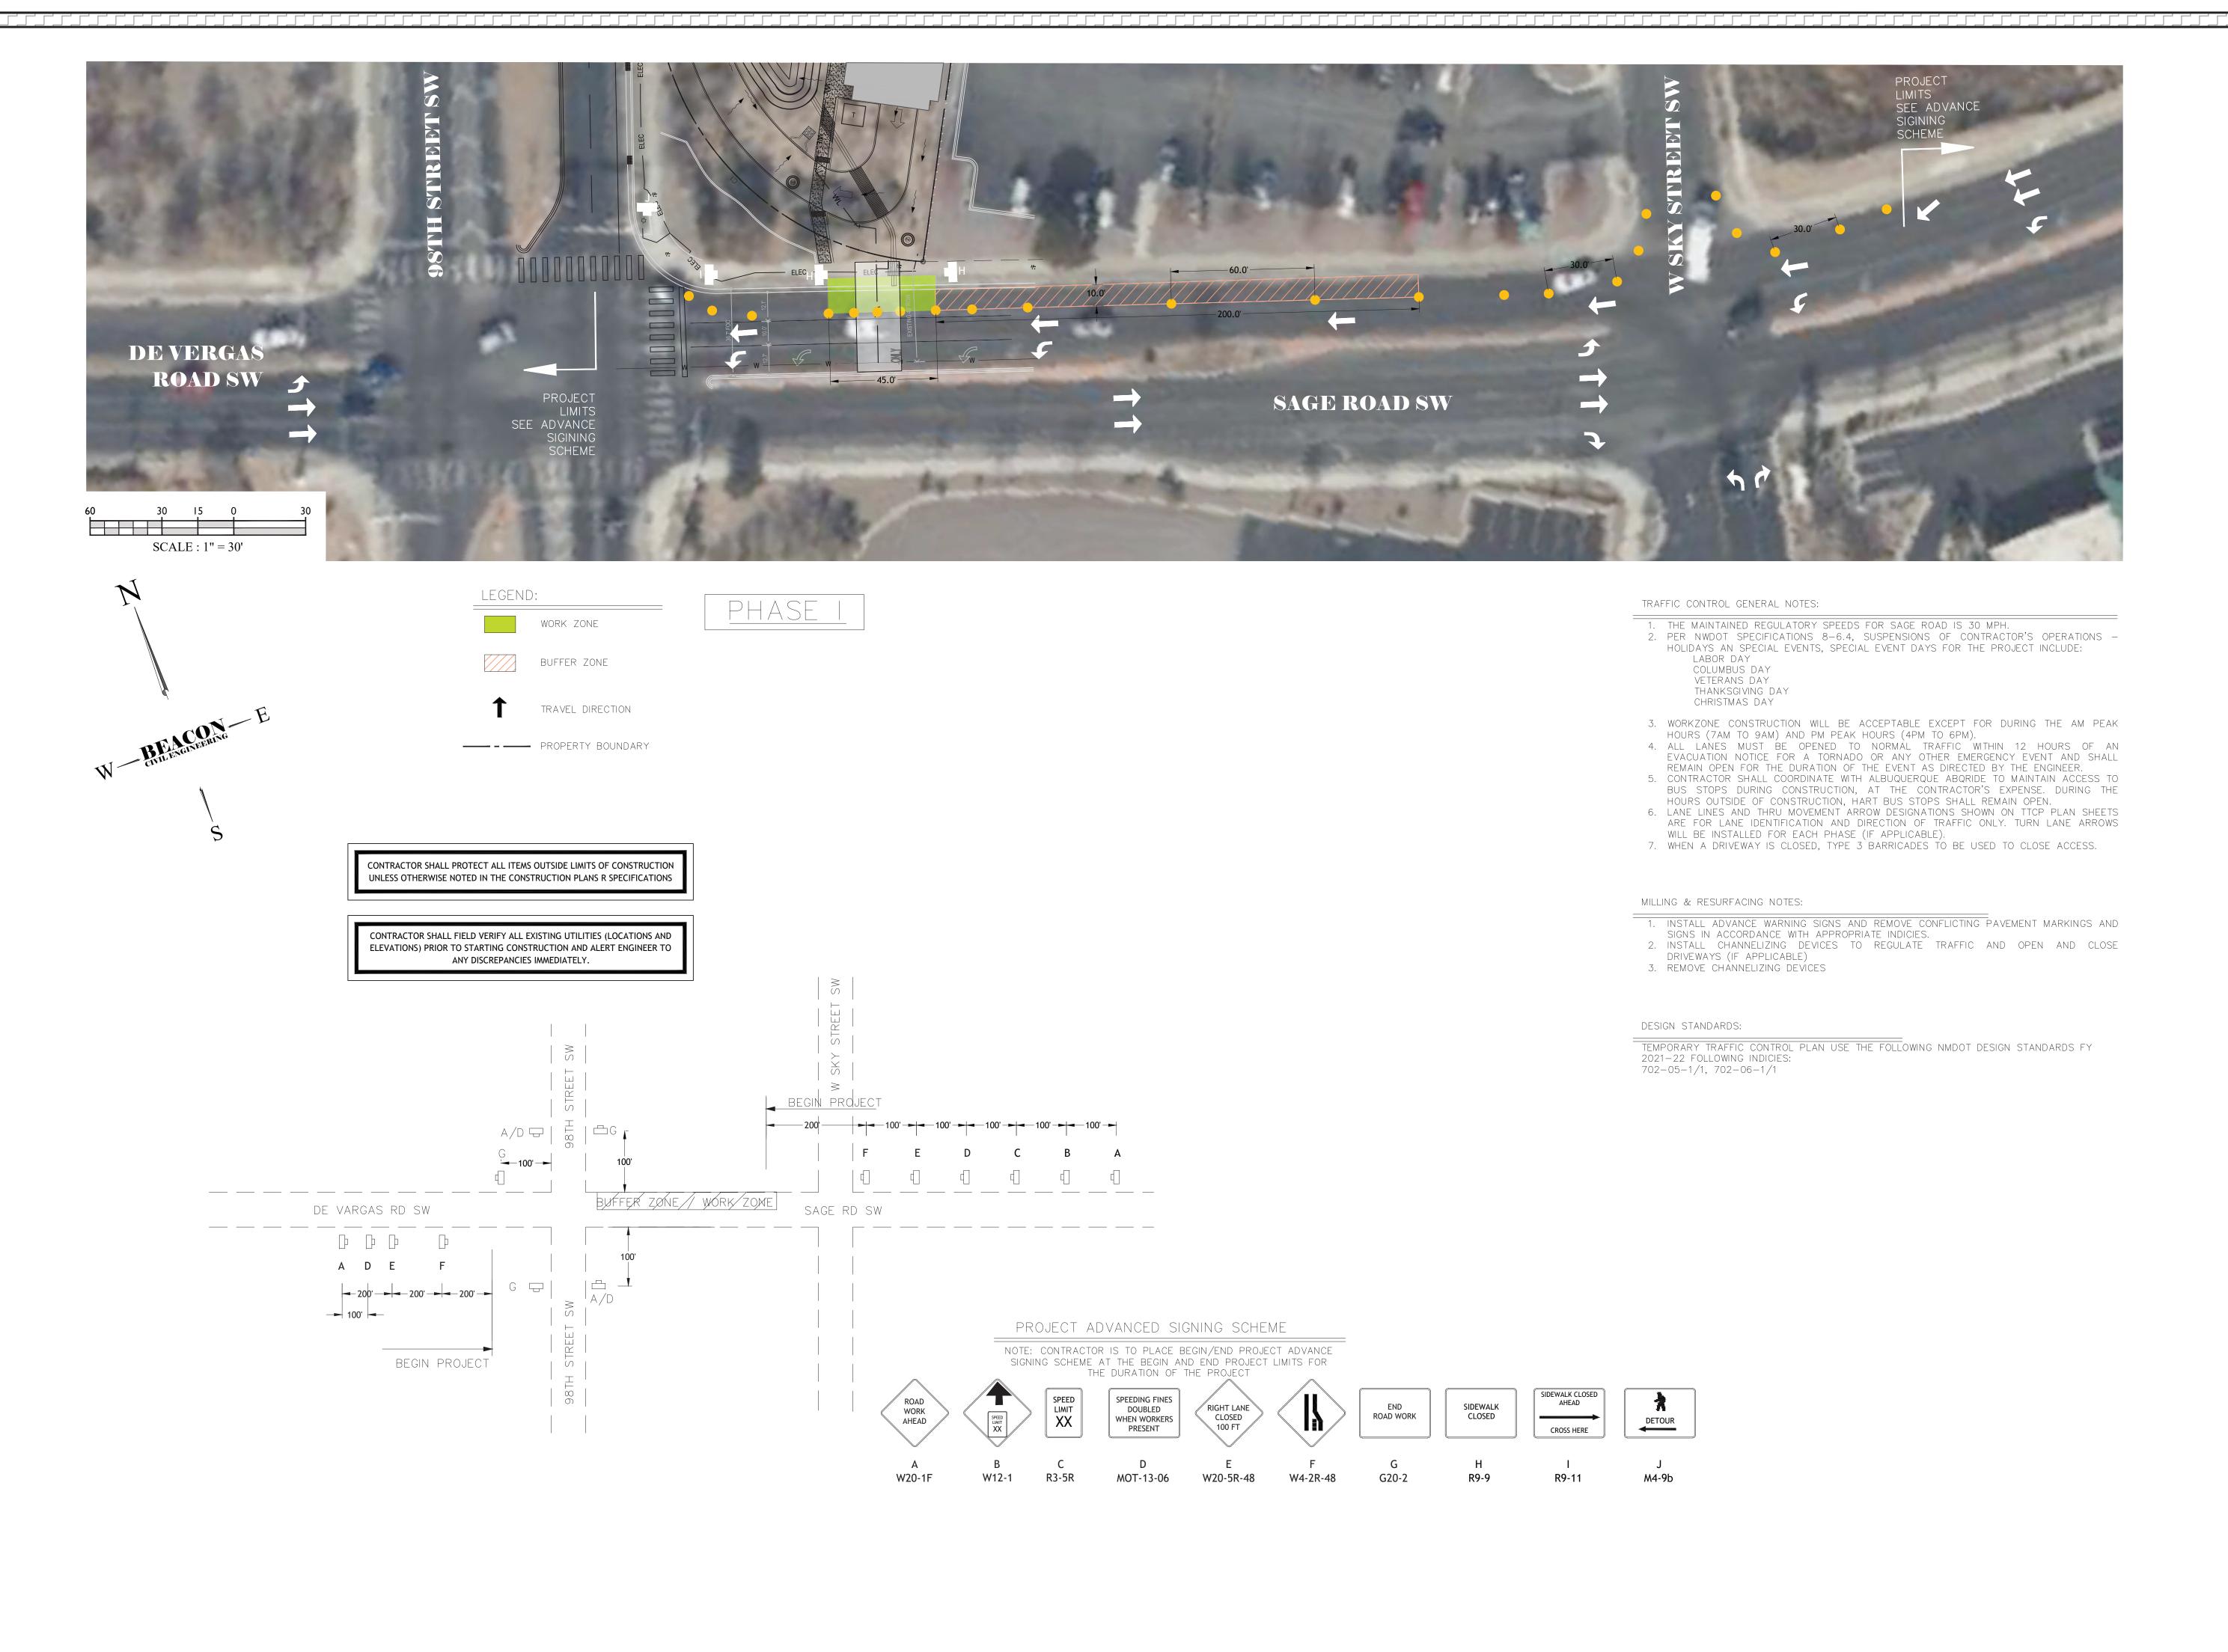

FOR PERMITTING

DRAWN BY: CB ISSUE DATE: 04/20
APPROVED BY: AH JOB NO.: 21507
ATE REVISION DESCRIPTION
ATE CITY COMMENTS

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CIVIL ENGINEERIN

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LAND DEVELOPMENT ENGINEERS
8345 GUNN HIGHWAY

TAMPA, FL 33626

TAKE 5
CAR
WASH

OF NEW MEXICO SNOW VISTA


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ALBUQUERQUE,

SHEET NAME:

MOT PLAN-PHASE1


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H APPROVED BY: AH JOB NO.: 2150
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CIVIL ENGINEERING
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LAND DEVELOPMENT ENGINEERS
8345 GUNN HIGHWAY

TAKE 5 CAR WASH

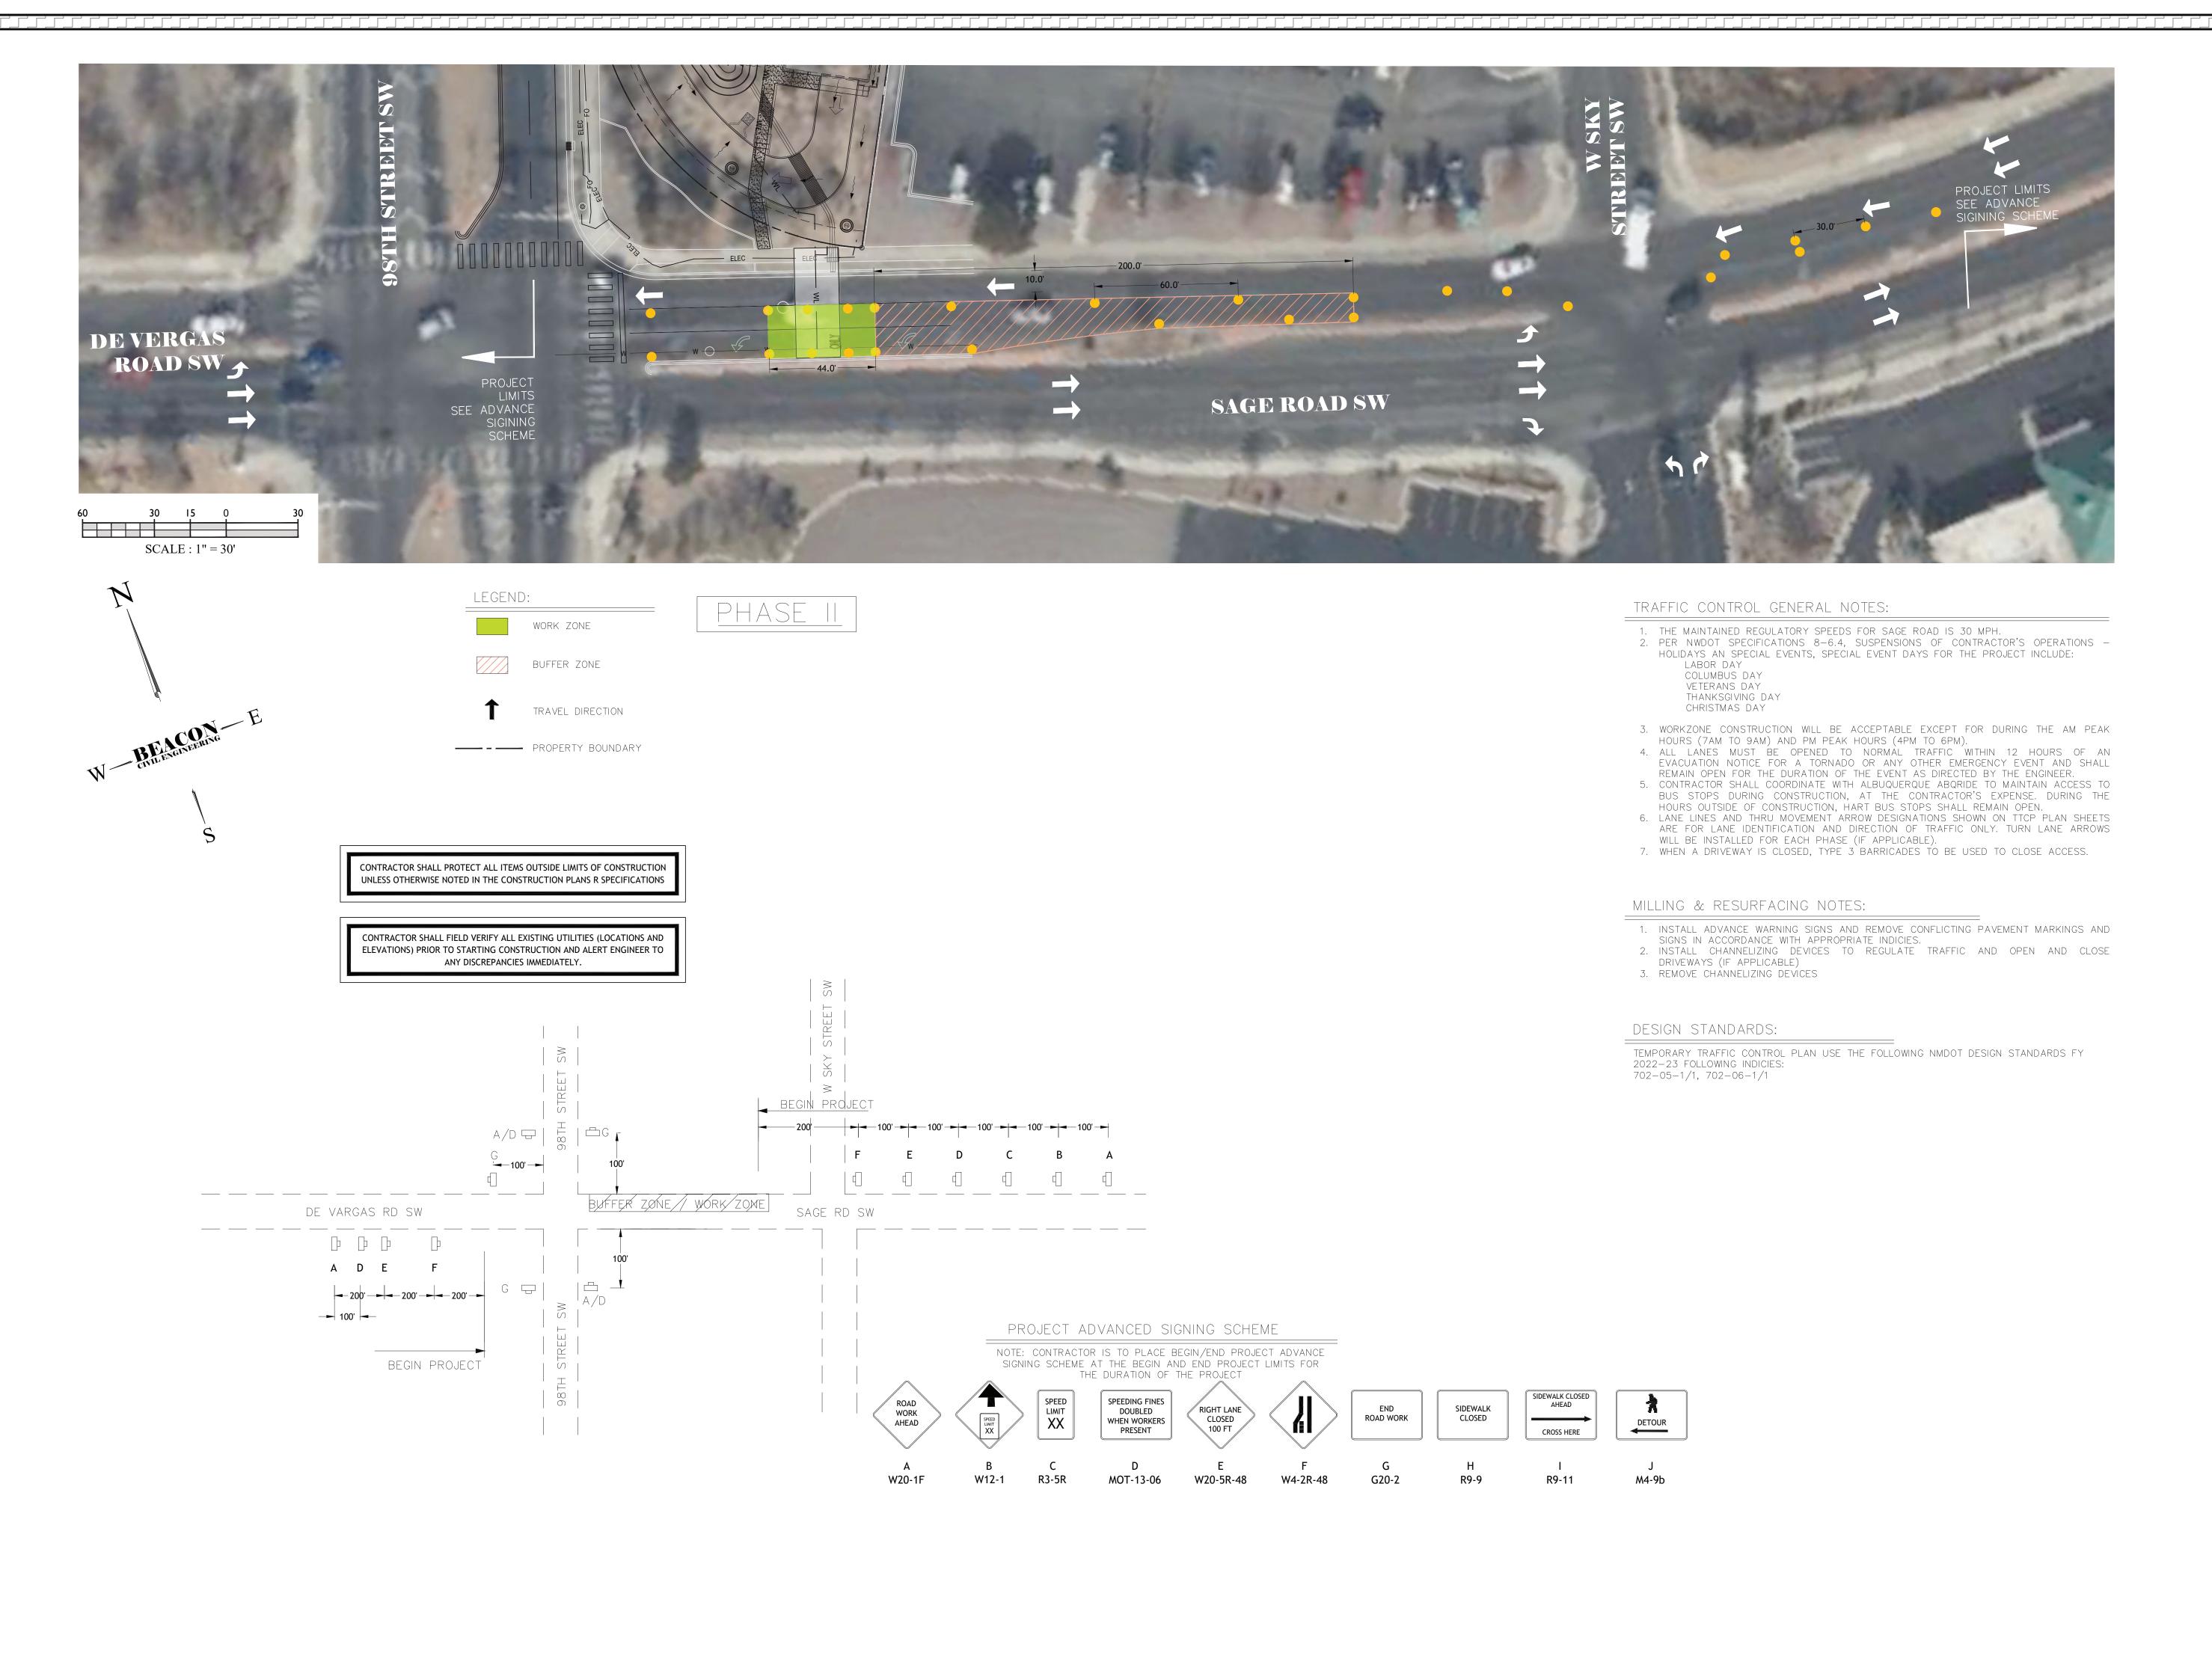
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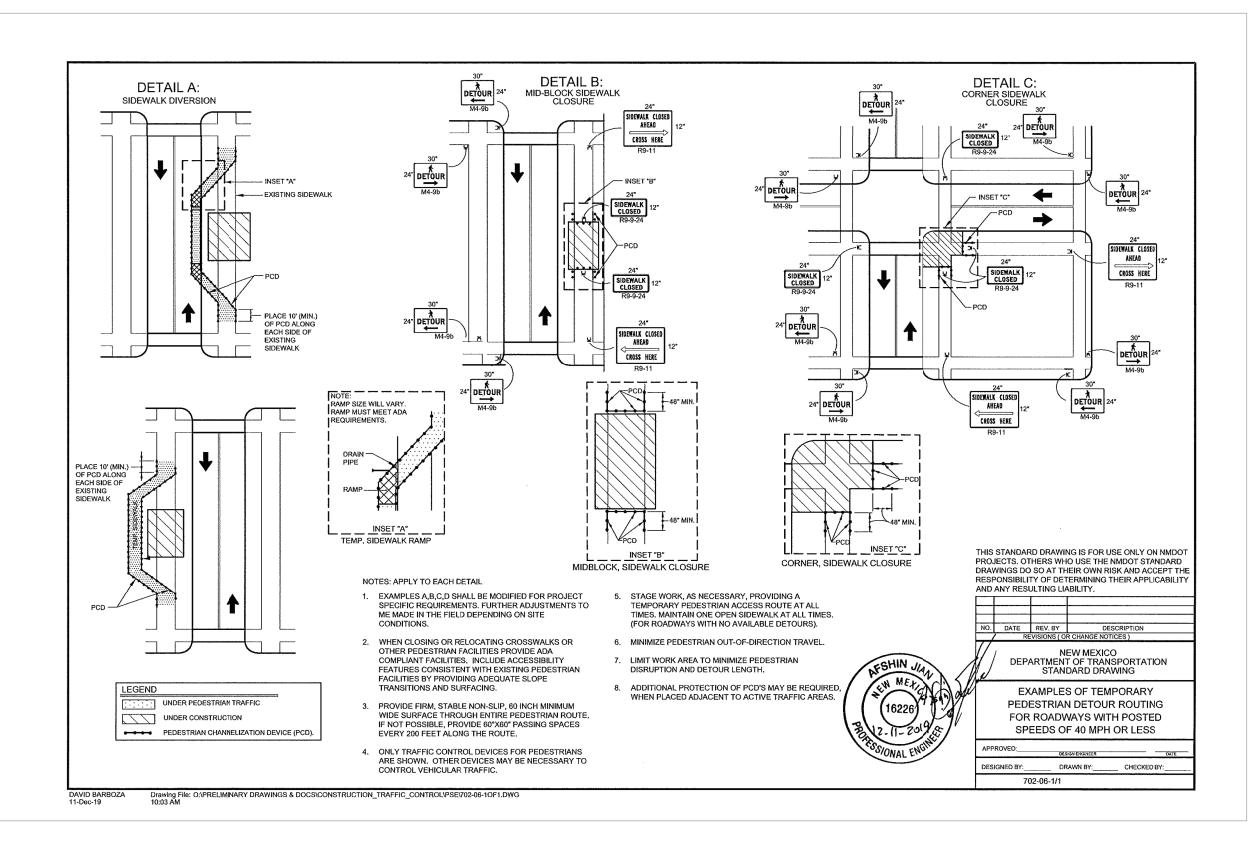
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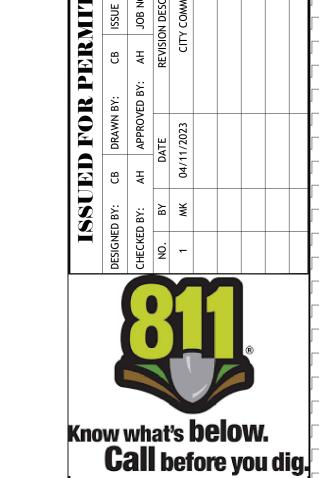
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MOT PLAN-PHASE 2

SHEET NUMBER: C-6.1



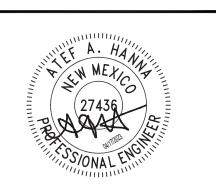




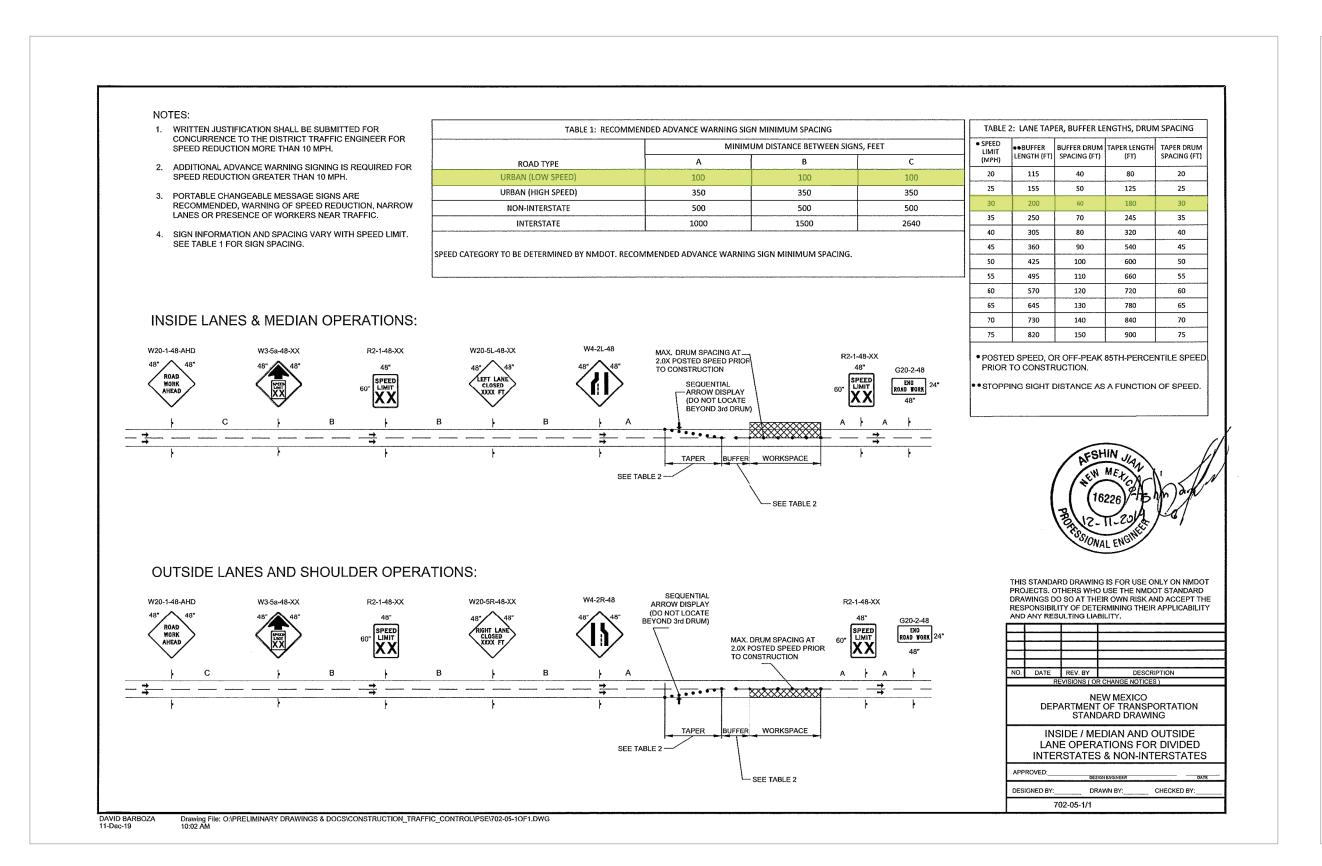

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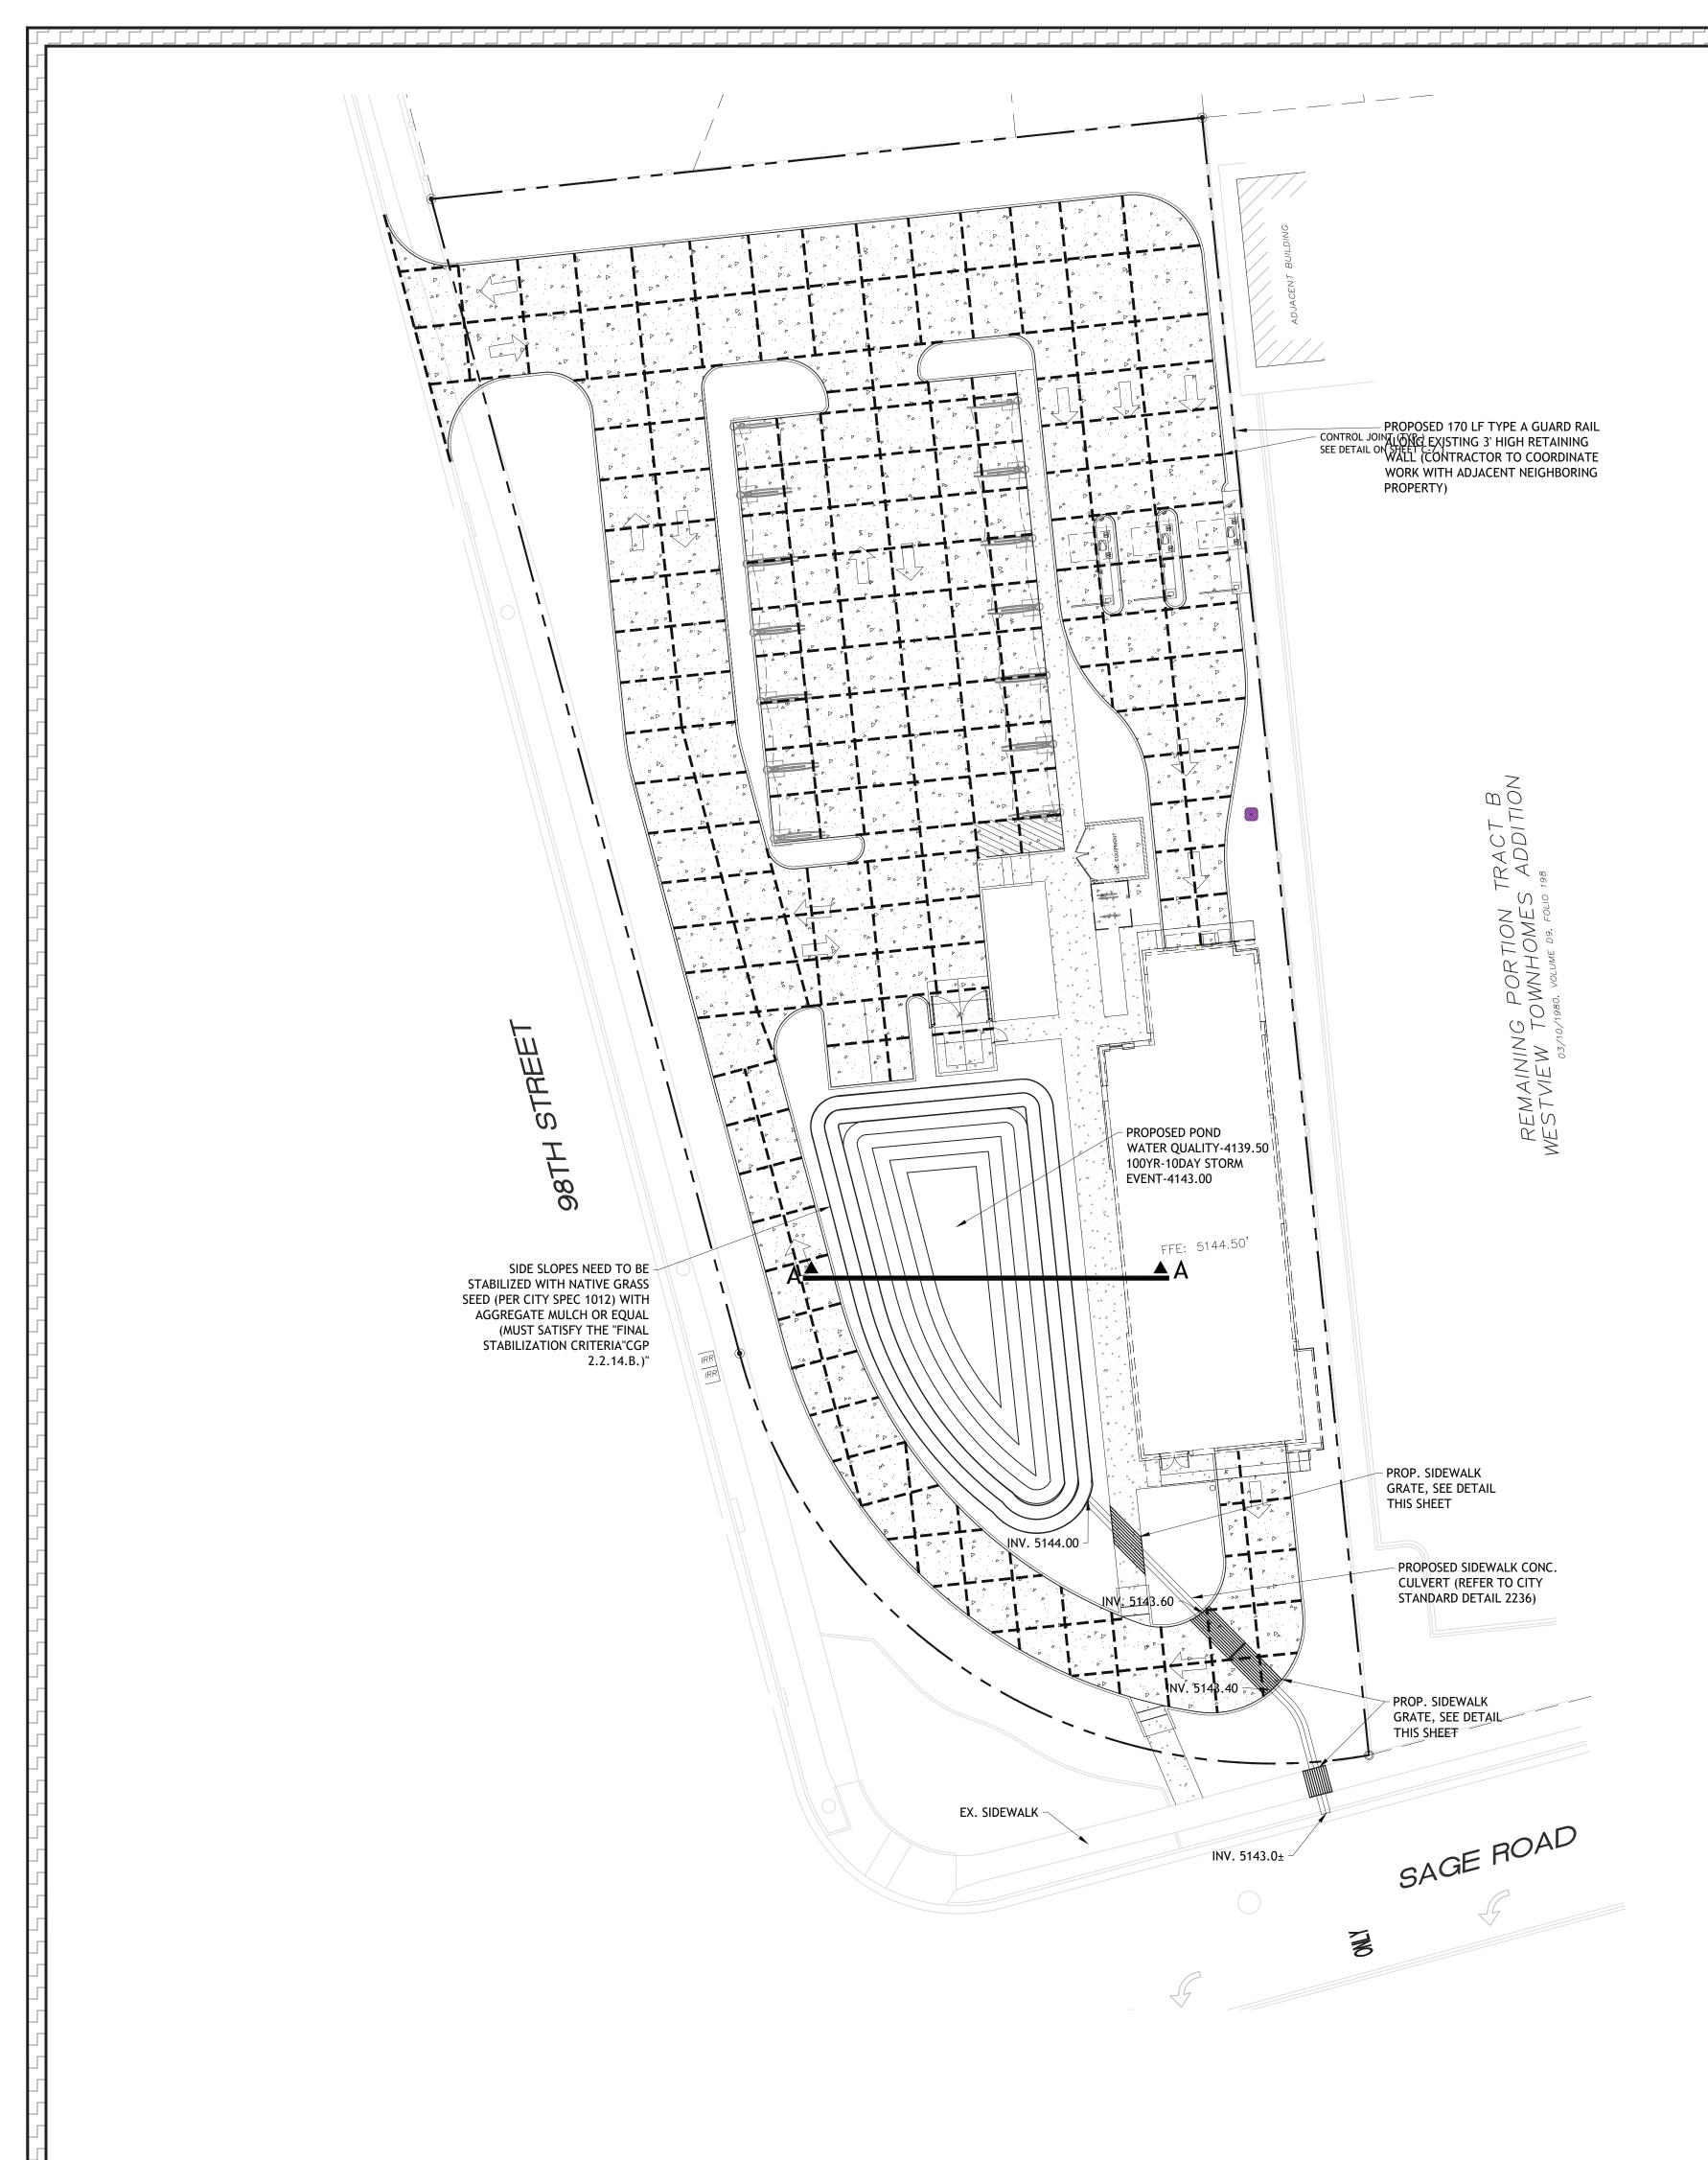
OF NEW MEXICO SNOW VISTA

98TH STREET ALBUQUERQUE, NM

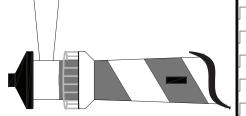HEET NAME

MOT DETAILS

SHEET NUMBER: C-6.2



GEOTECH NOTE CONTRACTOR TO REVIEW AND REFER TO THE GEOTECHNICAL REPORT RECOMMENDATIONS.

CONTROL JOINTS SHALL BE SPACED APPROXIMATELY AS SHOWN ON THE JOINT PLAN AND SHALL HAVE A MAX SPACING OF 12' IN ANY DIRECTION 2. SAW CUTTING SHALL BE DONE WITHIN EIGHT HOURS OF HARDENING. SAW-CUT JOINTS SHOULD EXTEND A MINIMUM OF 1/4 OF THE CONCRETE THICKNESS, ALL

MISSOURI DEPARTMENT OF TRANSPORTATION. 3. THE CONTRACTOR SHALL PROVIDE AN EXPANSION JOINT AROUND THE PERIMETER OF ANY BLOCKOUT IN THE CONCRETE PAVING.

CONCRETE JOINTS SHOULD CONFORM WITH APPLICABLE SPECIFICATIONS OF THE

. PAVEMENT DESIGN: ALL ON SITE CONCRETE PAVING SHALL BE OF THE THICKNESS AND STRENGTH SHOWN ON THE PLAN. CONCRETE SHALL BE THE DESIRED STRENGTH AT 28 DAYS.

2. TEMPERATURE CONDITIONS FOR CONCRETE PLACEMENT: CONCRETE SHALL NOT BE PLACED WHEN THE TEMPERATURE IS BELOW 40 DEGREES FAHRENHEIT AND FALLING, BUT MAY BE PLACED WHEN TEMPERATURE IS ABOVE 35 DEGREES FAHRENHEIT AND RISING. THE TEMPERATURE READING SHALL BE TAKEN IN THE SHADE AND AWAY FROM ARTIFICIAL HEAT.

3. CONCRETE PAVEMENT CURING: CONCRETE TO BE FLOAT FINISHED AND CURED FOR A MINIMUM OF 7 DAYS. MEMBRANE CURING TYPE 2, WHITE PIGMENTED, SHALL BE USED FOR CURING ALL CONCRETE SURFACES IMMEDIATELY AFTER FINISHING OF SURFACES AND SHALL BE IN ACCORDANCE WITH THE SOUTH CAROLINA HIGHWAY STANDARD SPECIFICATIONS.

4. SUBGRADE PREPARATION: SUBGRADE SHALL BE COMPACTED TO 100% OF THE MAXIMUM DRY DENSITY. REFER TO GEOTECHNICAL REPORT.

5. PREPARATION OF SUBGRADE UNDER PAVED AREAS SHALL BE PERFORMED IN ACCORDANCE WITH THE GOVERNING AUTHORITIES' SPECIFICATIONS OR THE GEOTECHNICAL REPORT. THE MORE RESTRICTIVE REQUIREMENTS SHALL APPLY. 6. PREPARATION OF THE SUBGRADE FOR PAVING WITHIN RIGHT-OF-WAY, ACCESS EASEMENTS AND/OR FIRE LANES SHALL NOT BE INITIATED UNTIL ALL TESTING OF UNDERGROUND UTILITIES HAS BEEN COMPLETED AND VERIFIED TO MEET THE

GOVERNING AUTHORITIES' SPECIFICATIONS AND AUTHORIZATION TO PROCEED HAS BEEN RECEIVED FROM THE INSPECTOR. 7. PAVEMENT SUBGRADE SHALL NOT BE ALLOWED TO RETAIN WATER. WET MATERIAL SHALL BE REMOVED TO DRY, SOUND MATERIAL AND APPROPRIATE DENSITY ACHIEVED PRIOR TO PAVING OPERATIONS.

8. PROOF-ROLL SUBGRADE: THE SUBGRADE SHALL BE PROOF-ROLLED WITH HEAVY PNEUMATIC EQUIPMENT. ANY SOFT OR PUMPING AREAS SHALL BE EXCAVATED TO FIRM SUBGRADE AND BACKFILLED AND RE-COMPACTED IN CONFORMANCE WITH THE GEOTECHNICAL REPORT.

9. SAND CUSHION PROHIBITED: THE USE OF "LEVEL UP" SAND CUSHION UNDER PAVEMENT, INCLUDING SIDEWALKS, IS STRICTLY PROHIBITED. 10. PAVEMENT REMOVAL: BREAKOUTS FOR REMOVAL OF EXISTING PAVEMENT AND CURBS SHALL BE MADE BY A FULL-DEPTH SAWCUT WHEN ADJACENT TO

PROPOSED PAVING AND/OR CURBS. 11. TESTING: SAMPLES FOR STRENGTH TESTS OF THE CONCRETE PAVEMENT WILL BE TAKEN BY THE GEOTECHNICAL ENGINEER TO VERIFY DESIGN STRENGTH. PAVEMENT AREAS FOUND TO BE DEFICIENT IN STRENGTH SHALL BE REMOVED AND REPLACED SOLELY AT THE EXPENSE OF THE CONTRACTOR. THE GEOTECHNICAL ENGINEER SHALL ALSO RANDOMLY CORE THE PAVEMENT TO VERIFY THE THICKNESS OF CONCRETE. ANY AREA FOUND TO BE DEFICIENT IN THICKNESS SHALL BE REMOVED

AND REPLACED SOLELY AT THE EXPENSE OF THE CONTRACTOR 12. SIDEWALKS AND RAMPS: CONSTRUCTION OF SIDEWALKS, WHEELCHAIR RAMPS AND ACCESSIBLE ROUTES SHALL BE IN ACCORDANCE WITH THE AMERICANS DISABILITY

13. SLOPÈD SIDEWALKS ADJACENT TO BUILDING SHALL NOT HAVE SLOPES GREATER THAN 5% OR 1:20 ALONG THE TRAVEL PATH AND A MAX 2% CROSS FALL. NO RAMPS SHALL BE USED ADJACENT TO BUILDING.


14. PAVEMENT MARKINGS: CONCRETE FOR HANDICAP RAMPS SHALL BE COLOR CONDITIONED "TILE RED" WITH A COLORING ADD MIXTURE SPECIFICALLY FOR USE IN CONCRETE. CONTRACTOR SHALL USE CHROMIX ADD MIXTURES OR EQUIVALENT. AS MANUFACTURED BY L.M. SCHOFIELD STAIN COMPANY AT ALL SIDEWALKS AS

15. PAVEMENT MARKINGS SHALL BE PROVIDED IN ACCORDANCE WITH THE 2009 SOUTH CAROLINA "UNIFORM TRAFFIC MANUAL FOR PAVEMENT MARKINGS". FIRE LANES SHALL BE STRIPED IN ACCORDANCE WITH THE GOVERNING AUTHORITIES' REQUIREMENTS. REFER TO THE DIMENSION CONTROL PLAN FOR EXACT PLACEMENT. ALL HANDICAP SYMBOLS, SIGNAGE AND PAVEMENT MARKINGS SHALL COMPLY WITH ADA STANDARDS. ALL PARKING SPACES SHOWN ON PROPOSED CONSTRUCTION

SHALL BE MARKED WITH 4-INCH WIDE WHITE PAINTED PAVEMENT STRIPING. 16. IRRIGATION CONDUIT: ALL IRRIGATION CONDUIT AND SLEEVES SHALL BE TWO 4-INCH SCHEDULE 40 PVC, INSTALLED WITH A MINIMUM OF 24-INCHES OF COVER. REFERENCE THE PAVING PLAN AND/OR LANDSCAPE PLANS FOR NUMBER OF CONDUITS, SIZE AND LOCATIONS OF PROPOSED IRRIGATION CONDUITS AND SLEEVES.

17. PAVEMENT WARRANTY: CONTRACTOR WILL PROVIDE A 2-YEAR UNCONDITIONAL MAINTENANCE FREE WARRANTY ON ALL PAVEMENT SURFACES.

18. PAVEMENT WITHIN SCDOT RIGHT-OF-WAY: ALL PAVEMENT CONSTRUCTION WITHIN SCDOT RIGHT-OF-WAY SHALL BE IN ACCORDANCE WITH THE LATEST EDITION OF SCDOT STANDARDS AND SPECIFICATIONS. THE ABOVE NOTES PERTAIN TO ALL PAVEMENT LOCATED WITHIN THE PROPERTY BOUNDARY AND SHALL NOT PERTAIN TO CONSTRUCTION OF PAVEMENT WITH IN SCDOT RIGHT-OF-WAY.

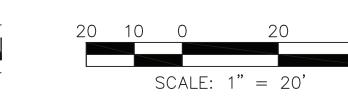



LEGEND

CONCRETE PAVEMENT SIDEWALK CONCRETE

---- PAVEMENT JOINT LINES

- THE CONTRACTOR SHALL REMOVE AND DISPOSE OF ALL EXISTING IMPROVEMENTS AND TREES AND OTHER DEBRIS WITHIN THE LIMITS OF THE WORK FROM THE SITE. ON SITE BURIAL OF TREES AND OTHER DEBRIS WILL NOT BE ALLOWED. THERE ARE NO KNOWN INERT BURY PITS ON THE SITE AND NONE WILL BE ALLOWED DURING THE CONSTRUCTION OF THE PROJECT.
- 2. ALL WORK SHALL COMPLY WITH ALL GOVERNING JURISDICTIONS, STATE OF NEW MEXICO, AND FEDERAL CODES AND ALL NECESSARY LICENSES AND PERMITS SHALL BE OBTAINED BY THE CONTRACTOR AT HIS EXPENSE UNLESS PREVIOUSLY OBTAINED BY THE OWNER.
- 3. ALL WORK SHALL BE PERFORMED IN A FINISHED AND WORKMANLIKE MANNER TO THE ENTIRE SATISFACTION OF THE OWNER, AND IN ACCORDANCE WITH THE BEST RECOGNIZED TRADE PRACTICES.
- 4. ALL MATERIALS SHALL BE NEW UNLESS USED OR SALVAGED MATERIALS ARE AUTHORIZED BY THE OWNER PRIOR TO USE.
- 5. ALL WORK PERFORMED ON CITY, COUNTY, AND/OR STATE OR FEDERAL RIGHT-OF-WAY SHALL BE IN STRICT CONFORMANCE WITH APPLICABLE STANDARDS AND SPECIFICATIONS OF THE APPROPRIATE GOVERNING AGENCIES.
- 6. BASE COURSE MATERIALS, EQUIPMENT, METHODS OF CONSTRUCTION AND WORKMANSHIP SHALL CONFORM TO "STATE OF NEW MEXICO TRANSPORTATION STANDARD SPECIFICATIONS", CURRENT EDITION.
- 7. ALL BUILDING DIMENSIONS SHALL BE CHECKED AND COORDINATED WITH THE ARCHITECTURAL PLANS PRIOR TO COMMENCEMENT OF CONSTRUCTION.
- 8. SEE PAVEMENT DETAILS THIS SHEET.
- 9. ALL DISTURBED AREAS WITHIN SIDEWALK/ CURB AND GUTTER/ ROAD PAVEMENT SHALL BE RESTORED TO ITS ORIGINAL OR BETTER CONDITIONS.
- 10. ALL DIMENSION ARE TO THE FACE OF CURB, UNLESS OTHERWISE NOTED.
- 11. THE PROPOSED DEVELOPMENT SHALL NOT IMPACT GROUND AND SURFACE WATER FLOWS ADJACENT TO
- 12. THE PROPOSED DEVELOPMENT SHALL NOT IMPACT
- ANY FLOODWAYS ADJACENT TO THE SITE. 13. BASE ON THE LATEST NEW MEXICO BUILDING CODE THIS SITE IS LOCATED IN ZONE "A" WITH ZERO SEISMIC PROBABILITY.
- 14. ALL SIDEWALKS SHALL HAVE A WIDTH OF 5 FEET. UNLESS OTHERWISE NOTED.
- 15. ALL RADII SHALL BE 3 FEET, UNLESS OTHERWISE NOTED.

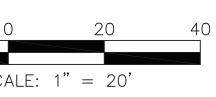


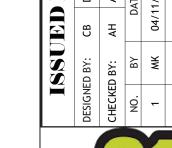





ATEF A. HANNA, PE #27436

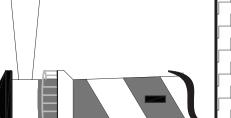

TAKE 5 CAR WASH


NEW MEXICO SNOW VISTA


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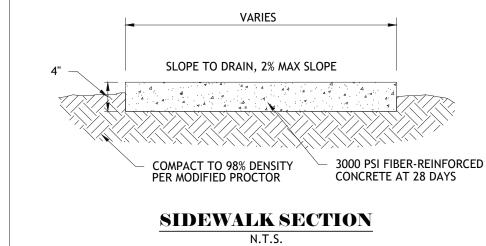
PAVEMENT PLAN

SHEET NUMBER:

C - 7.0



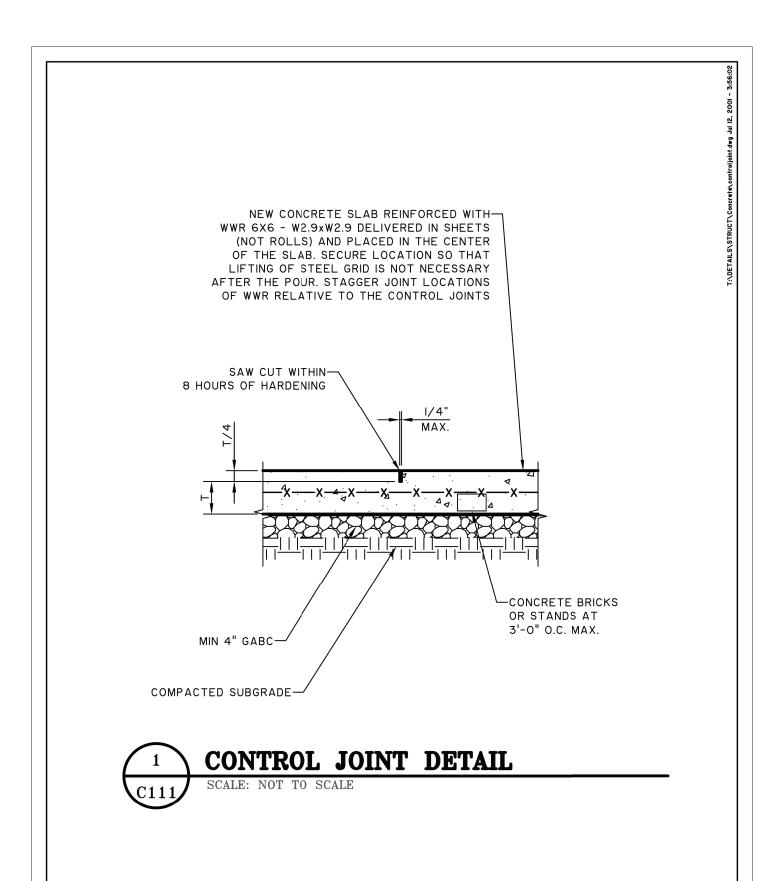

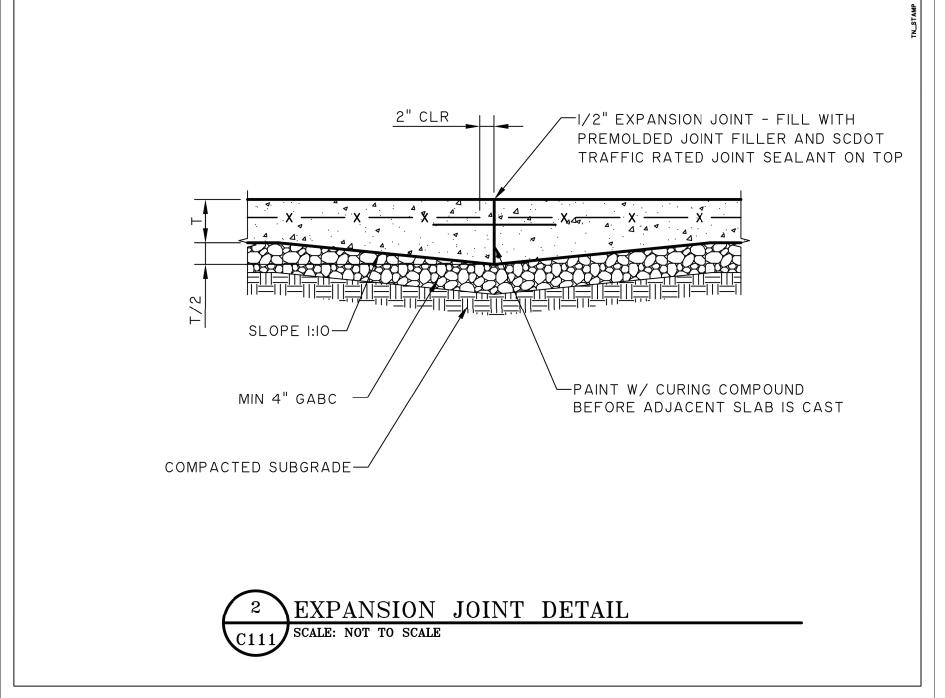

DESIGNED BY: CB DRAWN BY: CB ISSUE DATE: 04/207
CHECKED BY: AH APPROVED BY: AH JOB NO.: 21507
NO. BY DATE REVISION DESCRIPTION
1 MK 04/11/2023 CITY COMMENTS





ATEF A. HANNA, PE #27436

CIVIL ENGINEERING
CIVIL ENGINEERING
LAND DEVELOPMENT ENGINEERS
8345 GUNN HIGHWAY
TAMPA, FL 33626

TAKE 5 CAR WASH

OF NEW MEXICO SNOW VISTA


98TH STREET ALBUQUERQUE, NM

HEET NAME:

PAVEMENT PLAN 7

SHEET NUMBER:

C - 7.1

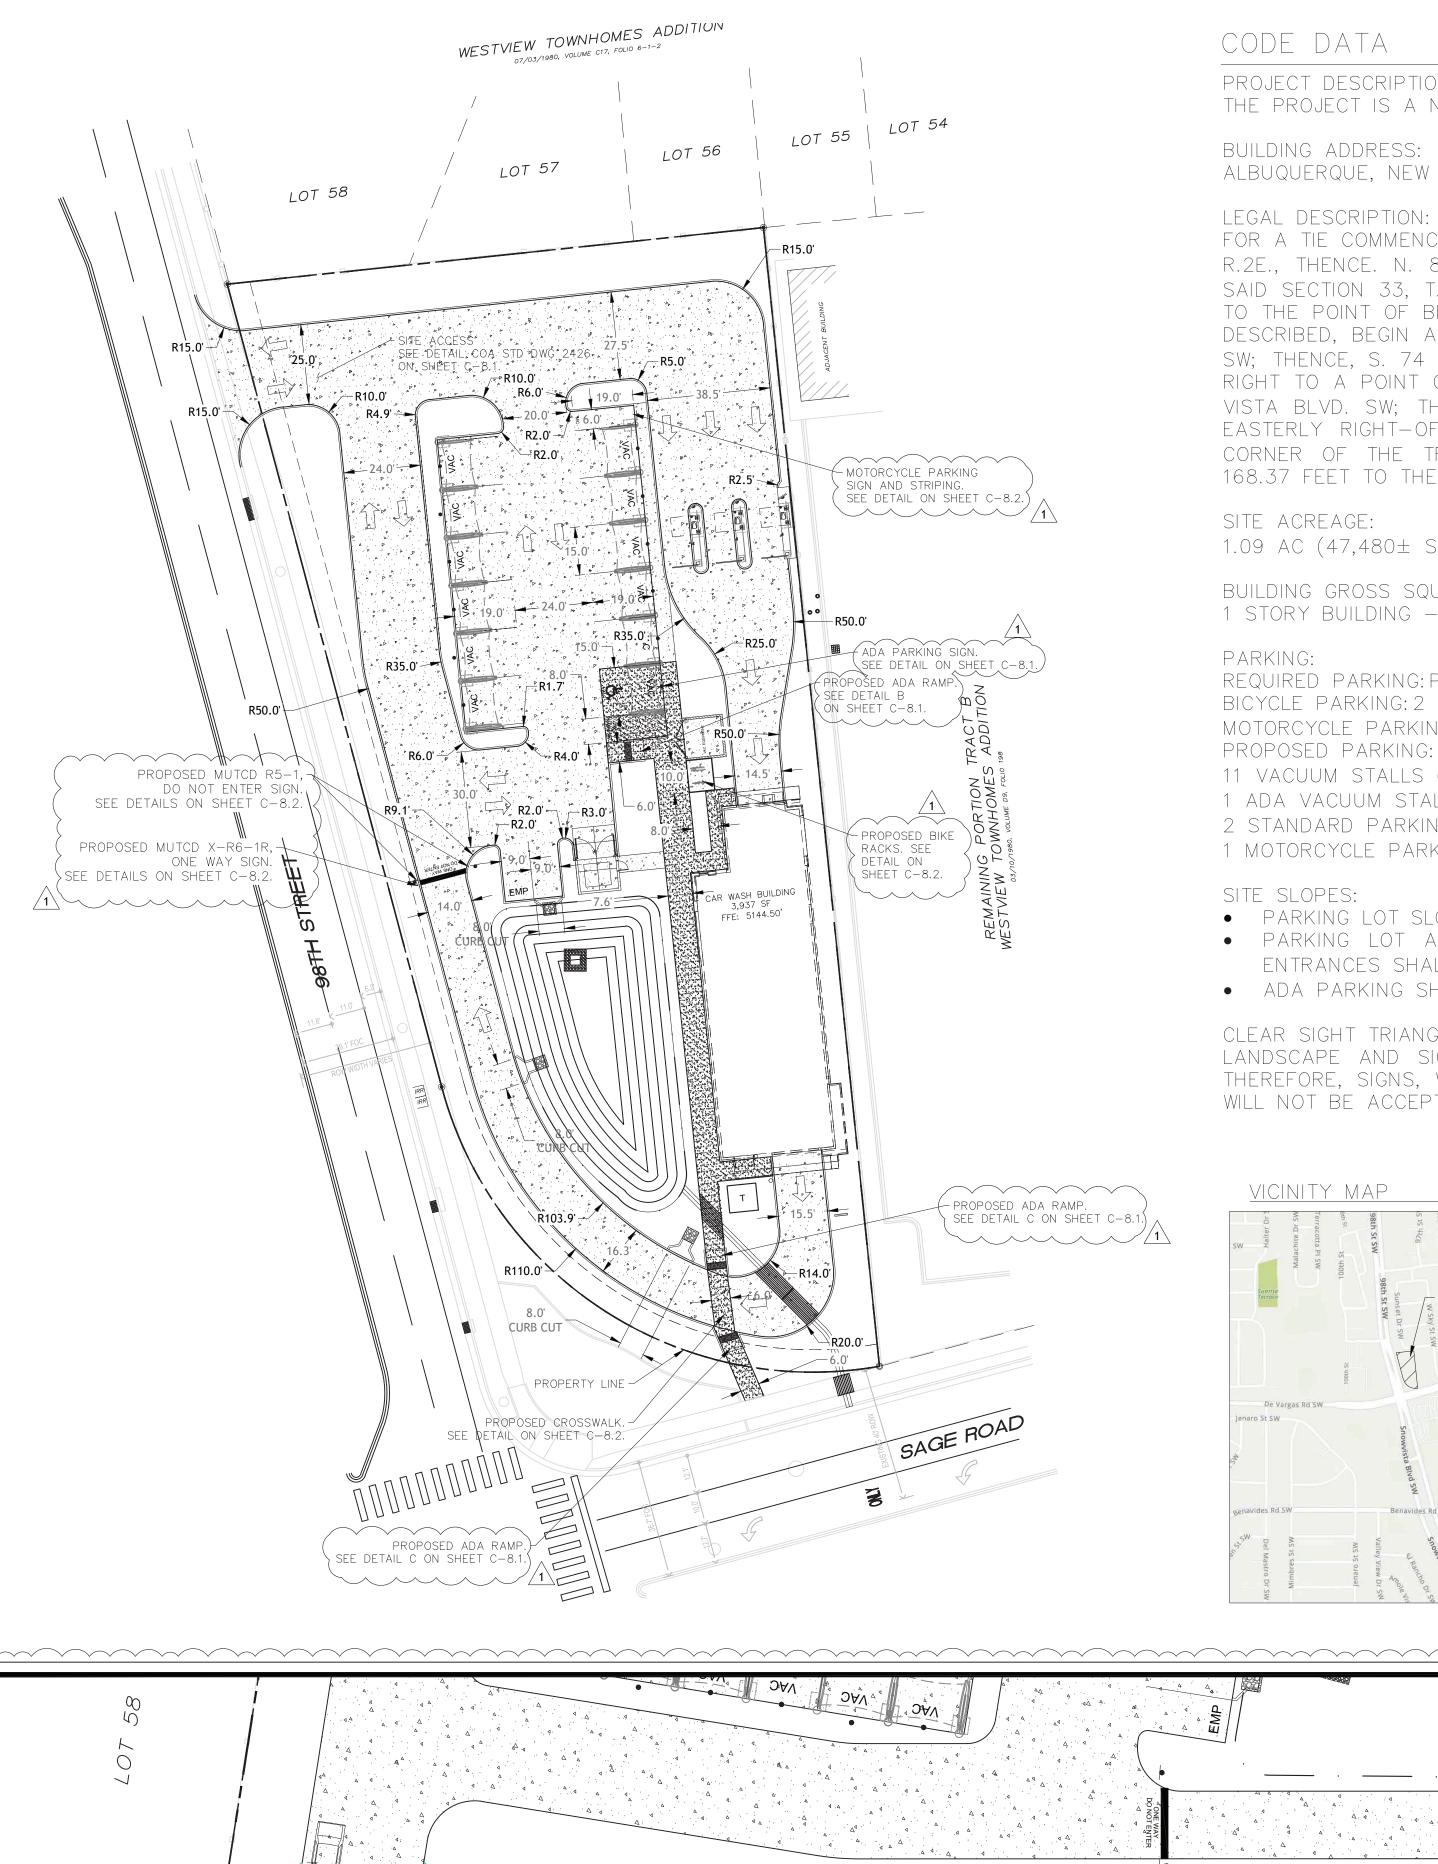

CODE DATA

PROJECT DESCRIPTION: THE PROJECT IS A NEW 1-STORY CAR WASH

BUILDING ADDRESS:

ALBUQUERQUE, NEW MEXICO 87121

LEGAL DESCRIPTION:

FOR A TIE COMMENCE AT THE NORTHWEST CORNER OF SAID SECTION 33. T.10N., R.2E., THENCE. N. 89 DEG. 27'22" E., 1392.96 FEET ALONG THE NORTH LINE OF SAID SECTION 33, T.10.N., R.2E., TO A POINT; THENCE. S. 06'37" E., 581.12 FEET TO THE POINT OF BEGINNING AND THE NORTHEAST CORNER OF THE TRACT HEREIN DESCRIBED, BEGIN A POINT ON THE NORTHERLY RIGHT-OF-WAY LINE OF SAGE RD. SW; THENCE, S. 74 DEG. 47'25"W., 84.63 FEET TO THE POINT OF A CURVE TO THE RIGHT TO A POINT OF TANGENT ON THE EASTERLY RIGHT-OF-WAY LINE OF SNOW VISTA BLVD. SW; THENCE, N. 15 DEG. 13' 00" W., 354.87 FEET ALONG THE NEW EASTERLY RIGHT-OF-WAY LINE OF SNOW VISTA BLVD, SW TO THE NORTHWEST CORNER OF THE TRACT HEREIN DESCRIBED; THENCE, N. 83 DEG. 46' 01" E., 168.37 FEET TO THE POINT OF BEGINNING.

SITE ACREAGE:

1.09 AC (47,480± SQ. FT.)

BUILDING GROSS SQUARE FOOTAGE: 1 STORY BUILDING - 3,937 GROSS SF

REQUIRED PARKING: PER JURISDICTIONAL REQUIRMENTS

BICYCLE PARKING: 2 SPACES

MOTORCYCLE PARKING (5X18)

11 VACUUM STALLS (15X19)

1 ADA VACUUM STALL (15X19)

2 STANDARD PARKING (9X18)

1 MOTORCYCLE PARKING (5X18)

SITE SLOPES:

• PARKING LOT SLOPE SHALL BE BETWEEN 1% AND 5%


• PARKING LOT AREAS ADJACENT TO MAJOR CIRCULATION AISLES OR MAJOR ENTRANCES SHALL BE BETWEEN 1% (MIN.) AND 5% (MAX.)

• ADA PARKING SHALL BE BETWEEN 1% (MIN.) & 2% (MAX.)


CLEAR SIGHT TRIANGLE:

LANDSCAPE AND SIGNAGE WILL NOT INTERFERE WITH CLEAR SITE REQUIRMENTS. THEREFORE, SIGNS, WALLS, TREES, AND SHRUBBERY BETWEEN 3 AND 8 FEET TALL WILL NOT BE ACCEPTABLE WITHIN THE CLEAR SIGHT TRIANGLE.

VICINITY MAP

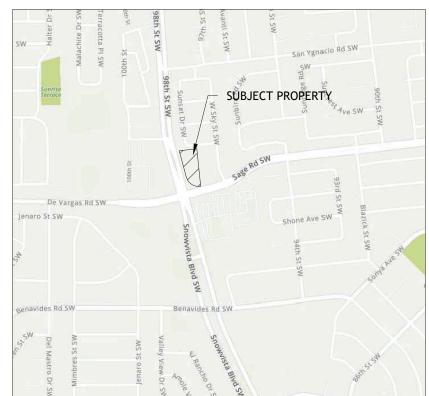

ZONING MAP

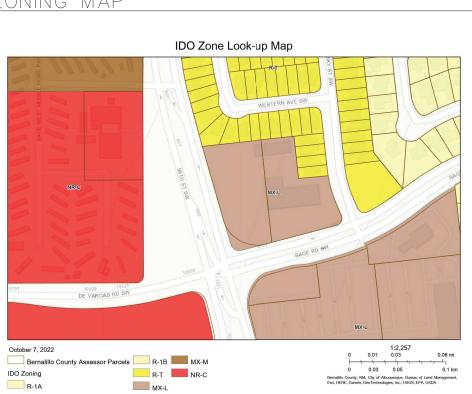

LEGEND


ADA ACCESSIBLE PATH
2% MAX SLOPES IN ALL DIRECTIONS


CONCRETE PAVEMENT. SEE DETAIL ON SHEET C-8.1.

SIDEWALK CONCRETE SEE DETAIL ON SHEET C-8.1.

NOTES

1. ALL BROKEN OR CRACKED SIDEWALK MUST BE REPLACED WITH SIDEWALK AND CURB &

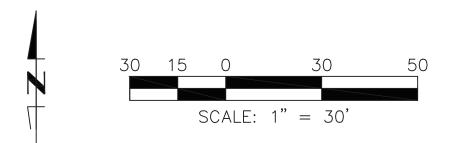

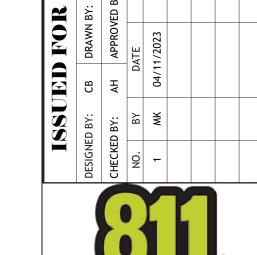

Know what's **below. Call** before you dig.



ATEF A. HANNA, PE #27436

TAKE 5 CAR WASH


NEW MEXICO SNOW VISTA


98TH STREET ALBUQUERQUE,


CIRCULATION

SHEET NUMBER:

C - 8.0

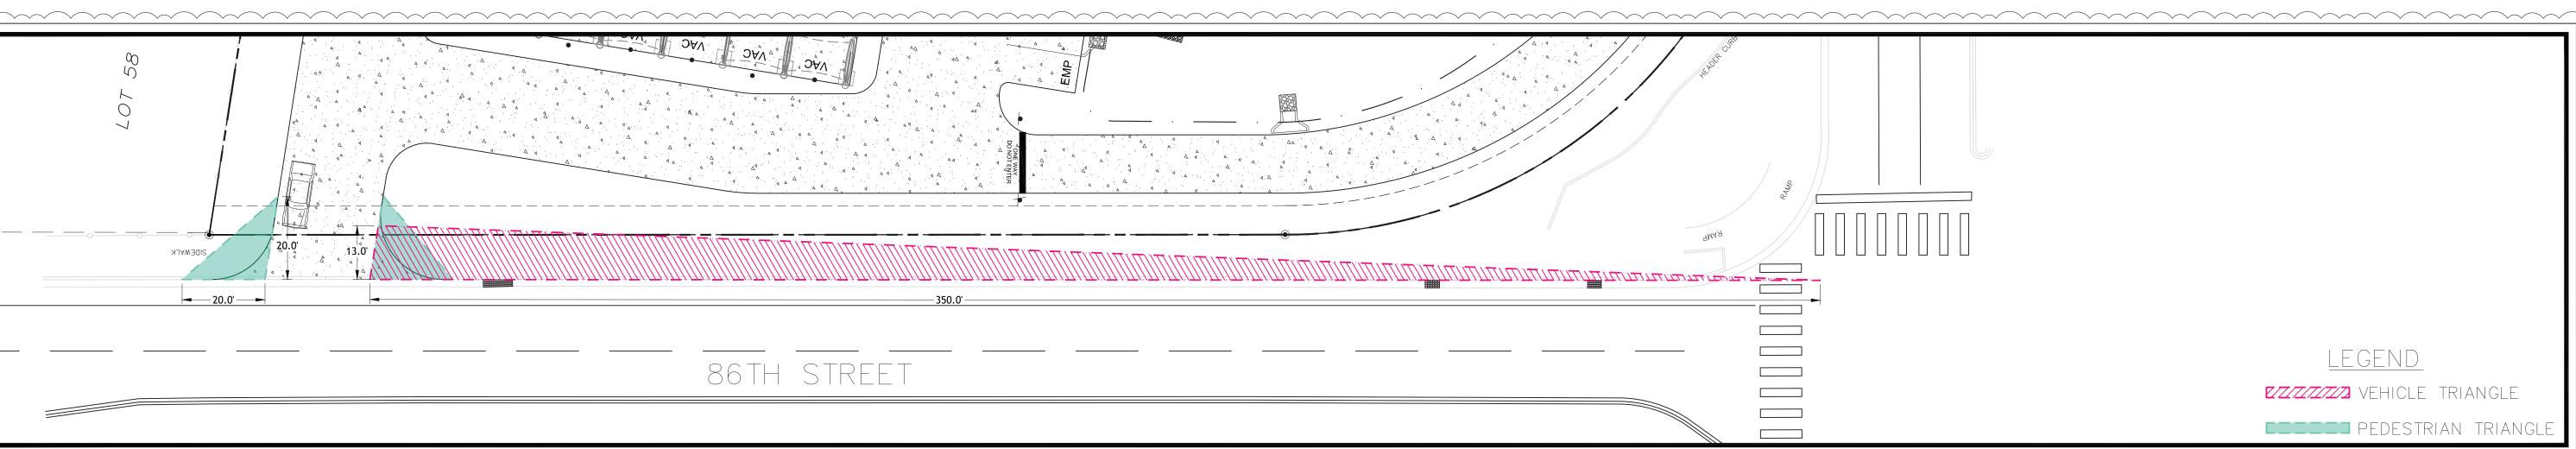

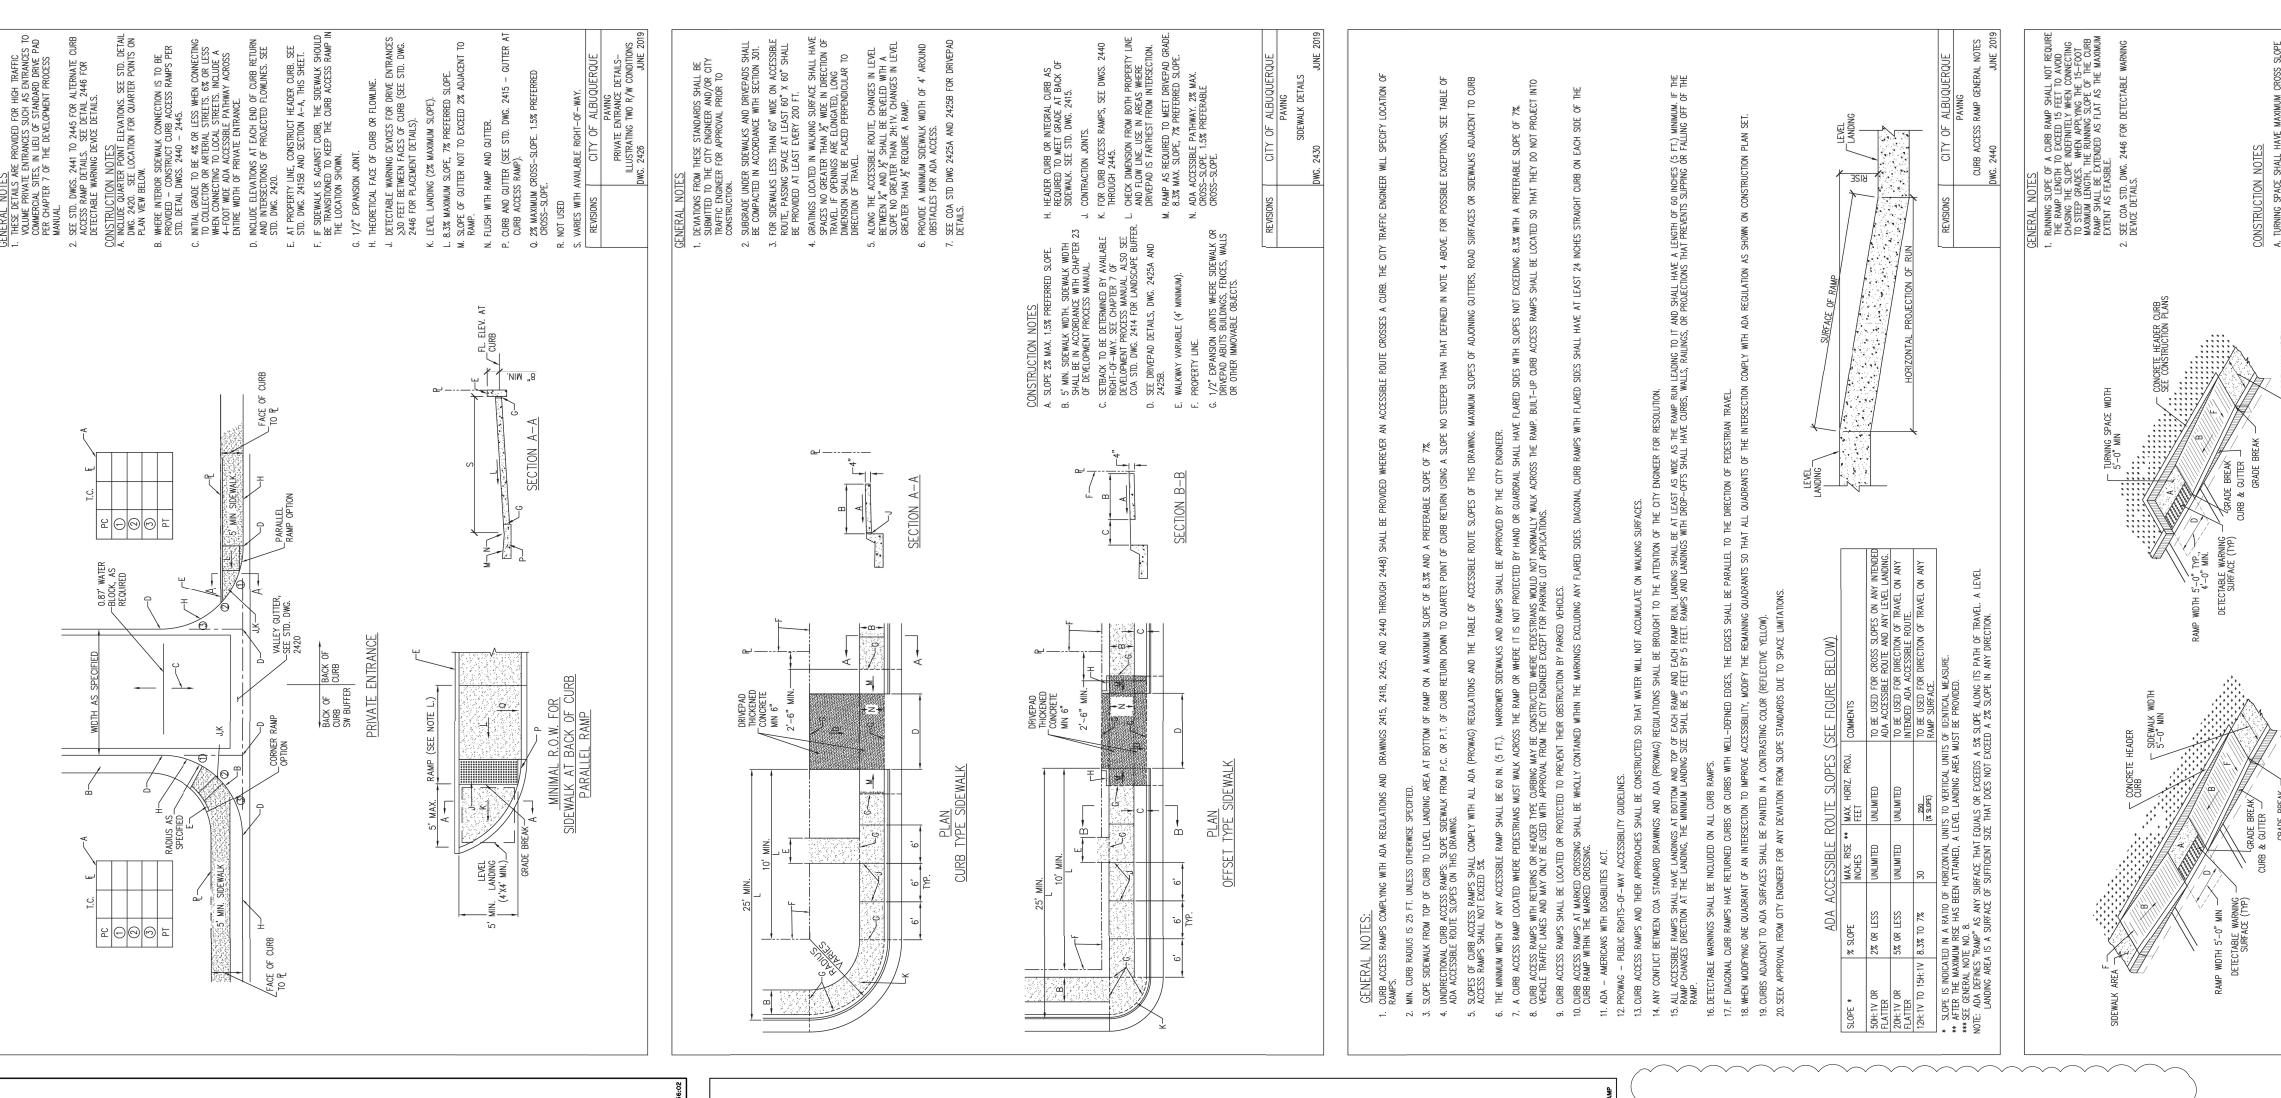

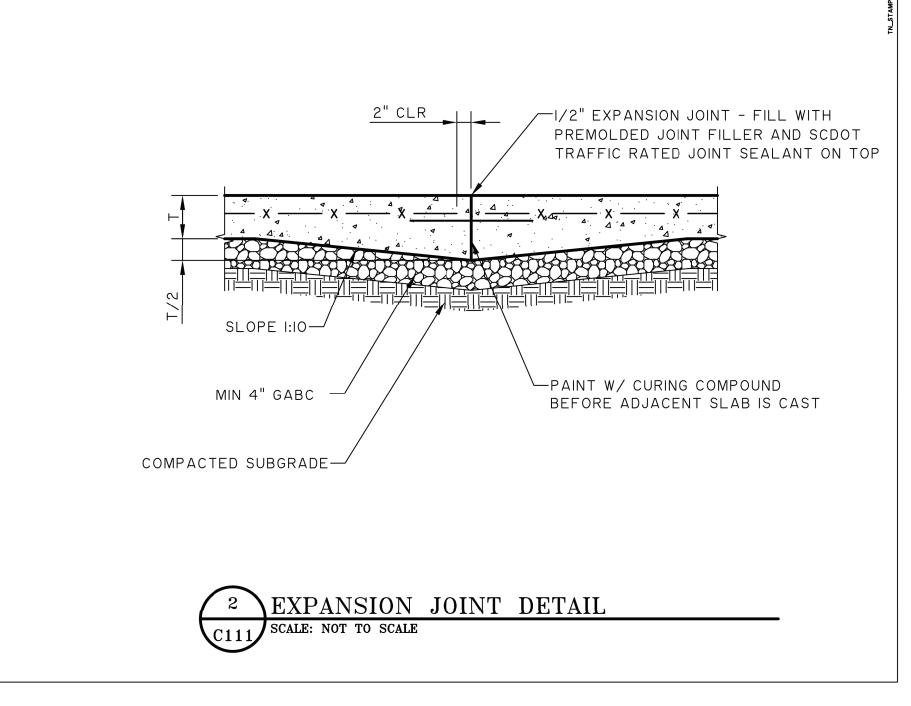

NEW CONCRETE SLAB REINFORCED WITH

CONTROL JOINT DETAIL

-CONCRETE BRICKS

OR STANDS AT

3'-0" O.C. MAX.

WWR 6X6 - W2.9xW2.9 DELIVERED IN SHEETS

(NOT ROLLS) AND PLACED IN THE CENTER

OF THE SLAB. SECURE LOCATION SO THAT

LIFTING OF STEEL GRID IS NOT NECESSARY

AFTER THE POUR. STAGGER JOINT LOCATIONS


OF WWR RELATIVE TO THE CONTROL JOINTS


SAW CUT WITHIN-

8 HOURS OF HARDENING

MIN 4" GABC-

COMPACTED SUBGRADE—

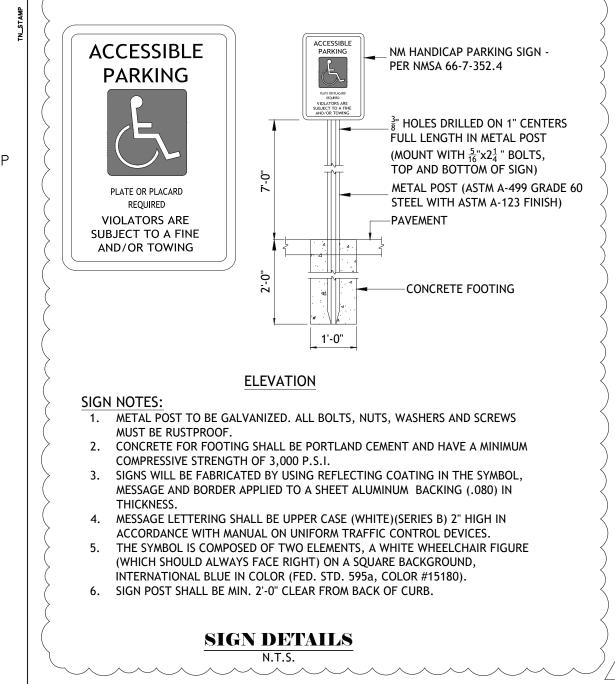


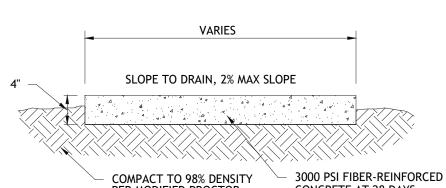


CONCRETE AT 28 DAYS

SIDEWALK SECTION



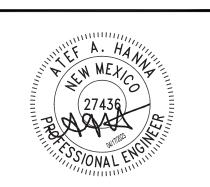

ATEF A. HANNA, PE #27436 BEACON IVIL ENGINEERING

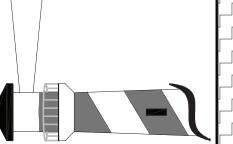

TAKE 5 CAR WASH

NEW MEXICO SNOW VISTA

98TH STREET

ALBUQUERQUE,

SHEET NAME: CIRCULATION PLAN **DETAILS**

SHEET NUMBER: C-8.1




SAFETY WARNINGS & EQUIPMENT INSPECTION

- Owners and installers please note these safety warnings and make use of this checklist on a regular basis.
- Follow installation instructions when erecting equipment.
- Ground surfaces around equipment should be restored as needed. Concrete footings should never be exposed. Surface depth should comply with ASTM and CPSC specifications.
- Check for and repair damage caused by wear or vandalism, a major factor in injury causing situations.
- All protruding bolts should be covered or cut off and finished smooth. Sharp edges on pipes should be capped or removed. Check for bent, broken, or severely worn pipe, and replace.
- All equipment should be free of rust and repainted whenever necessary to deter rusting.
- We provide our customers with layout sheets and installation instructions. Please keep on file the specifications sheet that contains
- Never add components not intended for use with this product.
- Regular maintenance is necessary in this and all park and recreational equipment to insure the safety of the user.
- Note: Proper maintenance of equipment requires regular tightening of all bolts, nuts, and setscrews.
- Note: Regular checking of all parts, castings, etc. should be made. If a part is broken or worn, it should be replaced immediately.
- Check to be sure all fittings are tight and that bars and pipes do not move.
- Replace all worn S-hooks. S-hooks must be completely closed. Failure to close S-hooks can result in serious injury to the user. NEVER reuse S-hooks.
- Test for free movement of swing hanger and other moving attached parts.
- Check for worn chains and replace them.
- A soft resilient surface should be placed under all swings extending at least twice the height of the top rail both front and back.


8/14/2017

OVERALL DIMENSIONS

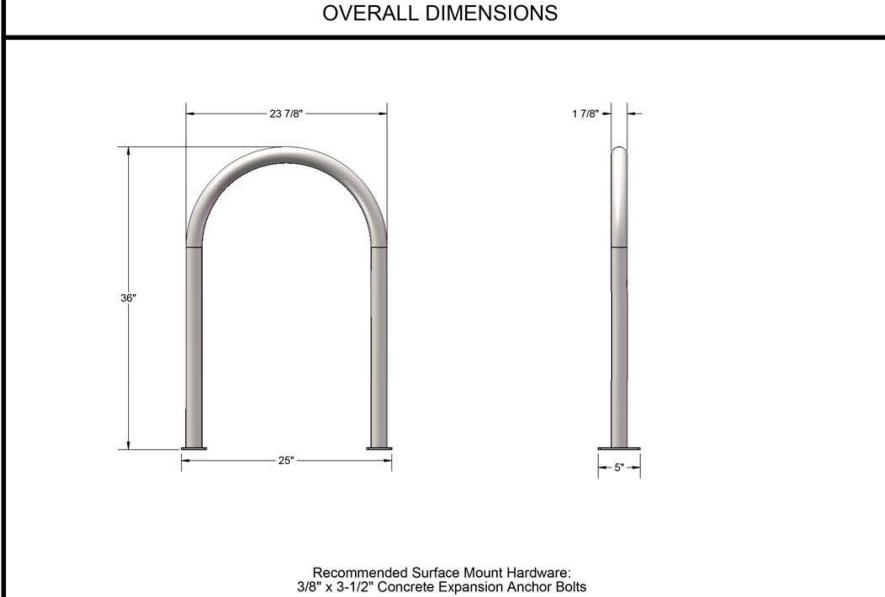

6" WHITE REFELCTIVE STRIPE -


4" WHITE REFELECTIVE STRIPE @ 2' O.C.

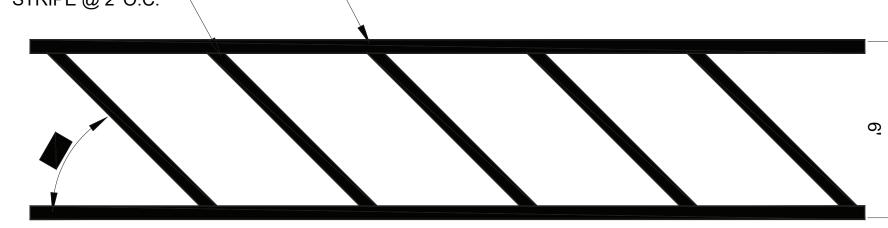



1. CROSSWALK ALONG AN ACCESSIBLE ROUTE SHALL MAINTAIN A SLOPE OF 2% MAX. IN ALL

TYPICAL CROSSWALK
N.T.S.

FIGURE 7.4.115 Bicycle Parking Stall Layout Options

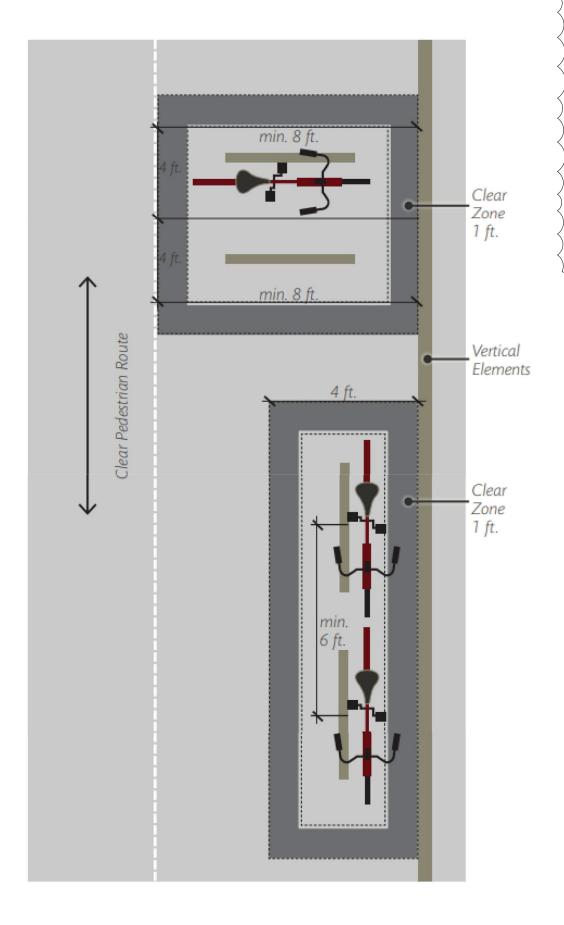

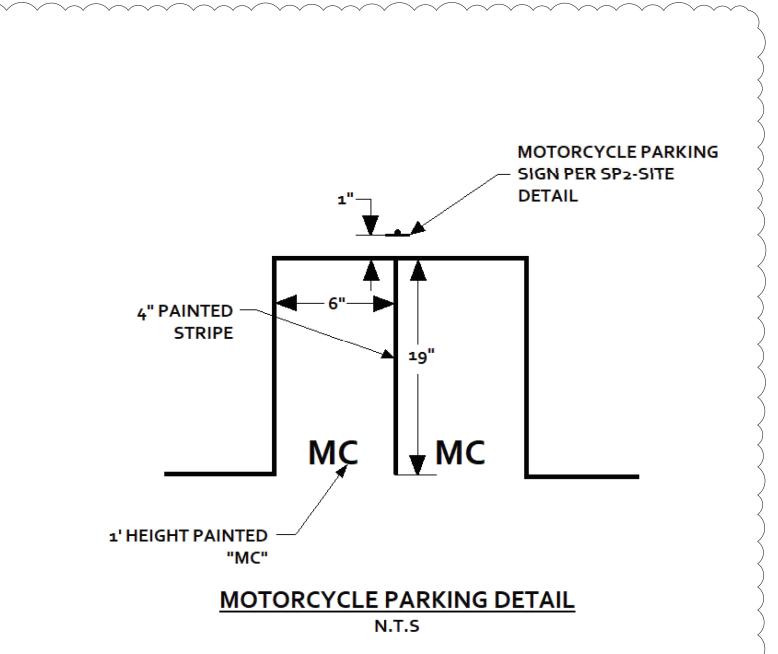

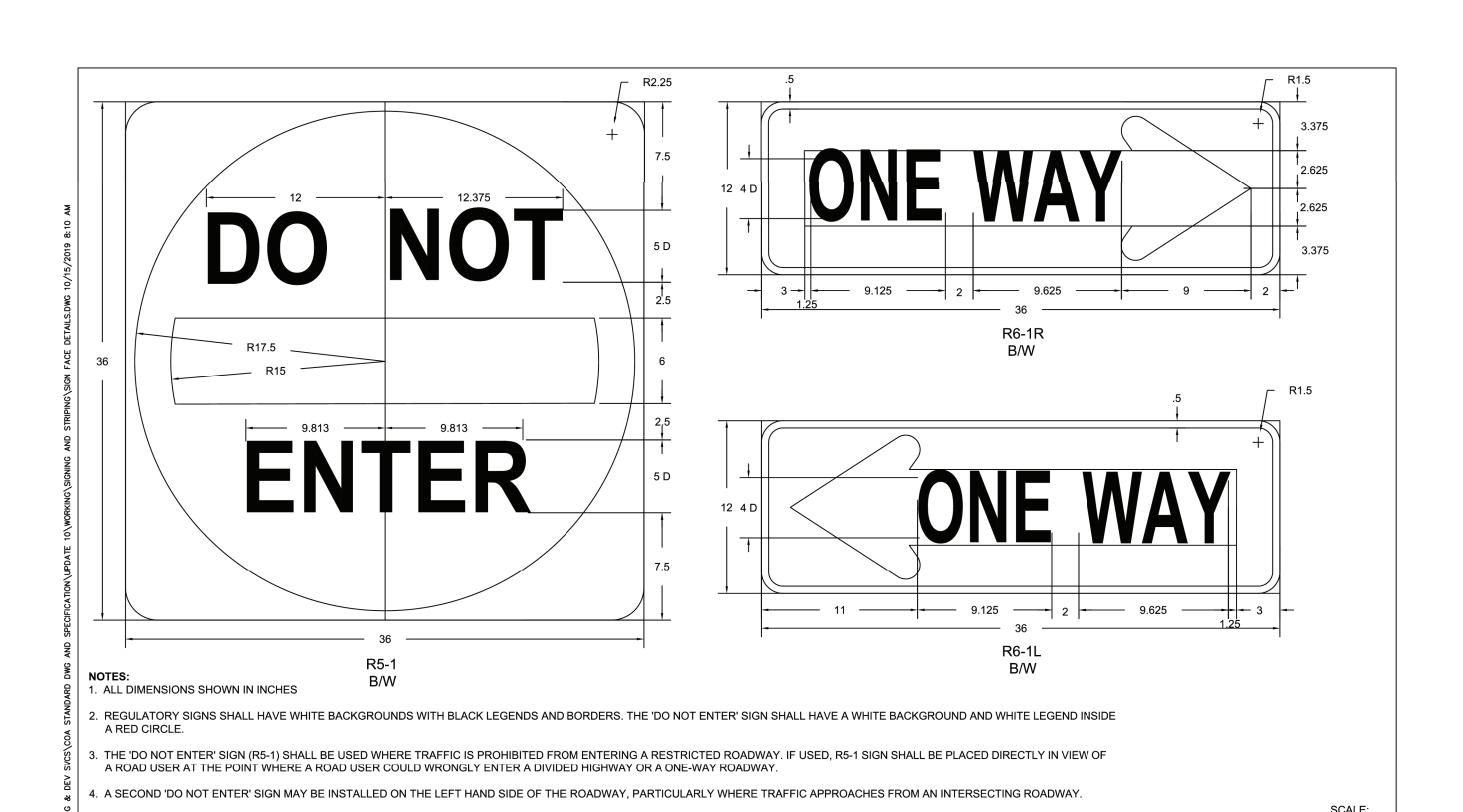

6. IF THE R6-1 SIGN IS USED AT UN-SIGNALIZED INTERSECTIONS WITH ONE-WAY STREETS, THE 'ONE WAY' SIGN SHALL BE PLACES ON THE NEAR RIGHT AND THE FAR LEFT CORNERS OF THE

7. IF USED AT SIGNALIZED INTERSECTIONS WITH ONE-WAY STREETS, THE 'ONE WAY' SIGNS SHALL BE PLACED NEAR THE APPROPRIATE SIGNAL FACES, ON THE POLES HOLDING THE TRAFFIC SIGNALS, ON THE MAST ARM OR SPAN WIRE HOLDING THE SIGNALS, OR AT THE LOCATIONS SPECIFIED FOR UN-SIGNALIZED INTERSECTIONS.



Call before you dig.



ATEF A. HANNA, PE #27436

REVISIONS CITY OF ALBUQUERQUE

SIGN FACE DETAILS

REGULATORY SIGN

DETAILS

DWG. 2600-603 NOVEMBER 2019


TAKE 5 CAR WASH


NEW MEXICO SNOW VISTA

98TH STREET ALBUQUERQUE,

CIRCULATION **PLAN DETAILS**

SHEET NUMBER: C-8.2

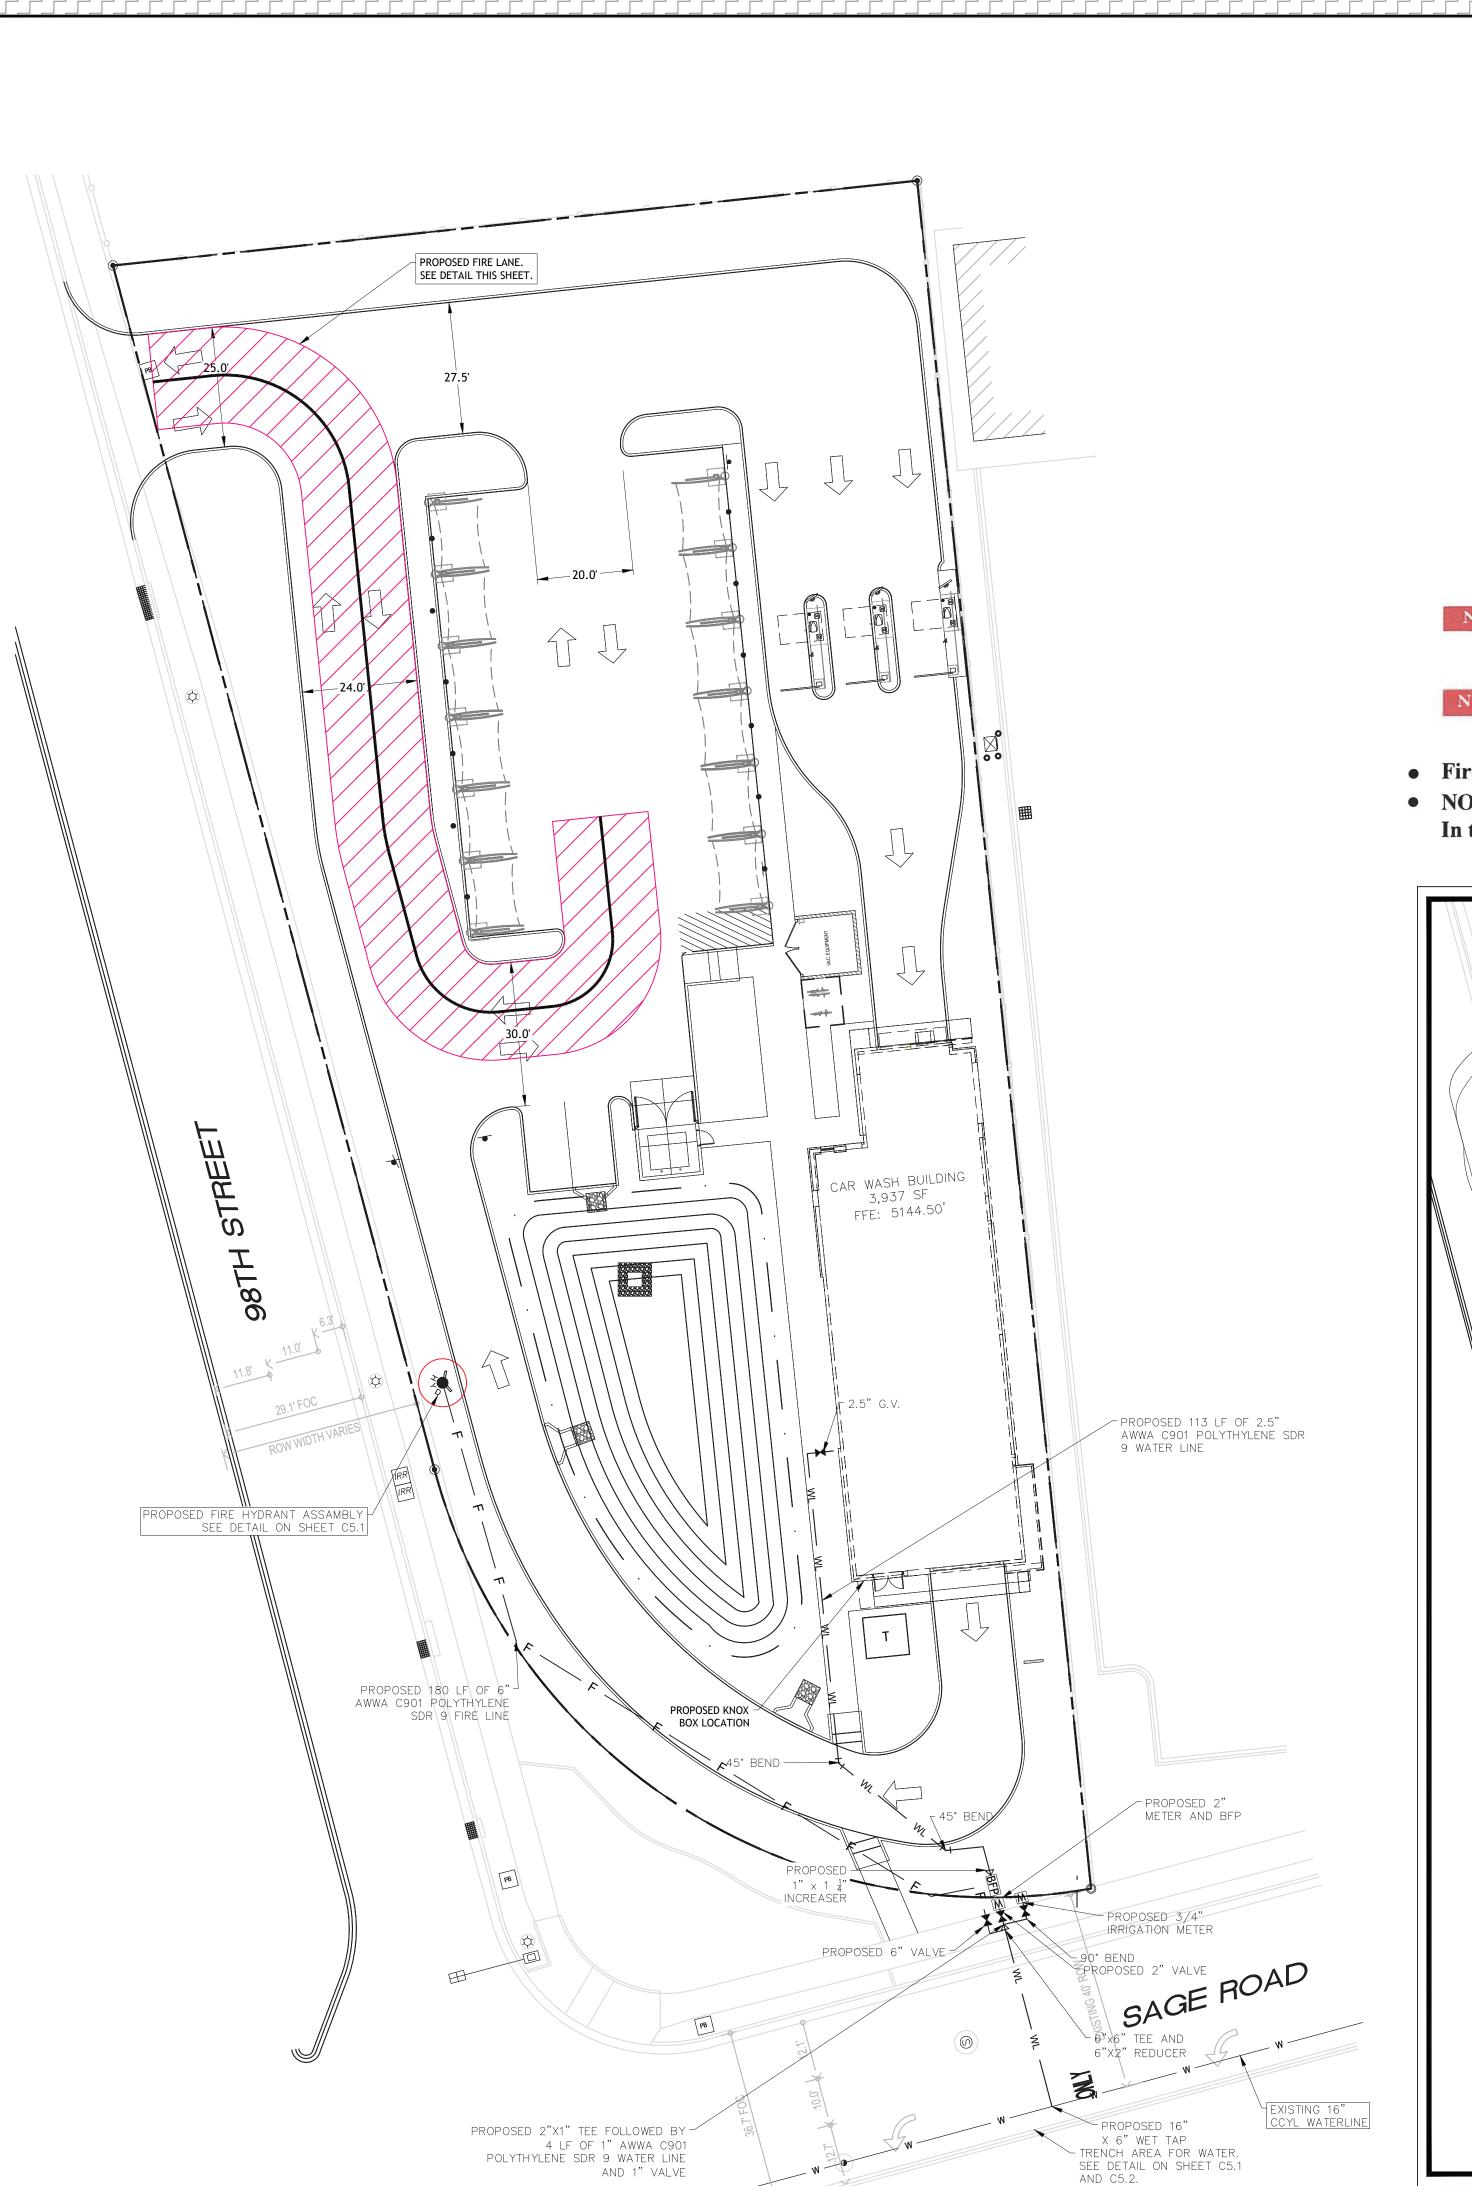

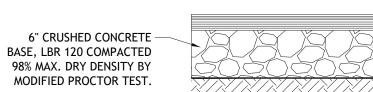

3" ASPHALTIC SURFACE COURSE,

TYPE SP WITH BINDER


AND COMPACTED TO AT LEAST 98% OF MODIFIED PROCTOR MAX. DRY DENSITY (ASTM D1557) VALUE

PROFILE VIEW


- ASPHALT NOTES 1. ALL ACCESS DRIVES AND PARKING STALLS SHALL BE ASPHALT. 2. THE ASPHALT SURFACE COURSE SHOULD CONFORM TO THE MOST RECENT
- EDITION OF THE NEW MEXICO DEPARTMENT OF TRANSPORTATION (NMDOT) STANDARD SPECIFICATION FOR ROAD AND BRIDGE CONSTRUCTION. ROAD AND BRIDGE CONSTRUCTION SPECIFICATIONS SUPPLEMENTAL SECTION 204. BASE COURSE SHALL BE COMPACTED TO 98% OF THE MODIFIED
- 4. ASPHALT SHOULD BE COMPACTED TO A MINIMUM OF 93% OF LABORATORY MAXIMUM DESIGN MIX DENSITY DETERMINED FROM SPECIFIC GRAVITY METHODS WITH IND. TEST TOLERANCE OF +2% AND -1.2% OF DESIGN Gmm. 5. PLASTIC CLAY SHALL NOT BE ALLOWED TO STABILIZE THE SUBGRADE.
 - ASPHALT PAVEMENT SECTION N.T.S.

6. CRUSHED CONCRETE SHALL BE SOURCED FROM APPROVED NMDOT SUPPLIER.


Fire Lane Striping Requirements

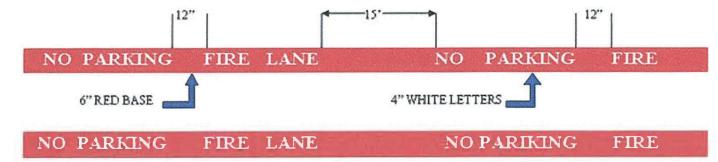

- Fire Lanes shall be a minimum of twenty (20) feet wide.
- NO PARKING FIRE LANE ~ To be painted entire length of fire lane. In twenty five (25) foot intervals between LANE and NO

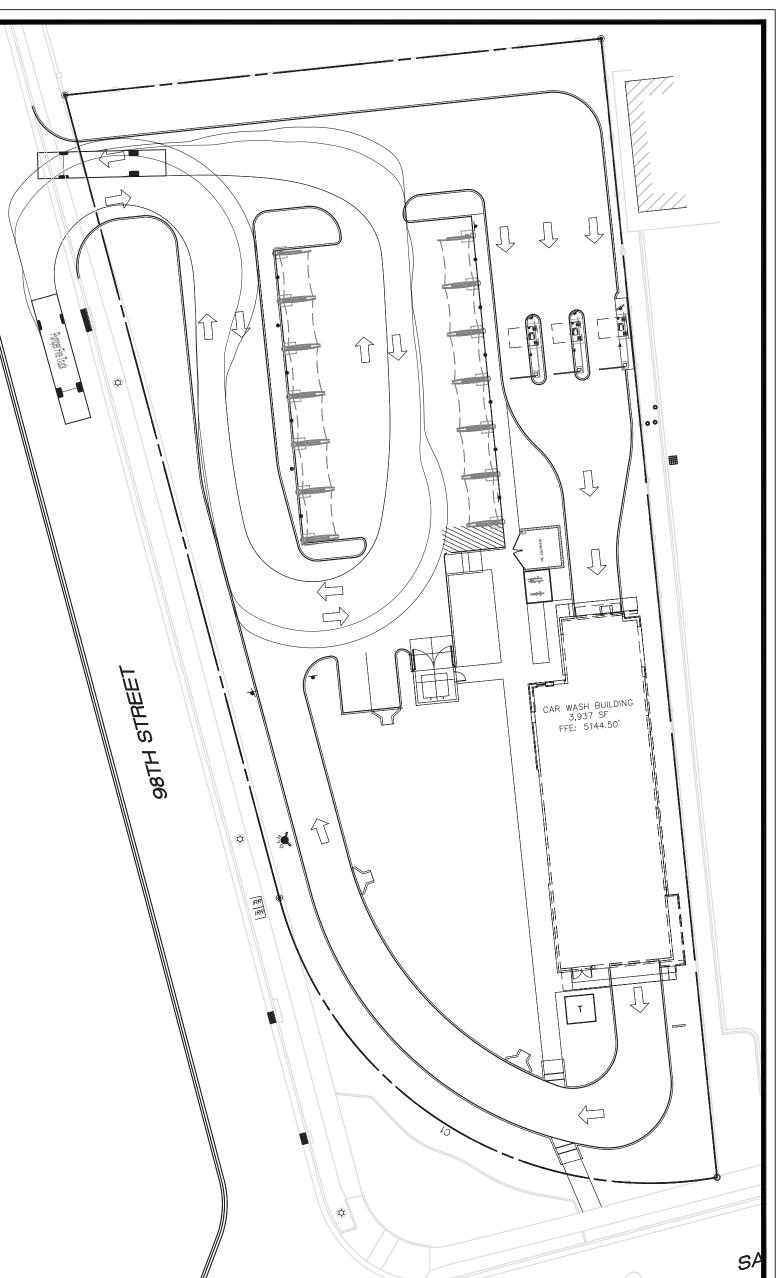

FIRE TRUCK EXHIBIT

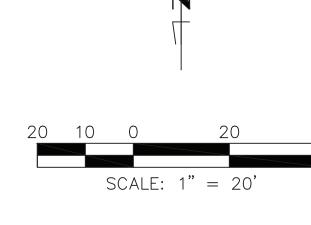



VICINITY MAP NOT TO SCALE

FIRE ONE LEGEND

PROPOSED 20' FIRE LANE ACCESS


EXISTING FIRE HYDRANT

PROPERTY LINE EXISTING CCYL WATER LINE

NOTE: LIGHTER TONE INDICATES EXISTING CONDITION


FIRE ONE NOTES

- 1. BUILDING AREA: 3,937 SF• BUILDING TYPE: VB NOT FIRE SPRINKLED
- STRUCTURE HEIGHT: 31'-0" • FIRE FLOW: 1,500 GPM FOR 2 HOURS PER IFC 2015 TABLE B105.1 (2)
- 2. HYDRANTS: • MIN. NUMBER OF HYDRANTS: 1
- MAX. HYDRANT SPACING: 500 FT • MAX. DISTANCE FROM STREET OR FRONTAGE TO FIRE HYDRANT: 250 FT 3. THE PARKING SURFACE SHALL BE CAPABLE OF SUPPORTING AN IMPOSED LOAD OF A FIRE
- APPARATUS WEIGHING 75,000 LBS. 4. THE MINIMUM DRIVE AISLE WIDTH WILL BE AS SHOWN.
- 5. BUILDING SHALL HAVE APPROVED ADDRESS NUMBERS OR BUILDING IDENTIFICATION PLACED IN A
- POSITION PLAINLY LEGIBLE AND VISIBLE FROM THE STREET. 6. ALL DRIVING SURFACES SHALL NOT EXCEED 10 PERCENT IN GRADE.
- 7. ALL FIRE HYDRANT SUPPLY LINES THAT BRANCH OFF OF THE WATER LINES SHALL BE 6" DIA. UNLESS OTHERWISE NOTED ON THE PLANS.
- 8. WORK SHALL BE IN ACCORDANCE WITH THE APPROVED CONSTRUCTION DOCUMENTS, AND ANY CHANGES MADE DURING CONSTRUCTION THAT ARE NOT IN COMPLIANCE WITH THE APPROVED CONSTRUCTION DOCUMENTS. APPROVED WET STAMPED SHOP DRAWING SHALL BE ONSITE FOR INSPECTIONS.

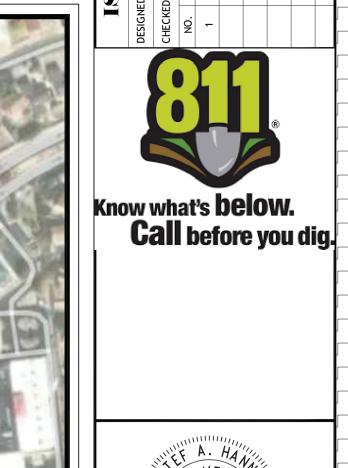



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TAKE 5 CAR WASH

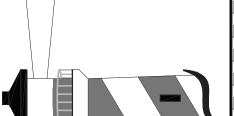NEW MEXICO SNOW VISTA

98TH STREET ALBUQUERQUE,

FIRE 1 PLAN

SHEET NUMBER:

CAUTION!! CONTRACTOR IS TO VERIFY PRESENCE AND EXACT LOCATION OF ALL UTILITIES