
CITY OF ALBUQUERQUE

Planning Department David Campbell, Director

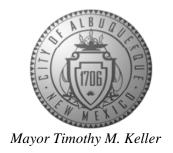

November 2, 2018

Shawn Biazar SBS Construction and Engineering, LLC 10209 Snowflake Ct. NW Albuquerque, NM, 87114

RE: **DKG Roofing Inc.**

7000 Huseman Place SW **Grading and Drainage Plan** Engineer's Stamp Date: 10/22/18 Hydrology File: M10D016J

Dear Mr. Biazar:

PO Box 1293 Based upon the information provided in your submittal received 10/25/2018, the Grading and

Drainage Plan is approved for Building Permit.

Albuquerque Please attach a copy of this approved plan in the construction sets for Building Permit processing

along with a copy of this letter. Prior to approval in support of Permanent Release of Occupancy

by Hydrology, Engineer Certification per the DPM checklist will be required.

NM 87103 Please provide Private Facility Drainage Covenant per Chapter 17 of the DPM prior to

Permanent Release of Occupancy for the first flush pond and retention pond. Please submit

these to the 4th floor of Plaza de Sol. A \$25 fee for each will be required.

If you have any questions, please contact me at 924-3995 or rbrissette@cabq.gov.

Sincerely,

www.cabq.gov

Renée C. Brissette, P.E. CFM Senior Engineer, Hydrology

Renée C. Brissette

Planning Department



City of Albuquerque

Planning Department

Development & Building Services Division

DRAINAGE AND TRANSPORTATION INFORMATION SHEET (REV 6/2018)

Project Title: DKG ROOFING INC.	Building Permit #:	Hydrology File #:
DRB#:	EPC#:	Work Order#:
Legal Description: LOT 12 COORS	S-ARENAL INDUSTRIAL PARK	
City Address:7000 HUSEMAN PLACE,		
Applicant: SBS CONSTRUCTION A	ND ENGINEEING, LLC	Contact: SHAWN BIAZAR
Address: 10209 SNOWFLAKE CT., N		
		E-mail: AECLLC@AOL.COM
Othor Contact		Contact
		Contact:
Address:		
Phone#:	Fax#:	E-mail:
TYPE OF DEVELOPMENT:	_ PLAT (# of lots) RESIDENC	CE DRB SITE X ADMIN SITE
IS THIS A RESUBMITTAL?	Yes X No	
DEPARTMENT TRANSPORTA	ATION X HYDROLOGY/DRA	AINAGE
Check all that Apply:	TYPE OF	APPROVAL/ACCEPTANCE SOUGHT:
11 3		DING PERMIT APPROVAL
TYPE OF SUBMITTAL:	CERT	ΓΙFICATE OF OCCUPANCY
ENGINEER/ARCHITECT CERTIF	TICATION	
PAD CERTIFICATION	PREL	LIMINARY PLAT APPROVAL
CONCEPTUAL G & D PLAN	SITE	PLAN FOR SUB'D APPROVAL
X GRADING PLAN	SITE	PLAN FOR BLDG. PERMIT APPROVAL
X DRAINAGE REPORT	FINA	AL PLAT APPROVAL
DRAINAGE MASTER PLAN		
FLOODPLAIN DEVELOPMENT P	ERMIT APPLIC SIA/	RELEASE OF FINANCIAL GUARANTEE
ELEVATION CERTIFICATE		NDATION PERMIT APPROVAL
CLOMR/LOMR		DING PERMIT APPROVAL
TRAFFIC CIRCULATION LAYOU	IT (TCL)	9 APPROVAL
TRAFFIC IMPACT STUDY (TIS)		ING PERMIT APPROVAL
STREET LIGHT LAYOUT		DING/PAD CERTIFICATION
OTHER (SPECIFY)		K ORDER APPROVAL
PRE-DESIGN MEETING?		MR/LOMR
		ODPLAIN DEVELOPMENT PERMIT
		ER (SPECIFY)
DATE SUBMITTED: 10-25-2018	By: SHAWN BIAZAR	
COA STAFF:	ELECTRONIC SUBMITTAL REC	EIVED:

FEE PAID:_____

Location LOT 12, COOR-ARENAL INDUSTRIAL PARK SUBDIVISION, is located at 7000 Husemen Place, SW containing 0.9856 acre. See attached portion of Vicinity Map M-10-Z for exact The purpose of this drainage report is to present a grading and drainage solution for new buildings and improvement for LOT 12, COOR-ARENAL INDUSTRIAL PARK SUBDIVISION. **Existing Drainage Conditions** This lot is very flat and drains north into Husemen Place, SW and no other offiste flows enters this site. There are existing gravel on site and some grading has been done. Proposed Conditions and On-Site Drainage Management Plan We are porposing to retain all the developed flow. The total volume requirement under this condition is 10,178.64 CF. We are proposing a total of five ponds (A-E) with total volume provided of 11,832.68 CF wich includes the first flush volume requirement of 912.32 CF. **VOLUME CALCULATIONS FOR 10 DAY STORM** (UNDER PROPOSED CONDITIONS) BASIN AREA (SF) AREA (AC) AREA (MI²) ON-SITE 42,932.74 0.9856

P-60 = 2.01P-360 = 2.35P-1440 = 2.75P-10 Day = 3.95V-360 =0.1351 AC-FT

V-10 DAY = 0.2337 AC-FTV-10 DAY= 10,178.64 CF

V (REQUIRED) = 10,178.64 CF

0.7392 AC

E = EA(AA) + EB(AB) + EC(AC) + ED(AD)

V-360 = E(AA + AB + AC + AD)

EA = 0.44

EB = 0.67EC = 0.99

ED = 1.97

AA = 0.00%

AB = 25.00%

AC = 0.00%AD = 75.00%

AA + AB + AC + AD

PONDING VOLUME REQUIREMENTS (90TH PERCENTILE/FIRST FLUSH)

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VOLUME REQUIRED = 0.34 INCHES x IMPERVIOUS AREA =
(0.34/12 \times 32,199.55) = 912.32 \text{ CF}
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PONDING VOLUME CALCULATION

TOTAL POND AREA PROVIDED = PONDING CALCULATIONS:

POND A: AREA @ ELEV. 84.00 = 3196.00 SF

AREA @ ELEV. 83.50 = 7.07 SF POND VOLUME=(3196.00+7.07)/2*0.50=800.77 CF

AREA @ ELEV. 84.00 = 5310.09 SF

AREA @ ELEV. 83.50 = 7.07 SF POND VOLUME=(5310.09+7.07)/2*0.0.50=1329.29 CF

AREA @ ELEV. 84.00 = 3243.32 SF AREA @ ELEV. 83.50 = 510.70 SF AREA @ ELEV. 83.00 = 297.72 SF

AREA @ ELEV. 81.00 = 120.24 SF POND VOLUME=(938.51+202.11+417.96)= 1558.57 CF

POND D:

AREA @ ELEV. 84.00 = 3417.78 SF


AREA @ ELEV. 83.50 = 7.07 SF POND VOLUME=(3417.78+7.07)/2*0.50= 856.21 CF


AREA @ ELEV. 84.00 = 4344.91 SF AREA @ ELEV. 83.50 = 1945.92 SF AREA @ ELEV. 83.00 = 1784.68 SF

AREA @ ELEV. 79.00 = 606.56 SF POND VOLUME=(1572.71+932.65+4782.48)= 7287.84 CF

TOTAL PONDING VOLUME PROVIDED =

800.77 + 1329.29 + 1558.57 + 856.21 + 7287.84 = 11,832.68 CF

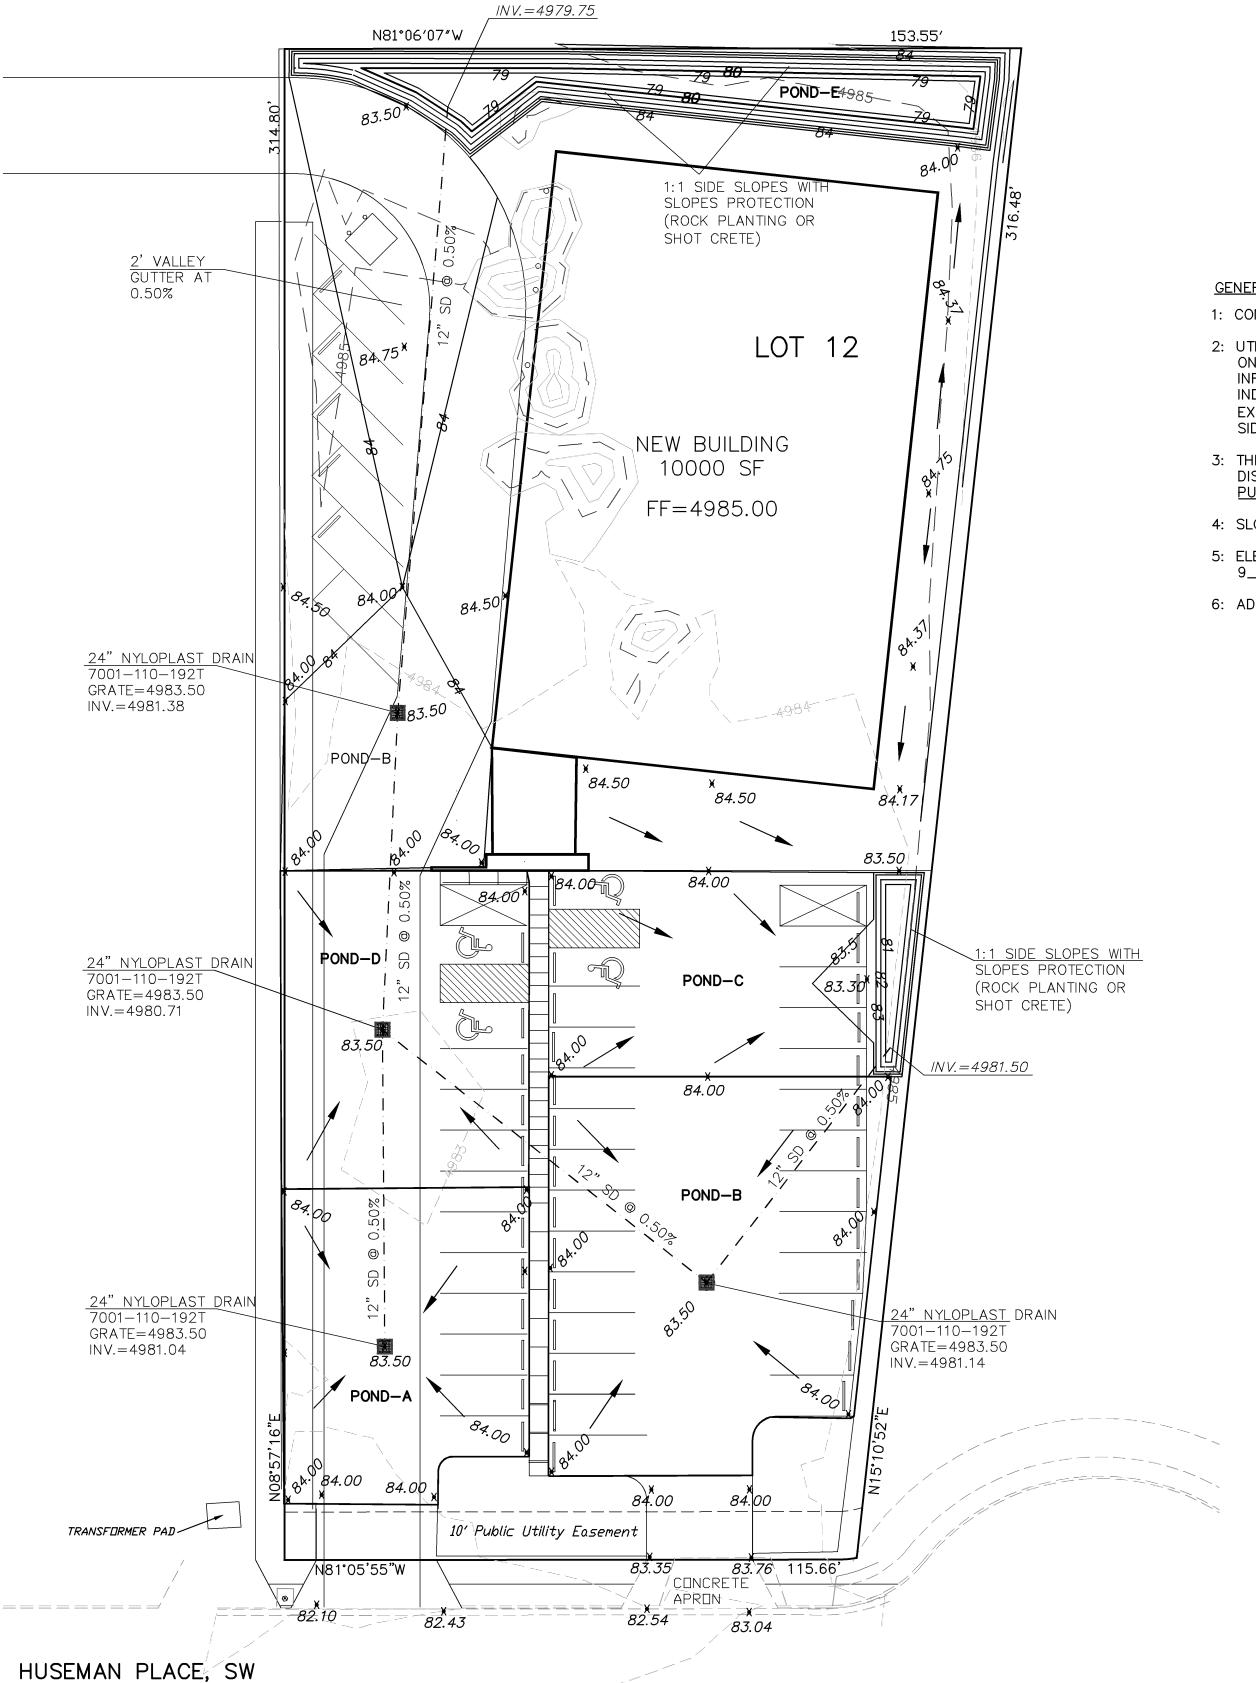

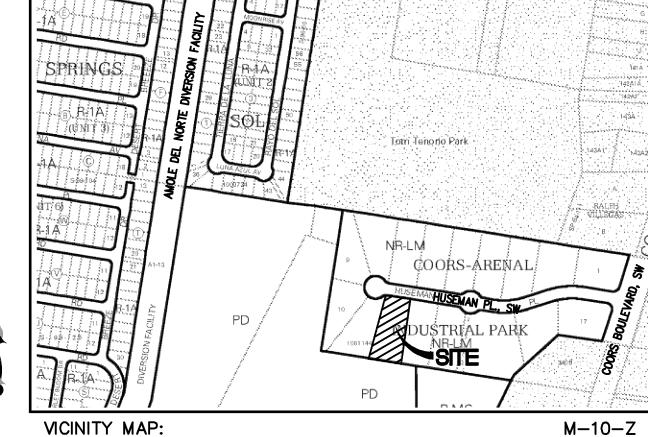

GENERAL NOTES:

1: CONTOUR INTERVAL IS HALF (1.00) FOOT.

2: UTILITIES SHOWN HEREON ARE IN THEIR APPROXIMATE LOCATION BASED ONLY ON ABOVE GROUND EVIDENCE FOUND IN THE FIELD AND AS-BUILT INFORMATION PROVIDED BY THE CLIENT. UTILITIES SHOWN HEREON, WHETHER INDICATED AS ABANDONED OR NOT, SHALL BE VERIFIED BY OTHERS FOR EXACT LOCATION AND/ OR DEPTH PRIOR TO EXCAVATION OR DESIGN CON-SIDERATIONS.

- 3: THIS IS NOT A BOUNDARY SURVEY, BEARINGS ARE ASSUMED, DISTANCES AND FOUND PROPERTY CORNERS ARE FOR INFORMATIONAL PURPOSES ONLY.
- 4: SLOPES ARE AT 3:1 MAXIMUM UNLESS NOTED.
- 5: ELEVATIONS ARE BASED ON CITY OF ALBUQUERQUE CONTROL STATION 9_M11, HAVING AN ELEVATION OF 4957.54 FEET ABOVE SEA LEVEL.
- 6: ADD 4900 TO ALL PROPOSED SPOT ELEVATIONS.

VICINITY MAP:

Bernalillo County Unincorporated Area 350001 City of Albuquerqu

FIRM MAP: EFFECTIVE DATE: 35001C03370 09-26-2008

LEGAL DESCRIPTION:

LOT 12, COORS ARENAL INDUSTRIAL PARK SUBDIVISION CONTAINING 0.9856 ACRE ADDRESS: 7000 HUSEMAN PLACE, SW

LEGEND

BOUNDARY LINE EASEMENT LINE EXISTING SAS EXISTING SEWER EXISTING SD EXISTING STORM DRAIN EXISTING CURB & GUTTER CHAIN LINK FENCE EXISTING SIDEWALK EXISTING FIRE HYDRANT EXISTING WATER SERVICE EXISTING DROP INLET



LAST REVISION: 11-24-2013

SBS CONSTRUCTION AND ENGINEERING, LLC

> 10209 SNOWFLAKE CT., NW ALBUQUERQUE, NEW MEXICO 87114 (505)899-5570

GRAPHIC SCALE

SCALE: 1"=20'

DKG ROOFING, INC 7000 HUSEMAN PLÁCE, SW **GRADING PLAN**

DRAWN BY: DATE: SHEET# DRAWING: 201827-GD.DWG SDR 10/29/2017