
VICINITY MAP

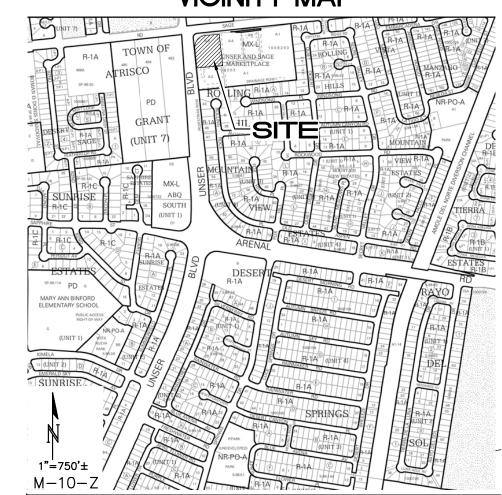

STORMWATER QUALITY REQ'S

ALL NEW DEVELOPMENT AND REDEVELOPMENT PROJECTS SHALL APPLY BEST MANAGEMENT PRACTICES (BMPS) TO MANAGE THE STORMWATER QUALITY VOLUME (SWQV) BY MANAGEMENT ON-SITE, OR PAYMENT-IN-LIEU, OR PRIVATE OFF-SITE MITIGATION.

FOR NEW DEVELOPMENT SITES, THE CABQ STORMWATER QUALITY VOLUME (SWQV) IS BASED ON THE 90TH PERCENTILE STORM EVENT OR 0.42".

THE IMPERVIOUS AREA FOR THE PORTION OF THE PROPERTY TO BE DEVELOPED (BASINS A1, A2, A3, A4, A5, A7 AND A8) IS 23,622 SF (FUTURE BASIN A6 DEVELOPMENT IS NOT INCLUDED): THE TOTAL REQUIRED S.Q. RETENTION VOLUME = 0.42/12 * 23,622 SF = 827 CF.

TWO SWQ RETENTION PONDS WILL BE CONSTRUCTED AS SHOWN (DRAINAGE BASIN PONDS A1 AND A2).

POND A7			PER BASIN CALCS:
Contour	Area	Volume	BASIN A7 REQUIRES 1
5080	1000		CF OF SWQV.
5079.0	60	530 CF	
POND VO	DLUME =	530 CF	

I OND Y	JEUNIE		
POND A2			
Contour	Area	Volume	PER BASIN CALCS:
5079.4	240		BASIN A2 REQUIRES 3
5079	160	80 CF	CF OF SWQV.
5078	15	88 CF	


TOTAL SWQV PROVIDED = 167+12 = 179 CF.

POND VOLUME = 167 CF

A "PAYMENT IN-LIEU FOR S.Q. VOLUME REQUIREMENT" TREASURY DEPOSIT SLIP WILL BE PROVIDED BY C.O.A. HYDROLOGY BASED ON THE PORTION OF S.Q. VOLUME THAT IS NOT RETAINED ON-SITE (827 - 179 = 648 CF) @ \$8.00 / CF FOR COMMERCIAL.

A DRAINAGE COVENANT WILL BE REQUIRED FOR THE SWQV PONDS PRIOR TO RELEASE OF CERTIFICATE OF OCCUPANCY. THE ORIGINAL NOTARIZED FORM AND EXHIBIT 'A' ALONG WITH THE RECORDING FEE (PAYABLE TO CITY OF ALBUQUERQUE) WILL BE SUBMITTED BY THE OWNER.



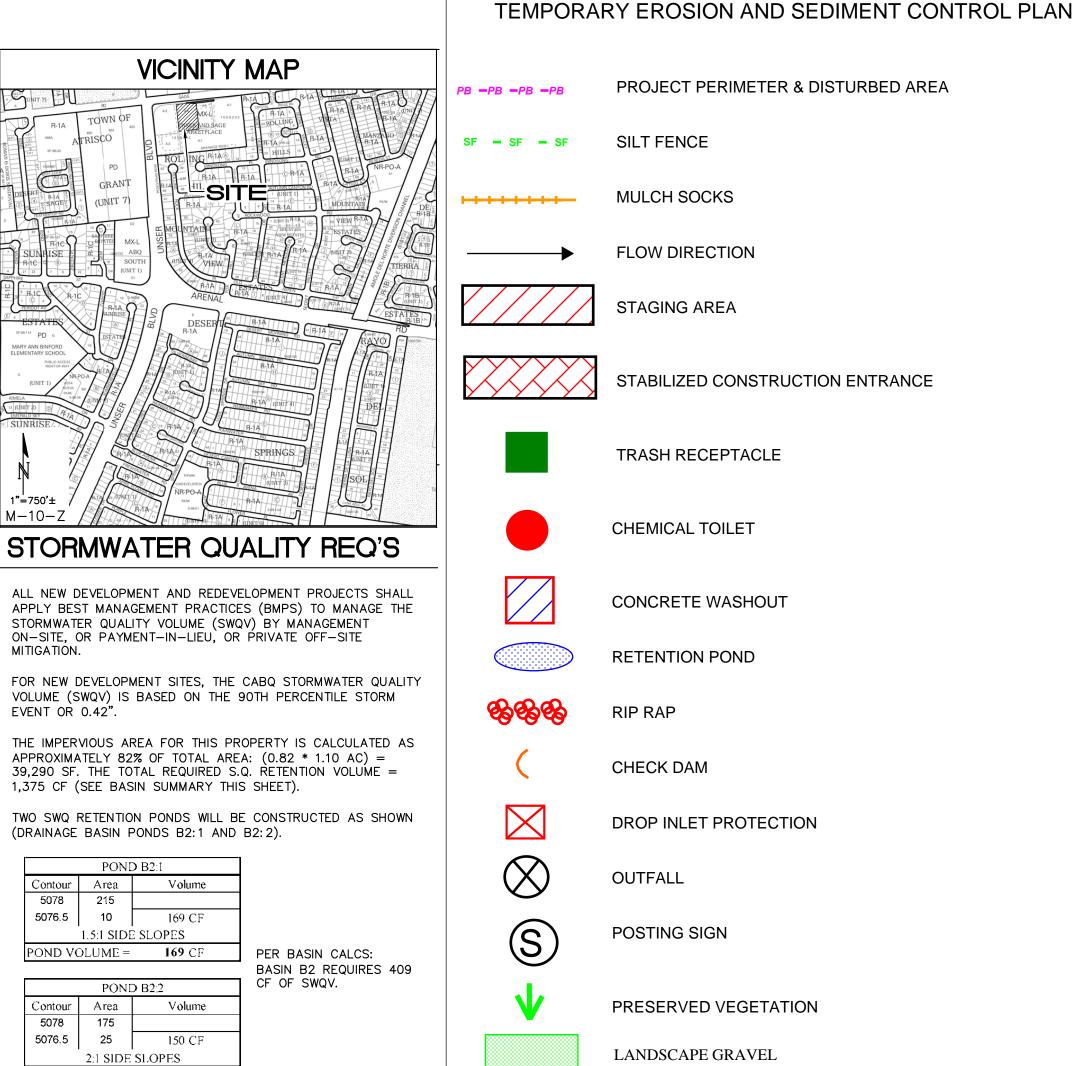

HYDROLOGY BASED ON THE PORTION OF S.Q. VOLUME THAT IS NOT RETAINED ON-SITE (1375 - 319 = 1056 CF) @ \$8.00 / CF FOR COMMERCIAL.

A DRAINAGE COVENANT WILL BE REQUIRED FOR THE SWQV PONDS PRIOR TO RELEASE OF CERTIFICATE OF OCCUPANCY. THE ORIGINAL NOTARIZED FORM AND EXHIBIT 'A' ALONG WITH THE RECORDING FEE (PAYABLE TO CITY OF ALBUQUERQUE) WILL BE

| CRITICAL HABITAT: CRITERIAN "A"; NO CRITICAL HABITATS WITHIN THE

PROJECT AREA

RECEIVING WATERS: ABQ MS4 TO AMOLE DETENTION BASIN

<u>LEGEND</u>

GPS LOCATION: 35.0576, -106.7213

SCHEDULE/SEQUENCING OF CONSTRUCTION

POST PERMITS

2. INSTALL REQUIRED BMPs 2.a. PERIMETER CONTROLS

2.b. STABILIZED CONSTRUCTION ENTRANCE 2.c. CONCRETE WASHOUT AREA

CLEAR/GRUB

4. TEMP POND EARTHWORK AND GRADING

6. UTILITY INSTALLATION

7. PAVEMENT STRUCTURES

8. VERTICAL STRUCTURES

9. LANDSCPING

10. PUNCHLIST

02/15/2021

CPESC Stamp

KIDZ ACADEMY PRESCHOOL AND THE HUMAN BEAN

PROJECT TITLE

ALBUQUERQUE, BERNALILLO COUNTY, NM

02/15/2021

C. DURKIN DRAWN BY INSPECTIONS PLUS

CITY, COUNTY, STATE

SITE WILL HAVE A SILT FENCE PERIMETER WITH INLET PROTECTION FOR ACTIVE INLETS. RETENTION PONDS SHALL BE CONSTRUCTED DURING GRADING AND EARTHWORK.


INLET PROTECTION









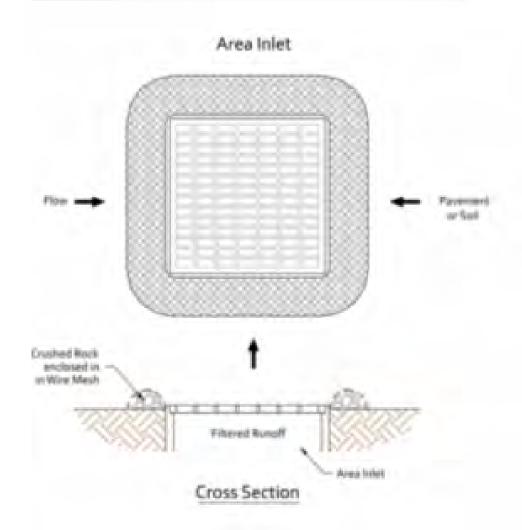

BMP Objectives

- **Sediment Control**
- Sheet Flow Runoff Control

SILT FENCE



BMP Objectives

- **Sediment Control**
- Sheet Flow Runoff Control
- Wind Erosion Control

SEDIMENT TRACK OUT CONTROL




MULCH SOCK/STRAW WATTLE



BMP Objectives

- Sediment Control
- Reduce Runoff Velocity
- **Inlet Protection**

BERMS AND SWALES

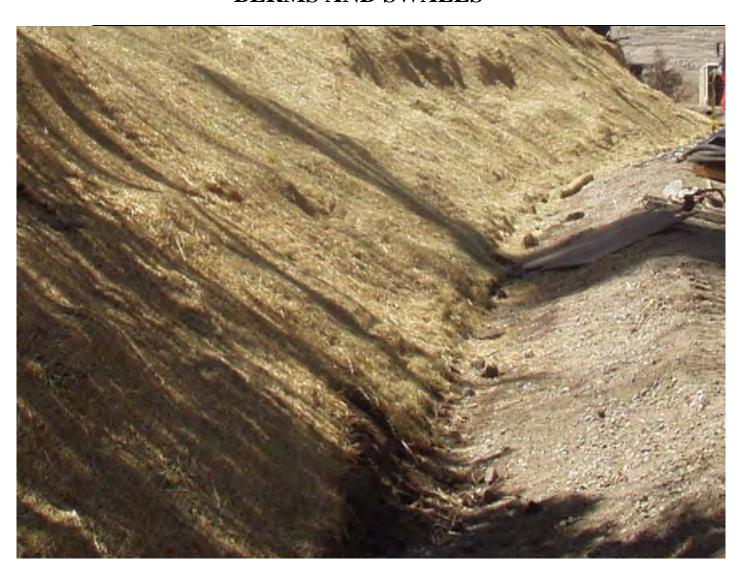

BMP Objectives

- Runoff Control
- Run-on Diversion

EROSION CONTOL NOTES ESC Plan Standard Notes (2020-06-03)

1.All Erosion and Sediment Control (ESC) work on these plans, except as otherwise stated or provided hereon shall be permitted, constructed, inspected, and maintained in accordance with:

a.The City Ordinance § 14-5-2-11, the ESC Ordinance,

b.The EPA's 2017 Construction General Permit (CGP), and

c.The City Of Albuquerque Construction BMP Manual.

2.All BMP's must be installed prior to beginning any earth moving activities except as specified hereon in the Phasing Plan. Construction of earthen BMP's such as sediment traps, sediment basins, and diversion berms shall be completed and inspected prior to any other construction or earthwork. Self-inspection is required after installation of the BMPs and prior to beginning construction.

3.Self-inspections - At a minimum a routine compliance self-inspection is required to review the project for compliance with the Construction General Permit once every 14 days and after any precipitation event of 1/4 inch or greater until the site construction has been completed and the site determined as stabilized by the city. Reports of these inspections shall be kept by the person or entity authorized to direct the construction activities on the site.

4.BMPs shall be inspected and maintained until all disturbed areas are stabilized in accordance with the Final Stabilization Criteria (CGP 2.2.14.b). Generally, all disturbed areas, other than structures, must have uniform perennial vegetation that provides 70 percent or more of the cover provided by native vegetation or seed the disturbed area and provide non-vegetative mulch that provides cover for at least three years without active maintenance. Final stabilization must be documented on prior to removal of BMPs and discontinuation of inspections.

RECEIVING WATERS: ABQ MS4 TO AMOLE DETENTION BASIN

CRITICAL HABITAT: CRITERIAN "A"; NO CRITICAL HABITATS WITHIN THE PROJECT AREA

GPS LOCATION: 35.0576, -106.7213



KIDZ ACADEMY PRESCHOOL AND THE HUMAN BEAN

ALBUQUERQUE, BERNALILLO COUNTY, NM CITY, COUNTY, STATE

02/15/2021

DATE


INSPECTIONS PLUS DRAWN BY

PROJECT TITLE

02/15/2021 **CPESC Stamp**


C. DURKIN

LATERAL LINE TESTING SHALL BE COMPLETED PRIOR TO INSTALLATION LATERAL TESTING SHALL BE ACCOMPLISHED BY INSTALLING A PLUG IN THE OUTLET OF LATERAL LINE TEES AND ELLS.

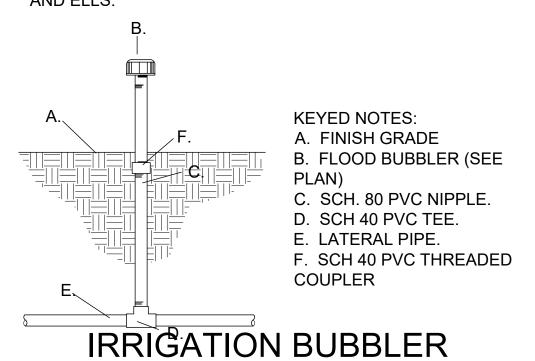

SCALE: NTS


NOTE: CUT & REMOVE WIRE FROM ROOTBALL. PEEL BACK BURLAP TO EXPOSE TOP 1/3 OF ROOTBALL. CAREFULLY TAMP IN BACKFILL MIX TO

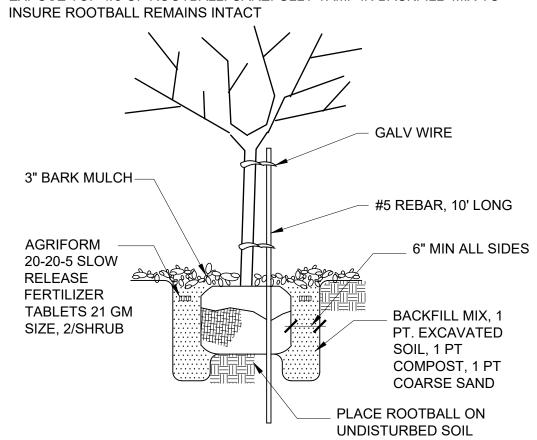

TREE PLANTING


SCALE: NTS

NOTE: CONTRACTOR SHALL GRADE SOIL ADJACENT TO TREES AND SHRUBS TO ENSURE EVEN AND ADEQUATE WATERING OF ALL PLANT MATERIAL

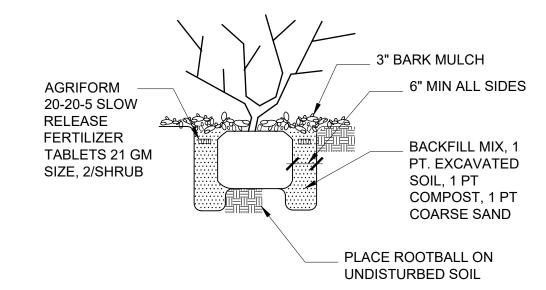

LANDSCAPE PLANTING

SCALE: NTS

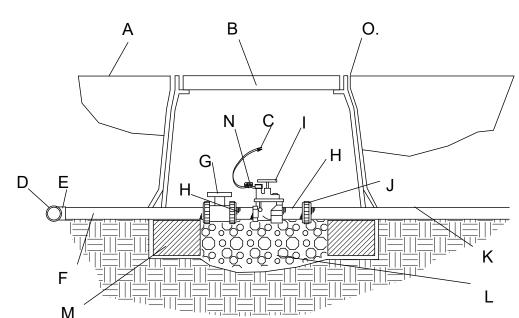

KEYED NOTES:

A. FINISH GRADE

B. BROOKS PRODUCTS, INC. 1730 PB-18 BODY (ABS) VALVE BOX W/1730 BOLT DOWN COVER (ABS) & TWO 8"

- D. IRRIGATION MAINLINE.

- K. LATERAL LINE.
- L. 1 CUBIC FOOT 1" DIA. WASHED ROCK.
- M. 8" X 8" X 16" SOLID CMU BLOCK. N. 24" WIRE EXPANSION COIL.
- O. 6 mm BLACK POLYETHYLENE PLASTIC. TAPE TO ALL INLET & OUTLET PIPE & INSTALL THE FULL DEPTH OF THE

NOTES:

INSTALL AN 8" X 8" X 16" SOLID CMU BLOCK @ EA. CORNER OF THE VALVE BOX.


WASH ROCK SHALL BE INSTALLED FLUSH WITH BOTTOM OF PIPE & VALVE.

EXTENSIONS. C. DRY SPLICE CONNECTOR OR EQUAL. E. IRRIGATION MAINLINE SERVICE TEE OR ELL. F. SCHEDULE 80 PVC X 12" NIPPLE. G. SPEARS TRUE UNION SCHEDULE 80 PVC BALL VALVE. H. SCHEDULE 80 PVC CLOSE NIPPLE I. ELECTRIC VALVE (SEE PLAN) J. SPEARS SCHEDULE 80 PVC UNION.

VALVE BOX BOTTOM.


IRRIGATION VALVES



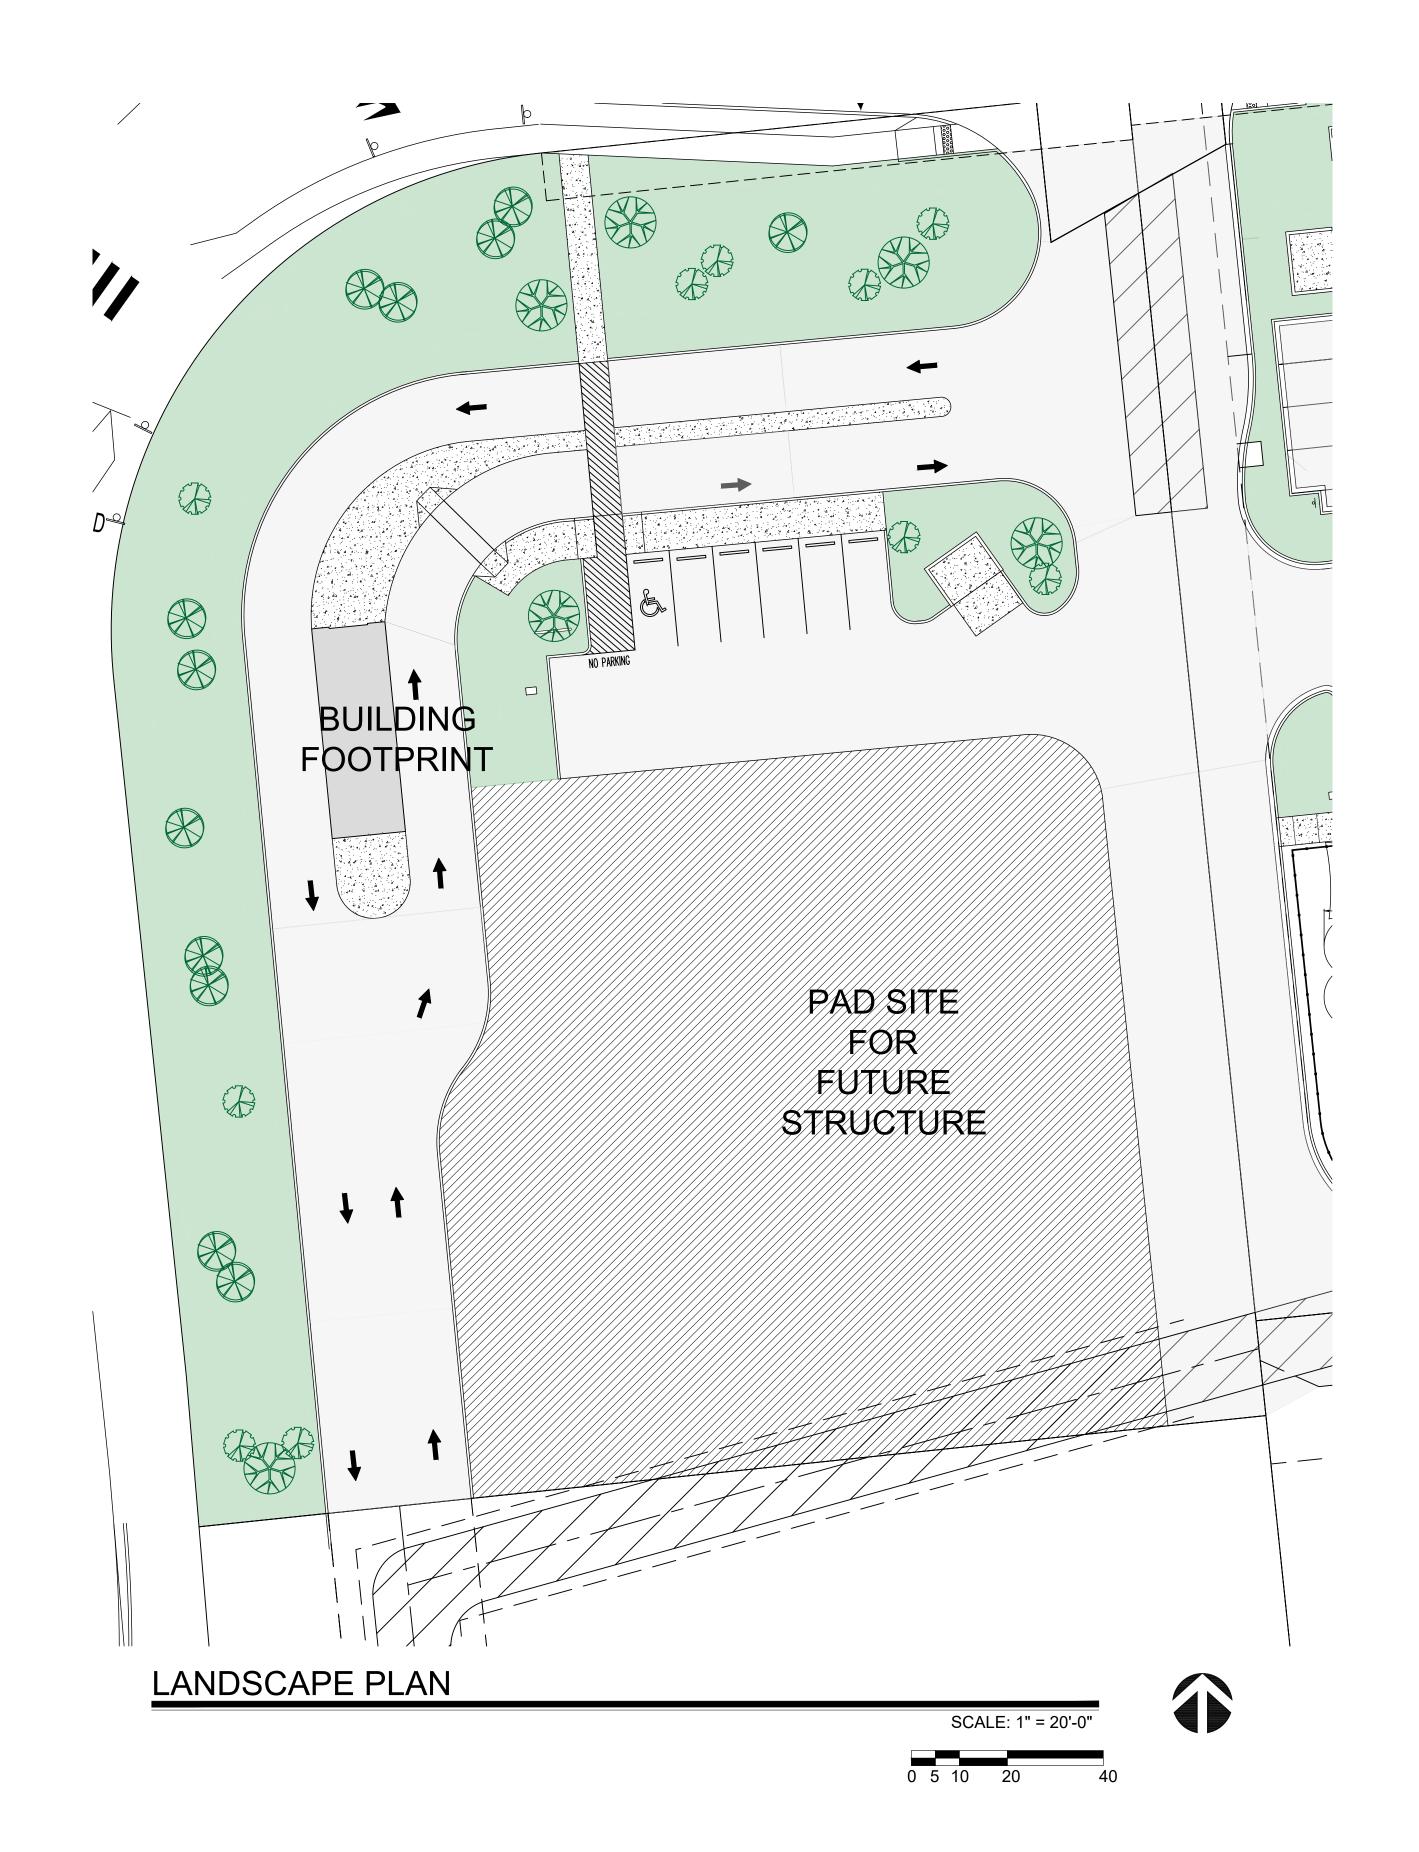

MX-L ZC TOTAL (BUILDIN **PAVING** PAD SIT LANDSC

SIDEWA

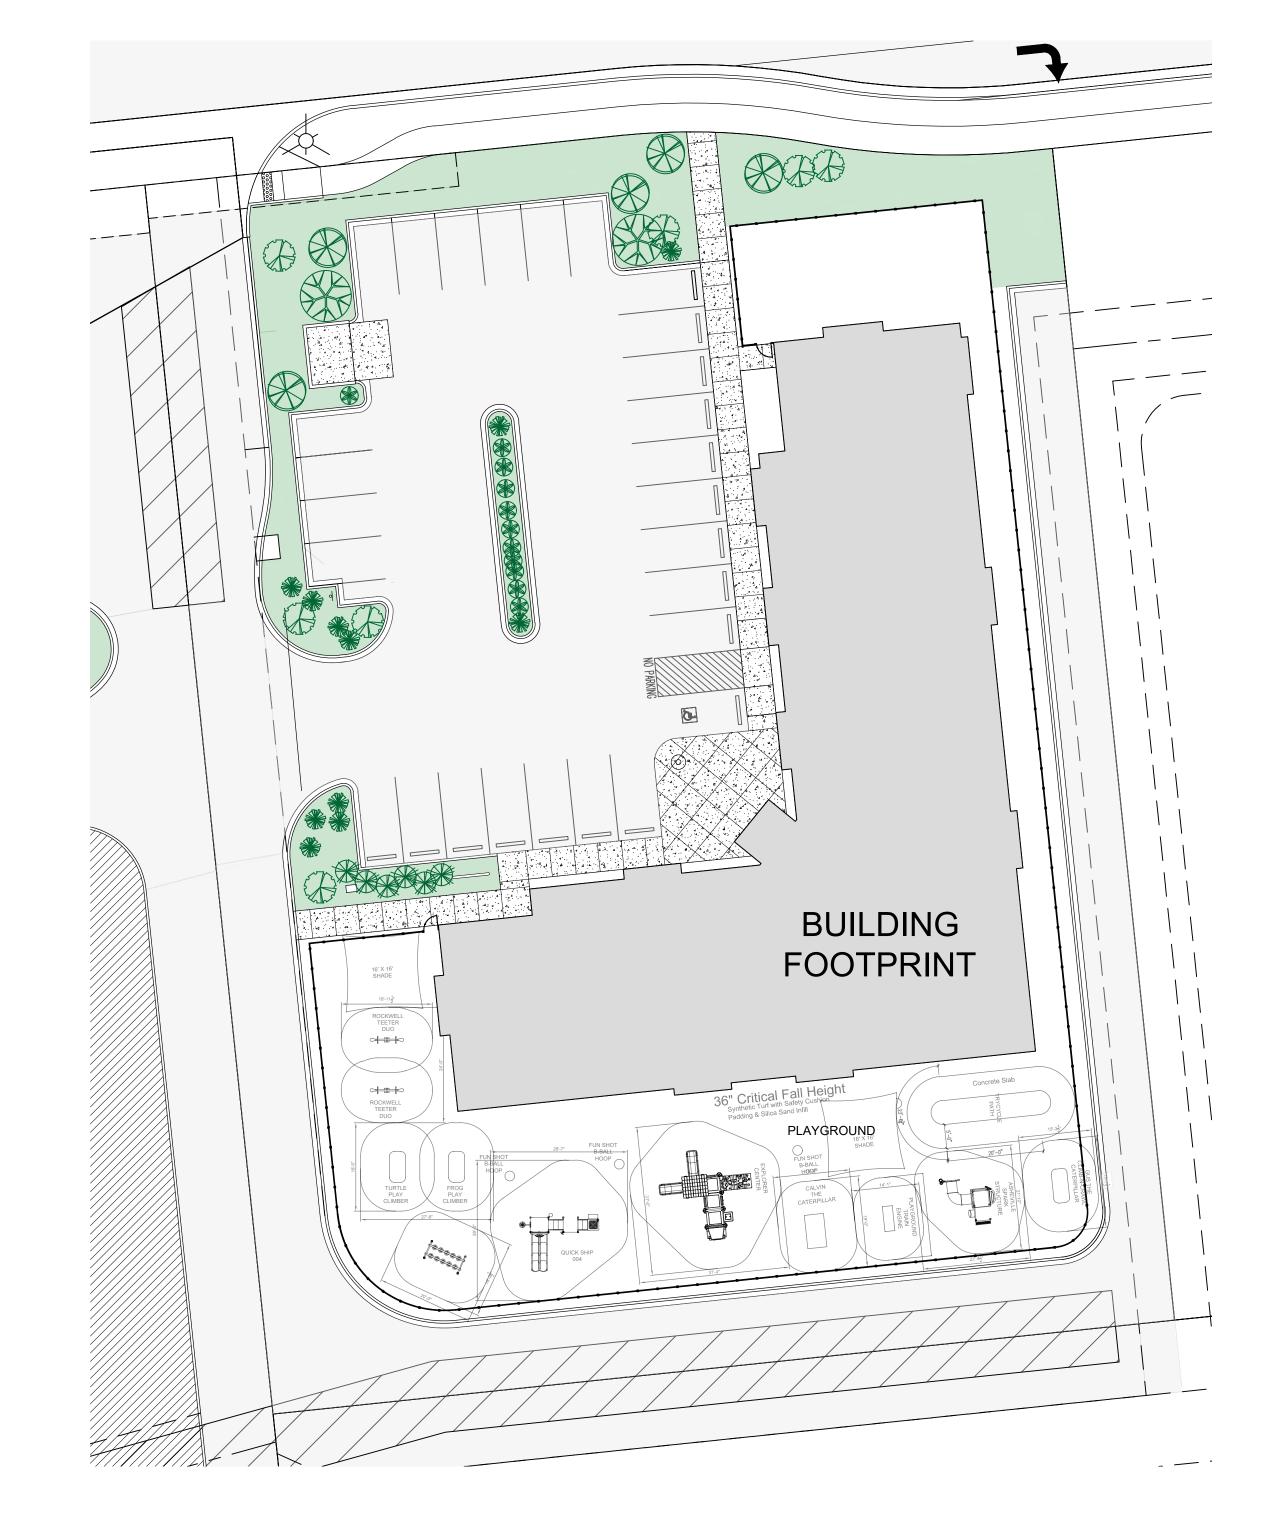

LANDSCAPE PLAN

UNDISTURBED SOIL TREE PLANTING

LATERAL LINE TESTING SHALL BE

INSURE ROOTBALL REMAINS INTACT

3" BARK MULCH-

AGRIFORM

20-20-5 SLOW RELEASE **FERTILIZER** TABLETS 21 GM

SIZE, 2/SHRUB

LATERAL TESTING SHALL BE

AND ELLS.

COMPLETED PRIOR TO INSTALLATION

ACCOMPLISHED BY INSTALLING A PLUG IN THE OUTLET OF LATERAL LINE TEES

> **KEYED NOTES:** A. FINISH GRADE

B. FLOOD BUBBLER (SEE

C. SCH. 80 PVC NIPPLE. D. SCH 40 PVC TEE.

F. SCH 40 PVC THREADED

SCALE: NTS

GALV WIRE

#5 REBAR, 10' LONG

BACKFILL MIX, 1

PT. EXCAVATED SOIL, 1 PT COMPOST, 1 PT COARSE SAND

6" MIN ALL SIDES

E. LATERAL PIPE.

COUPLER

IRRIGATION BUBBLER


NOTE: CUT & REMOVE WIRE FROM ROOTBALL. PEEL BACK BURLAP TO

EXPOSE TOP 1/3 OF ROOTBALL. CAREFULLY TAMP IN BACKFILL MIX TO

SCALE: NTS

PLACE ROOTBALL ON

NOTE: CONTRACTOR SHALL GRADE SOIL ADJACENT TO TREES AND SHRUBS TO ENSURE EVEN AND ADEQUATE WATERING OF ALL PLANT MATERIAL

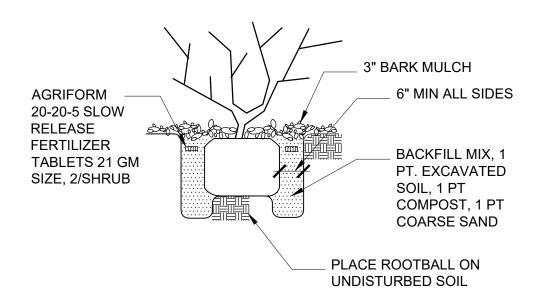

LANDSCAPE PLANTING

SCALE: NTS

IRRIGATION VALVES

SCALE: NTS

KEYED NOTES: A. FINISH GRADE B. BROOKS PRODUCTS, INC. 1730 PB-18 BODY (ABS) VALVE BOX W/1730 BOLT DOWN COVER (ABS) & TWO 8" EXTENSIONS. C. DRY SPLICE CONNECTOR OR EQUAL. F. SCHEDULE 80 PVC X 12" NIPPLE.

D. IRRIGATION MAINLINE. E. IRRIGATION MAINLINE SERVICE TEE OR ELL.

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I. ELECTRIC VALVE (SEE PLAN) J. SPEARS SCHEDULE 80 PVC UNION.

K. LATERAL LINE. L. 1 CUBIC FOOT 1" DIA. WASHED ROCK.

M. 8" X 8" X 16" SOLID CMU BLOCK. N. 24" WIRE EXPANSION COIL.

O. 6 mm BLACK POLYETHYLENE PLASTIC. TAPE TO ALL INLET & OUTLET PIPE & INSTALL THE FULL DEPTH OF THE VALVE BOX BOTTOM.

NOTES: INSTALL AN 8" X 8" X 16" SOLID CMU BLOCK @ EA. CORNER OF THE VALVE BOX. WASH ROCK SHALL BE INSTALLED FLUSH WITH BOTTOM OF PIPE & VALVE.

GENERAL NOTES:

- 1. ALL PLANTING AREAS NOT COVERED IN TURF SHALL HAVE A GROUND TOPPING OF CRUSHED ROCK, RIVER ROCK, OR OTHER SIMILAR MATERIAL WHICH EXTENDS COMPLETELY UNDER THE PLANT MATERIAL, HOWEVER THESE MATERIALS SHALL NOT BE USED AS FOCAL LANDSCAPE.
- 2. IT IS THE INTENT OF THIS PLAN TO COMPLY WITH THE CITY OF ALBUQUERQUE WATER CONSERVATION LANDSCAPING AND WATER WASTE ORDINANCE PLANTING RESTRICTION APPROACH.
- 3. APPROVAL OF THIS PLAN DOES NOT CONSTITUTE OR IMPLY EXEMPTION FROM WATER WASTE PROVISIONS OF THE WATER CONSERVATION LANDSCAPING AND WATER WASTE ORDINANCE. WATER MANAGEMENT IS THE SOLE RESPONSIBILITY OF THE PROPERTY OWNER.
- 4. ALL LANDSCAPING WILL BE IN CONFORMANCE WITH THE CITY OF ALBUQUERUQE ZONING CODE, STREET TREE ORDINANCE, POLLEN ORDINANCE, AND WATER CONSERVATION LANDSCAPING AND WATER WASTE ORDINANCE. IN GENERAL WATER CONSERVATIVE, ENVIRONMENTALLY SOUND LANDSCAPE PRINCIPLES WILL BE FOLLOWED IN DESIGN AND INSTALLATION.
- 5. PLANT BEDS SHALL ACHIEVE 75% LIVE GROUND COVER AT MATURITY.
- 6. SFBROWN GRAVEL OVER FILTER FABRIC SHALL BE PLACED IN ALL LANDSCAPE AREAS WHICH ARE NOT DESIGNATED TO RECEIVE NATIVE SEED.
- 7. IRRIGATION SHALL BE A COMPLETE UNDERGROUND SYSTEM WITH TREES TO RECEIVE (5) 1.0 GPH DRIP EMITTERS AND SHRUBS TO RECEIVE (2) 1.0 GPH DRIP EMITTERS. DRIP AND BUBBLER SYSTEMS TO BE TIED TO 1/2" POLYPIPE WITH FLUSH CAPS AT EACH END.
- 8. FINAL LANDSCAPING LAYOUT AND DESIGN TO BE DETERMINED UPON RECEIPT OF FINAL GRADING PLAN.
- 9. INSTALL BACKFLOW PREVENTION @ IRRIGATION SYSTEM.

- DW DESERT WILLOW CHILOPSIS LINEARIS 2 TRUNKS TOTAL 1 $\frac{1}{2}$ " CALIPER
- PL PURPLE LEAF PLUM PRUNIS EDULIS $1\frac{1}{2}$ " CALIPER
- A ARIZONA ASH CHRYSOTHAMUS NAUSEOSUS 1 $\frac{1}{2}$ " CALIPER
- BG BEAR GRASS NOLINA MACROCARPA 5 GAL
- **AS AUTUNM CHERRY SAGE SALVIA GREGGII 5 GAL**
- BS BLUE MIST SPIREA CARYOPTERIS CLANDONENSIS 5 GAL

MX-L ZONING

BUILDING =

PAVING =

PLAYGROUND =

LANDSCAPING =

SIDEWALKS =

TOTAL SITE AREA: 48,017 SF

10,298 SF

19,910 SF

10,174 SF

5,517 SF

2,267 SF

SB - SPANISH BROOM - CYSTIUS PURGANS - 5 GAL

GRAVEL MULCH



SCALE: 1" = 20'-0"

DRAWING TITLE

