CITY OF ALBUQUERO

Planning Department Alan Varela, Director



Mayor Timothy M. Keller

May 24, 2024

Alex Forrester Bowman Engineering 11475 Great Oaks Way Alpharetta, GA 30022

Re: Chick-Fil-A

> 1600 Gibson Blvd. SE **Traffic Circulation Layout**

Engineer's Stamp 05-23-24 (M15-D012C)

Dear Ms. Forrester,

The TCL submittal received 05-17-2024 is approved for Building Permit by Transportation. A copy of the stamped and signed plan will be needed for each of the building permit plans. Please keep the original to be used for certification of the site for final C.O. for Transportation.

PO Box 1293

Albuquerque

When the site construction is completed and an inspection for Certificate of Occupancy (C.O.) is requested, use the original City stamped approved TCL for certification. Redline any minor changes and adjustments that were made in the field. A NM registered architect or engineer must stamp, sign, and date the certification TCL along with indicating that the development was built in "substantial compliance" with the TCL. Submit this certification, the TCL, and a completed Drainage and Transportation Information Sheet to front counter personnel for log in and evaluation by Transportation.

NM 87103

Once verification of certification is completed and approved, notification will be made to Building Safety to issue Final C.O. To confirm that a final C.O. has been issued, call Building Safety at 924-3690.


www.cabq.gov


Sincerely,

Ernest Armijo, P.E.

Principal Engineer, Planning Dept. Development Review Services

C: CO Clerk, File

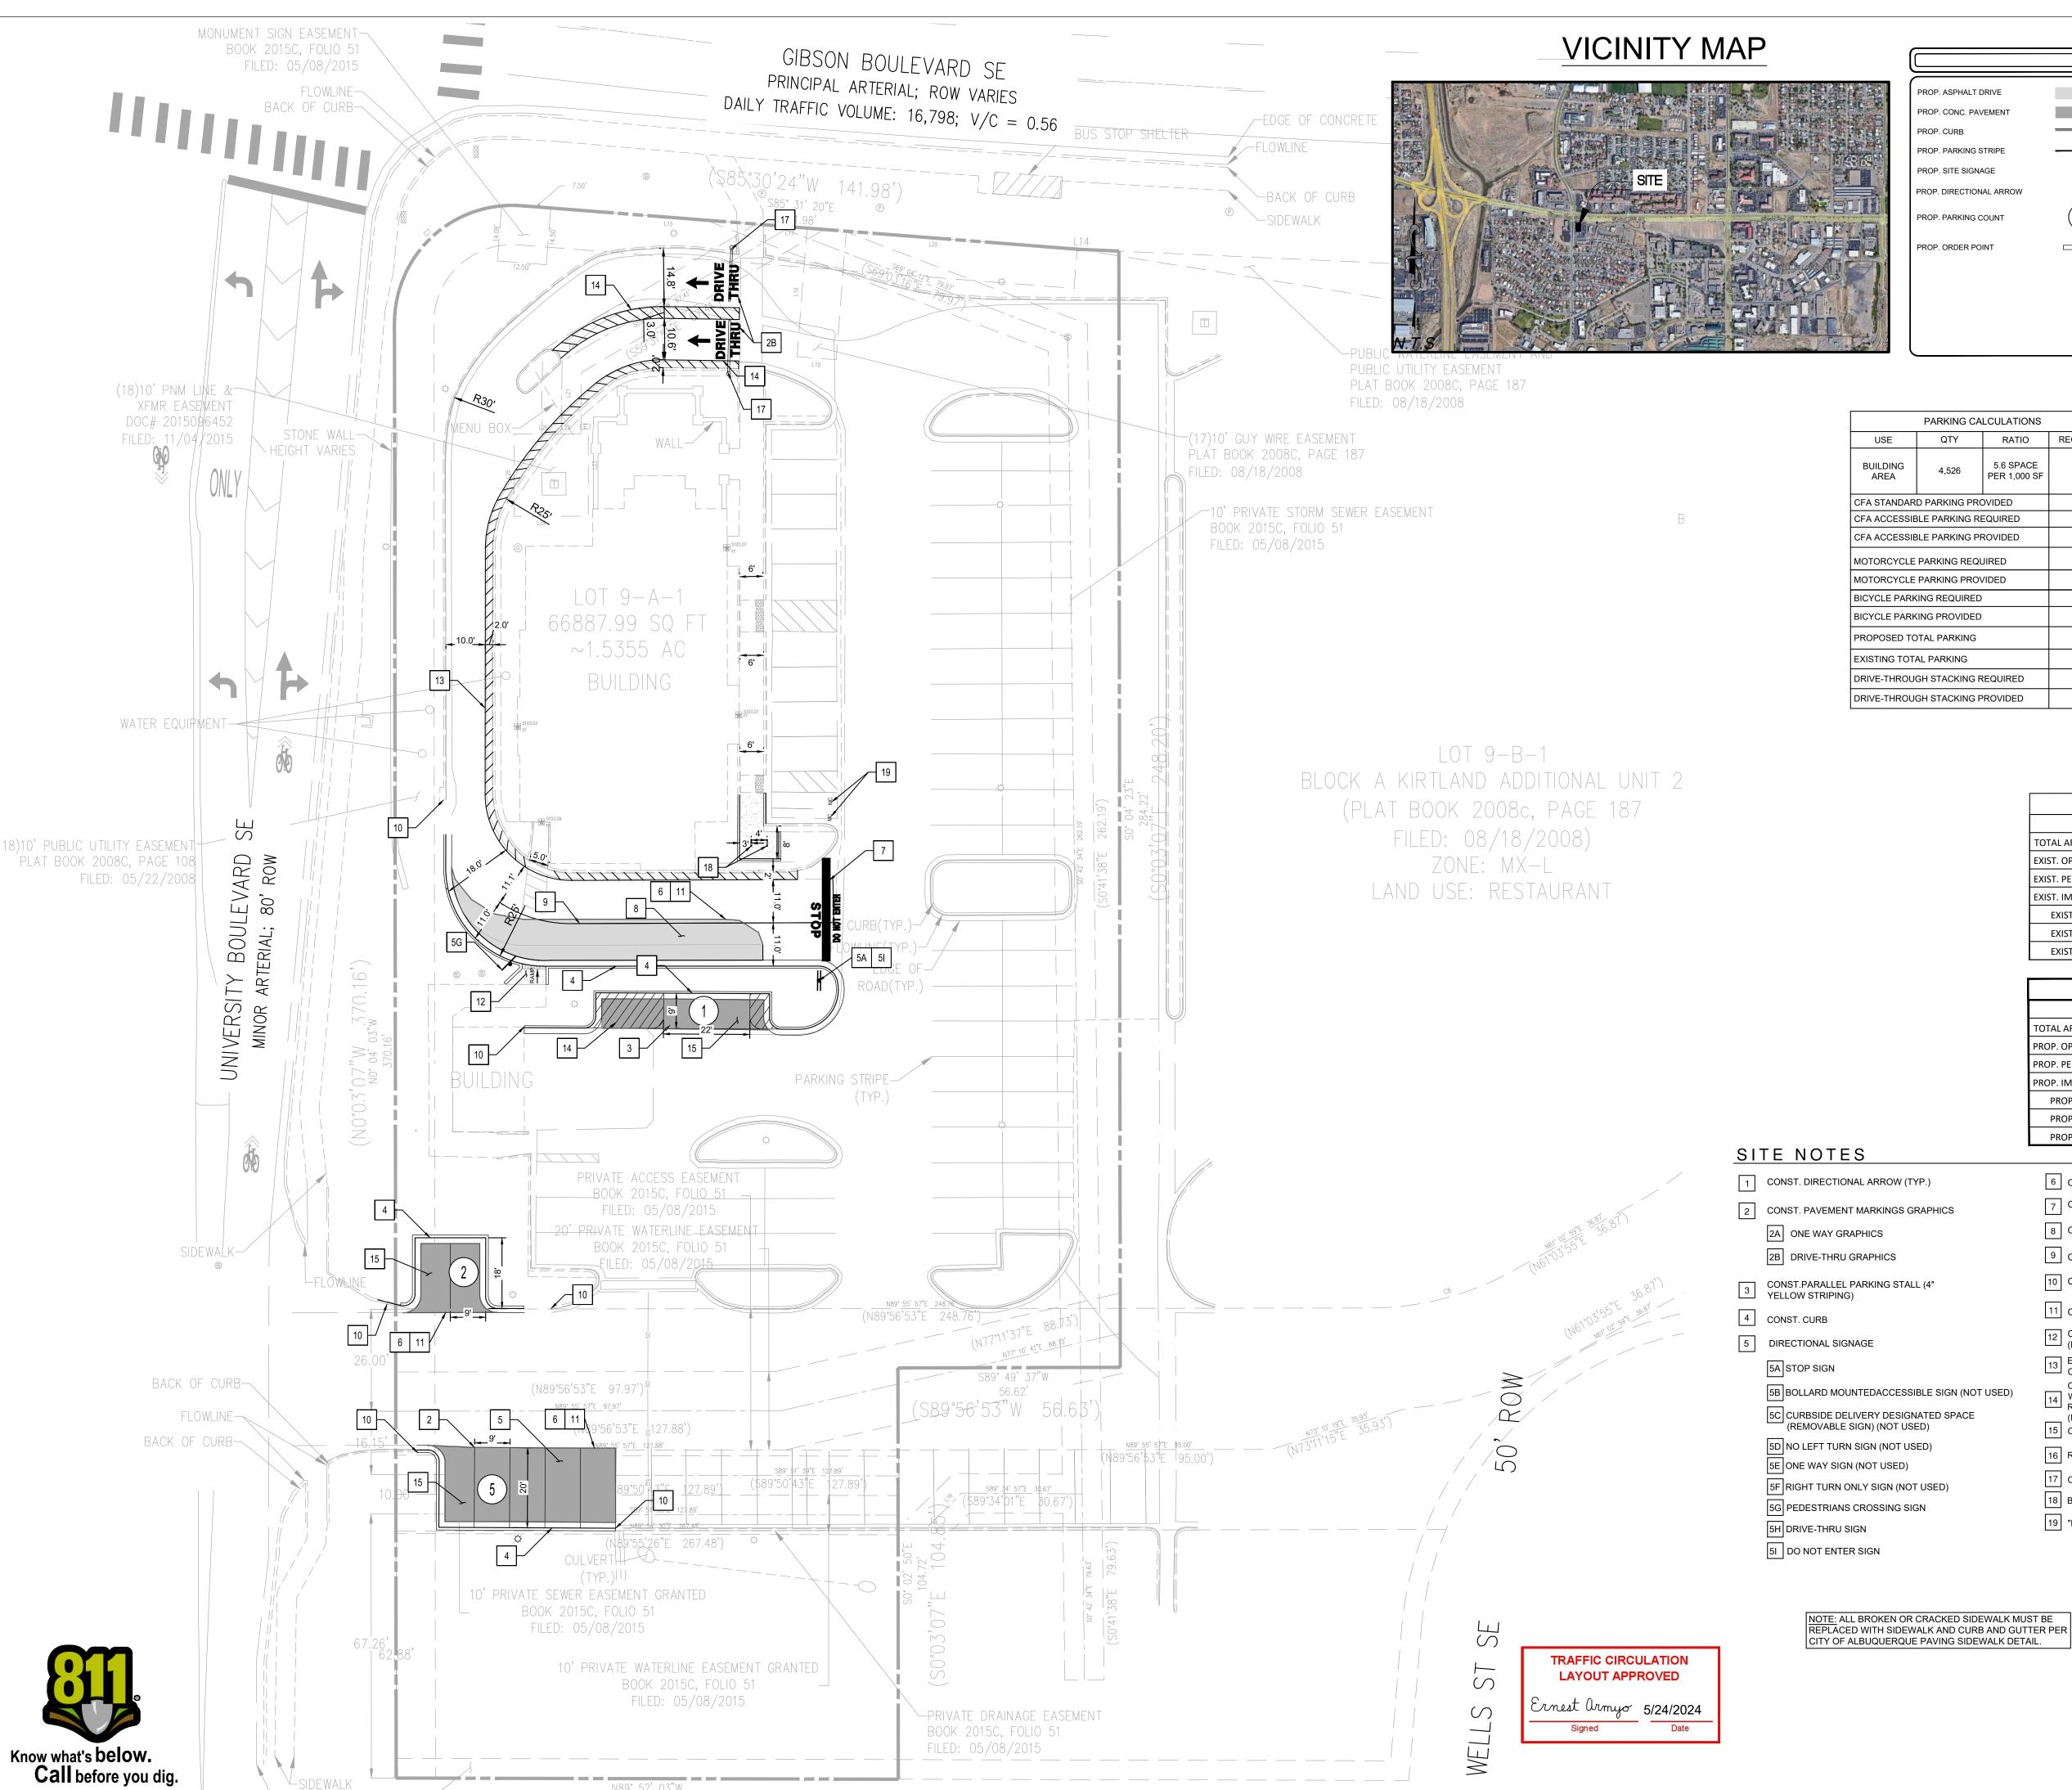

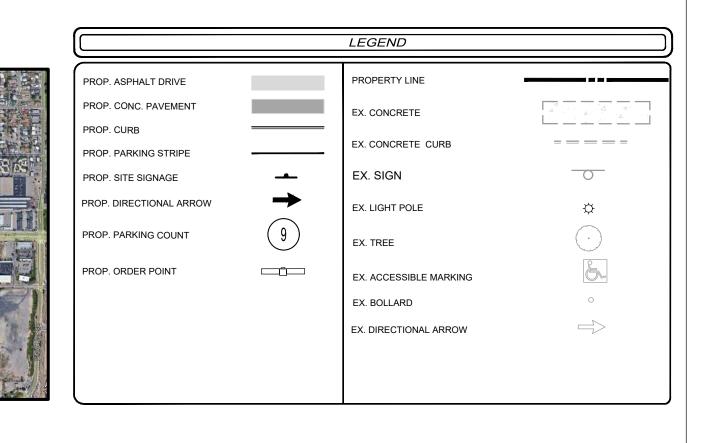

PARKING CALCULATIONS				
USE	QTY	RATIO	REQUIRED	
BUILDING AREA	4,526	5.6 SPACE PER 1,000 SF	26	
CFA STANDARD PARKING PROVIDED			68	
CFA ACCESSIBLE PARKING REQUIRED			3	
CFA ACCESSIBLE PARKING PROVIDED			3	
MOTORCYCLE PARKING REQUIRED			2	
MOTORCYCLE PARKING PROVIDED			2	
BICYCLE PARKING REQUIRED			3	
BICYCLE PARKING PROVIDED			3	
PROPOSED TOTAL PARKING			71	
EXISTING TOTAL PARKING			67	
DRIVE-THROUGH STACKING REQUIRED			12	
DRIVE-THROUGH STACKING PROVIDED 16				

JURISDICTION	CITY OF ALBUQUERQUE		
ZONING	MX-L (LOW INTENSITY ZONE DISTRICT)		
USE	FAST FOOD RESTAURANT WITH DRIVE THRU		
PARCEL ID	ABQ181822 (CITY), 101505528948711715 (COUNTY)		
	LOT		
SIZE	66,888 SF (1.54 AC)		
BUILDING			
SIZE	4,526		
PARKING			
SIZE	9' X 20' (90°) ; 9' X 22' (PARALLEL)		

SITE SUMMARY

BUILDING SETBACKS					
SETBACKS	REQUIRED	PROVIDED			
RONT (SOUTH)	25'	67.92'			
REAR (NORTH)	N/A	44.67'			
SIDE (WEST	N/A	50.90'			
SIDE (EAST)	25'	95.13'			
IG SITE CALCULATIONS					

EXISTING AREA	SF	ACRES	%
TOTAL AFFECTED AREA	66,888	1.54	100.00%
EXIST. OPEN SPACE AREA	19,108	0.44	28.57%
EXIST. PERVIOUS AREA	19,108	0.44	28.57%
EXIST. IMPERVIOUS AREA	47,780	1.10	71.43%
EXIST. BUILDING AREA	4,526	0.10	6.77%
EXIST. PAVEMENT AREA	43,169	0.99	64.54%
EXIST. VEHICULAR USE AREA	35,787	0.82	53.50%

PROPOSED SITE CALCULATIONS			
PROPOSED AREA	SF	ACRES	%
TOTAL AFFECTED AREA	66,888	1.54	100.00%
PROP. OPEN SPACE AREA	17,883	0.41	26.74%
PROP. PERVIOUS AREA	17,883	0.41	26.74%
PROP. IMPERVIOUS AREA	49,005	1.13	73.26%
PROP. BUILDING AREA	4,526	0.10	6.77%
PROP. PAVEMENT AREA	44,394	1.02	66.37%
PROP. VEHICULAR USE AREA	36,883	0.85	55.14%

6 CONST. PAVEMENT EDGE

7 CONST. 24" STOP LINE GRAPHIC

9 CONST. 4" WIDE YELLOW STRIPING

10 CONNECT TO EXISTING CURB

15 CONST ASPHALT PAVEMENT

18 BICYCLE RACK

8 CONST. CONCRETE PAVING DRIVE-THRU LANE

11 CONNECT TO EXISTING EDGE OF PAVEMENT

CONST. DOUBLE LANE F2F ORDER CANOPY (NOT USED)

EXISTING SINGLE ORDER MEAL DELIVERY CANOPY TO REMAIN (NOT USED)

CONST. SOLID 4" YELLOW STRIPING ON ENDS
W/ 4" WIDE STRIPES @ 3' O.C., YELLOW
REFLECTIVE PAINT WITH ANTI-SLIP ADHESIVE

16 RELOCATED FLAG POLE AND BASE (NOT USED)

SITE NOTES

- 1 CONST. DIRECTIONAL ARROW (TYP.)
- 2 CONST. PAVEMENT MARKINGS GRAPHICS
- 2A ONE WAY GRAPHICS
- 2B DRIVE-THRU GRAPHICS
- CONST.PARALLEL PARKING STALL (4" YELLOW STRIPING)

- 5B BOLLARD MOUNTEDACCESSIBLE SIGN (NOT USED)
- 5D NO LEFT TURN SIGN (NOT USED)
- 5F RIGHT TURN ONLY SIGN (NOT USED)
- 5G PEDESTRIANS CROSSING SIGN
- NOTE: ALL BROKEN OR CRACKED SIDEWALK MUST BE



(IN FEET) SCALE: 1" = 20'

SITE PLAN

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SHEET NUMBER

ISSUED FOR

DRAWN BY

C-2.0





Chick-fil-A 5200 Buffington Rd Atlanta, GA 30349-2998





KAI BURK PE #28466


FSU#03486 REVISION SCHEDULE NO. DATE DESCRIPTION

CONSULTANT PROJECT #010014-01-218

PERMIT


May 23, 2024

TRAFFIC CIRCULATION LAYOUT APPROVED 5/24/2024

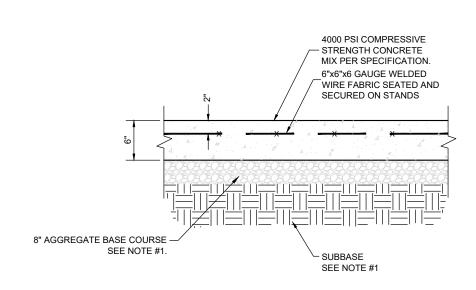

NOTE:


1. GENERAL CONTRACTOR SHALL REFERENCE GEOTECHNICAL REPORT FOR PAVEMENT SECTION REQUIREMENTS.

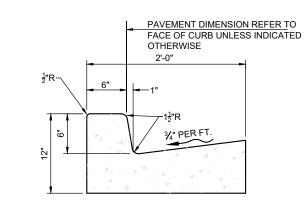

A TYPE "B" CURB & GUTTER

11 CONCRETE CURB & GUTTER

C2.0 NOT TO SCALE

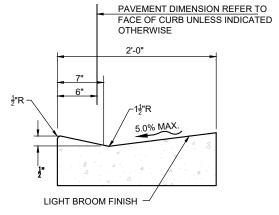

(B) TYPE "H" MOUNTABLE CURB & GUTTER


5 1/2" _____ 10"

NOTES:

1. CONC. FOR CURBING SHALL HAVE A MIN. COMPRESSIVE STRENGTH OF 3,500 PSI @ 28 DAYS

2. CONTRACTION JOINTS @ 1-'0" O.C. TOOLED ¼" (± ½6", -0) WIDE, 1" OR MAX. D/4 DEPTH WHICHEVER IS GREATER. EXPANSION JOINTS @ 40'-0" MAX. UNLESS NOTED OTHERWISE ON PLANS

3. IF NEEDED, DOWEL INTO ADJACENT CONC. SLAB PER THE EXPANSION JOINT DETAIL EXPANSION JOINT DETAIL. 4. GUTTER SLOPE TO MATCH ADJACENT PAVEMENT, TRAVERSE &

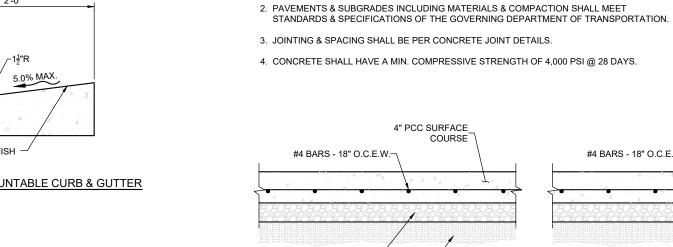


1. DESIGN PER GEOTECH REPORT BY <u>UNITED CONSULTING</u>, DATED <u>11/02/2022</u>.

NOTES:

6" PCC SURFACE_ #4 BARS - 18" O.C.E.W.-\ 6" BASE COURSE PER_/ BASE COURSE PER_ **GEOTECH REPORT GEOTECH REPORT** STABLE SUBGRADE OR_ STABLE SUBGRADE OR _/ COMPACTED SELECT FILL AS REQUIRED PER GEOTECH REPORT COMPACTED SELECT FILL AS REQUIRED PER GEOTECH REPORT **HEAVY DUTY** MEDIUM DUTY


12 CONCRETE PAVEMENTS C4.0 NOT TO SCALE

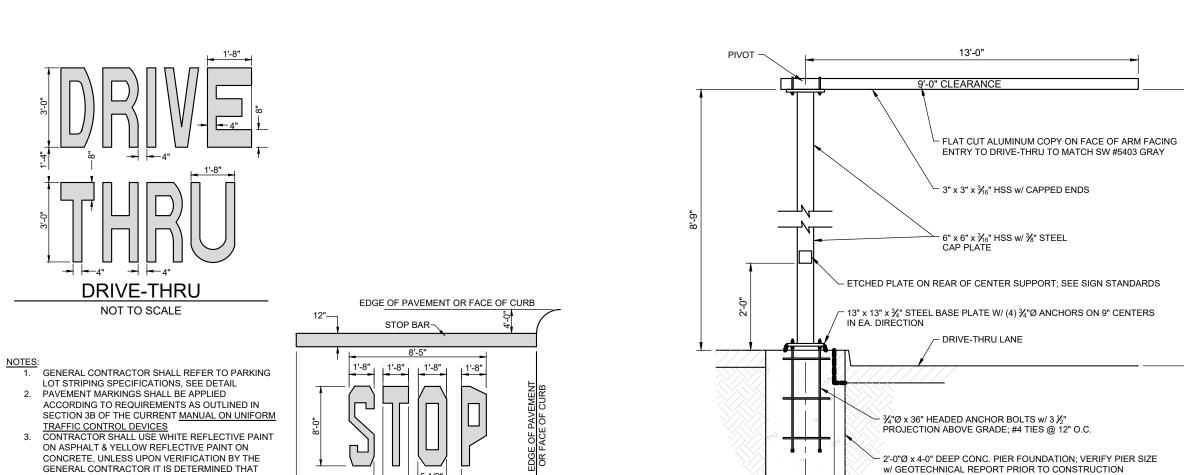

8" FROM BACK OF CURB NOTES:


1. ENTIRE CLEARANCE BAR & HARDWARE TO BE POWDER COATED QPC P-820 MATTE BLACK FINISH 2. CLEARANCE BAR ARM TO ROTATE WHEN STRUCK & RETURN TO ORIGINAL POSITION 3. COORDINATE w/ THE ARCHITECT & STRUCTURAL ENGINEER

5 DRIVE-THRU CLEARANCE BAR C2.0 NOT TO SCALE

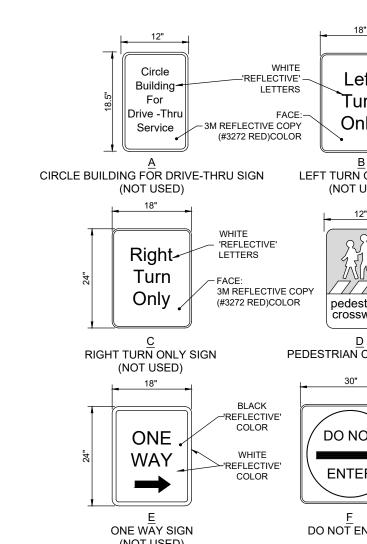

7 DIRECTIONAL SIGNAGE

CONCRETE PAVEMENT DRIVE-THRU LANE NOT TO SCALE

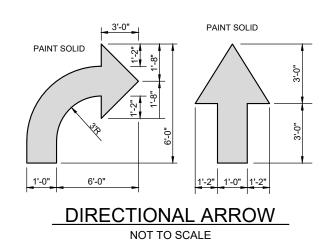


NOTES:

1. GENERAL CONTRACTOR SHALL REFER TO PARKING LOT STRIPING SPECIFICATIONS, SEE DETAIL 2. PAVEMENT MARKINGS SHALL BE APPLIED ACCORDING TO REQUIREMENTS AS OUTLINED IN SECTION 3B OF THE

CURRENT MANUAL ON UNIFORM TRAFFIC CONTROL DEVICES


3. CONTRACTOR SHALL USE WHITE REFLECTIVE PAINT ON ASPHALT & YELLOW REFLECTIVE PAINT ON CONCRETE, UNLESS UPON VERIFICATION BY THE GENERAL CONTRACTOR IT IS DETERMINED THAT LOCAL, STATE, OR ADA CODES DIFFER, IN WHICH CASE THESE CODES SHALL GOVERN.

1 PAVEMENT MARKINGS - 1 C2.0 NOT TO SCALE

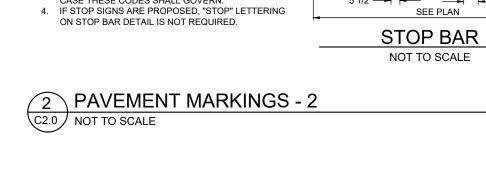


LOCAL, STATE, OR ADA CODES DIFFER, IN WHICH

CASE THESE CODES SHALL GOVERN.

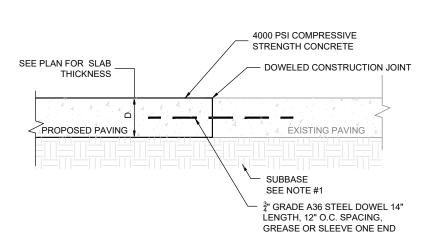


NOTE:
1. GENERAL CONTRACTOR SHALL REFERENCE GEOTECHNICAL REPORT

TRANSVERSE AND 22 LONGITUDINAL DOWELED CONSTRUCTION JOINT C2.0 NOT TO SCALE

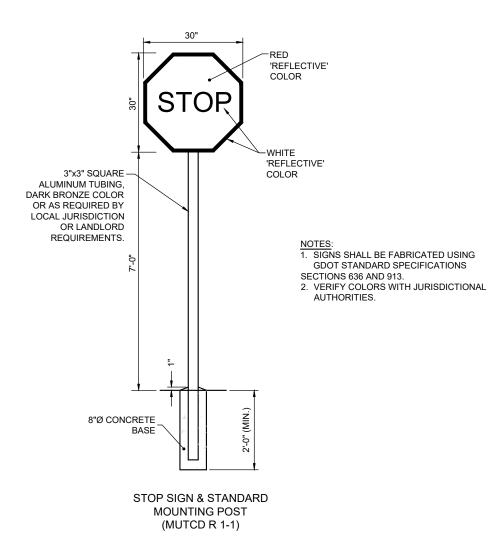

8 STOP SIGN C2.0 NOT TO SCALE



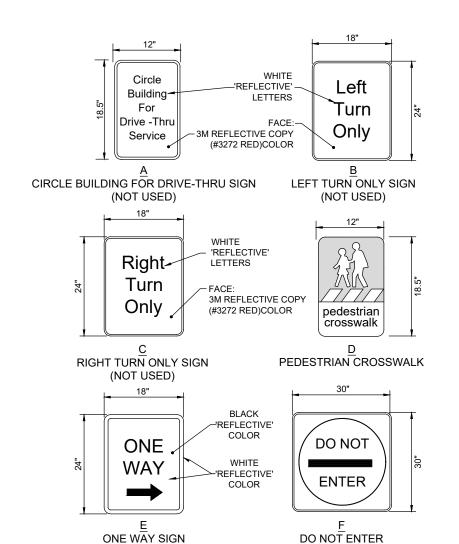

(NOT USED) C2.0 NOT TO SCALE

5200 Buffington Rd Atlanta, GA 30349-2998

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SEAL

FSU#03486 REVISION SCHEDULE NO. DATE DESCRIPTION

CONSULTANT PROJECT #010014-01-218 ISSUED FOR PERMIT DATE May 23, 2024 DRAWN BY

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STANDARD **DETAILS** SHEET NUMBER

/ TRANSPORTATION DESIGN/

7-137 **dPm**

Section 7-4(J)(7) Entrance and Gate Requirements for **Private Ways and Streets**

- 1. All gated communities must include a turnaround for visitors at the gate so that the vehicle does not stand in or back into the City right-of-way.
- 2. Where a single gate is provided, the minimum width shall be 20 feet. For divided streets, the minimum width shall be 12 feet.
- 3. Additional entrance and gate requirements may be required by the Fire

Part 7-4(K) Off-street Parking and Site

This section provides guidance on site design and off-street parking layout. The overall site design shall accommodate all modes of transportation including automobiles, pedestrians, bicyclists, and motorcyclists. To facilitate efficient parking operations, the designer shall also consider the interface of the site with adjacent development areas.

Section 7-4(K)(1) General Provisions

- 1. All sites and off-street parking areas shall be designed to comply with ADA/ PROWAG standards.
- 2. The number of off-street, vehicle, bicycle and motorcycle parking spaces shall be provided as established in the <u>IDO Section 14-16-5-5 Parking and</u>
- 3. Site design shall comply with design requirements and landscape buffers established by the <u>IDO Part 14-16-5 Dimensional Standards</u>.
- 4. Parking and site layout shall be designed such that vehicles do not back into the City right-of-way, except single-family dwellings may back into local streets.

Section 7-4(K)(2) Bicycle Parking


Off-street bicycle parking location, layout and rack options vary widely. The following guidelines shall be considered when placing and designing bicycle parking areas and choosing rack options. Alternative rack design, placement, or installation methods not meeting the guidelines below may be considered and are reviewed on a case-by-case basis by the City Engineer.

- 1. All bicycle racks shall be designed according to the following guidelines: a. The rack shall be a minimum of 30 inches tall and 18 inches wide.
- b. The bicycle frame shall be supported horizontally at two or more places. Comb/toaster racks are not allowed.
- c. The rack shall be designed to support the bicycle in an upright position.
- See the <u>IDO Section 14-16-5-5(E)</u> for additional information. d. The rack allows varying bicycle frame sizes and styles to be attached.
- e. The user is not required to lift the bicycle onto the bicycle rack. f. Each bicycle parking space is accessible without moving another bicycle.
- 2. Bicycle parking spaces shall be located in a well-lit area, visible from and, where feasible, located within 50 feet of the primary pedestrian entrance it serves. Bicycle rack placement shall meet the following placement requirements. (See <u>FIGURE 7.4.115</u> for direction on bicycle stall layout.)

LAST PRINTED: SEPTEMBER 4, 2020

/ TRANSPORTATION DESIGN/

- a. Bicycle parking shall be separated from vehicle parking areas and driveways by a barrier, such as a curb, rail, or bollard, or be located to
- minimize the possibility of vehicles striking parked bicycles. b. Bicycle racks shall be placed in a designated area and shall not infringe upon the width of the required clear pedestrian access route. (See<u>Part</u> 7-4(E) Pedestrian Facilities.)
- c. Bicycle racks shall not be placed directly in front of entrances or in
- locations that impede pedestrian flow. 3. Bicycle racks shall be sturdy and anchored to a concrete pad.
- 4. A 1-foot clear zone around the bicycle parking stall shall be provided. 5. Bicycle parking spaces shall be at least 6 feet long and 2 feet wide.
- FIGURE 7.4.115 Bicycle Parking Stall Layout Options

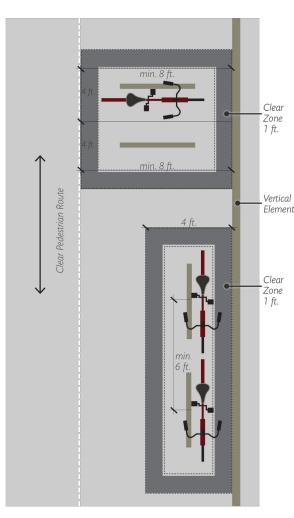


Section 7-4(K)(3) Motorcycle Parking

- 1. Motorcycle parking shall be a minimum of 4 feet wide and 8 feet long. (See <u>TABLE 7.4.77</u> and <u>FIGURE 7.4.116</u>.)
- 2. Motorcycle parking spaces shall be located in a well-lit area that is visible from the primary building entrance on the site.

7-138 **dpm**

LAST PRINTED: SEPTEMBER 4, 2020

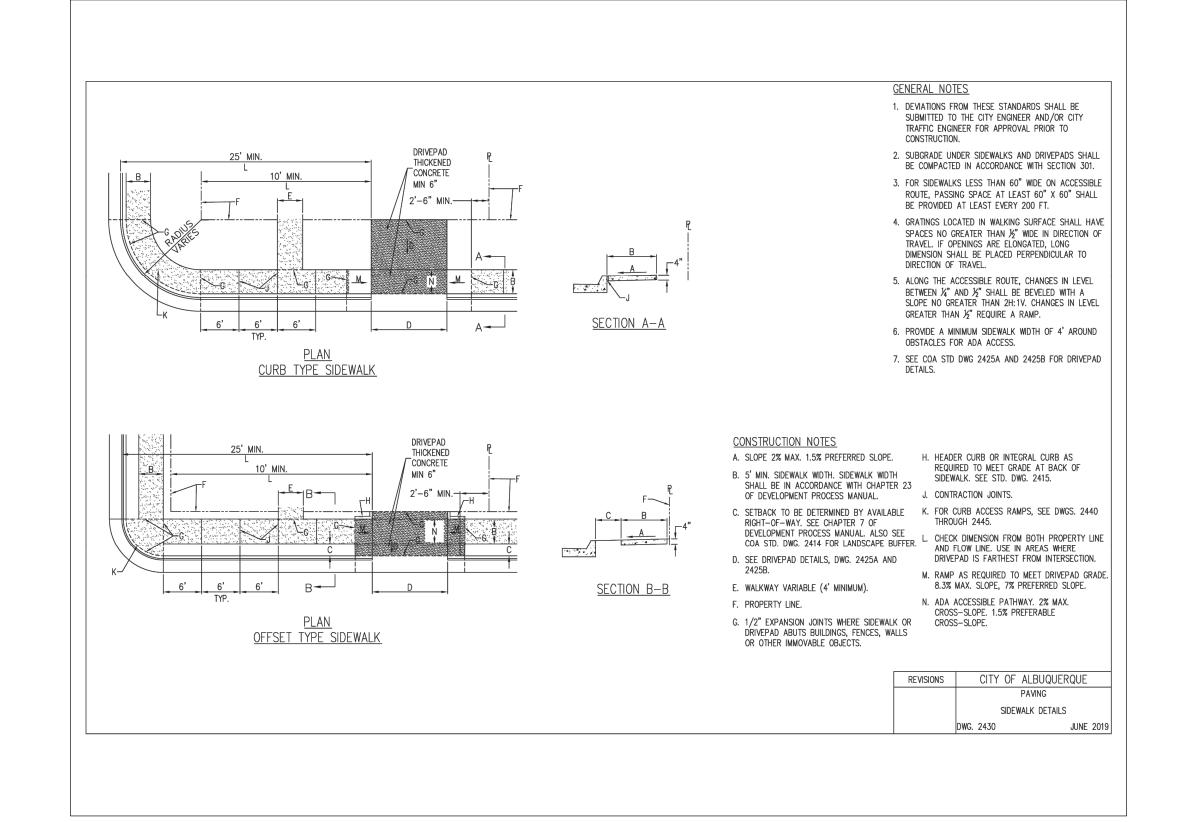







5200 Buffington Rd Atlanta, GA 30349-2998





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REVISION SCHEDULE

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