

# SITE DATA

	SQ. FT.	ACRES	PERCENT
LIMITS OF DISTURBANCE	40,075	0.92	-
TOTAL SITE AREA	42,107	0.97	-
EXISTING PERVIOUS	0	0.00	0.0%
EXISTING IMPERVIOUS	42,107	0.97	100.0%
TOTAL PROPOSED PERVIOUS	8,494	0.20	20.2%
TOTAL PROPOSED IMPERVIOUS	33,613	0.77	79.8%

# **KEYED NOTES:**

- TEMPORARY SILT FENCE, SEE DETAIL ON SWPPP DETAIL SHEET C-10.2
- $\langle 2 \rangle$ TEMPORARY COMPOST FILTER SOCK; SEE DETAIL ON SWPPP DETAIL SHEET C-10.2
- $\langle 3 \rangle$ ROCK SOCKS, SEE DETAIL ON SHEET C-10.1
- 4 VEHICLE TRACKING CONTROL, SEE DETAIL ON SHEET C-10.2
- 5 STABILIZED STAGING AREA
- 6 PORTABLE TOILET

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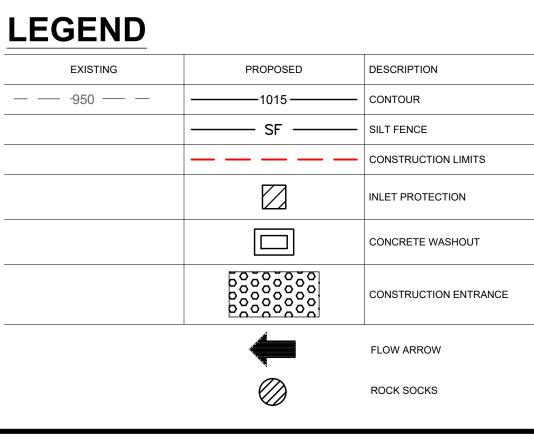
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- OF THE BMPs AND PRIOR TO BEGINNING CONSTRUCTION.
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- BE APPROVED BY THE CITY OF ALBUQUERQUE PRIOR TO REMOVAL OF BMPs AND DISCONTINUATION OF INSPECTIONS.
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# **STORMWATER MANAGEMENT PLANS GENERAL NOTES:**

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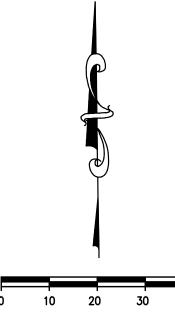
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0 10 20 30 SCALE: 1"=20'



60% REVIEW SET 05/16/22 TCL SUBMISSION 06/09/22 07/01/22 90% REVIEW SET PERMIT REVIEW SET 07/22/22 TCL REVISION 1 09/15/22 TCL / G&D RESPONSE 11/28/22 12/14/22 TCL RESPONSE #3 PT22S UPDATE 01/11/23 ISSUE FOR PERMIT 05/05/23 TCL RESPONSE #4 06/26/23 BUILDING COMMENT 08/16/23 RESPONSE BUILDING COMMENT 02/14/24 RESPONSE


**REVISION/DATE/DESCRIPTION** 

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ms consultants, inc. engineers, architects, planners 2221 Schrock Road Columbus. Ohio 43229-1547 phone 614.898.7100 fax 614.898.7570

### PROJECT

## **PROPOSED PT22S** BUILDING

2141 GIBSON BLVD SE ALBUQUERQUE, NM 87106
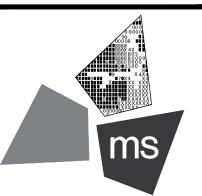
### SHEET TITLE


STORMWATER POLLUTION **PREVENTION PLAN** PHASE I (INITIAL)



	100
CHECKED BY:	JCB
PROJECT NO:	40497-22

DRAWING

C-9.0

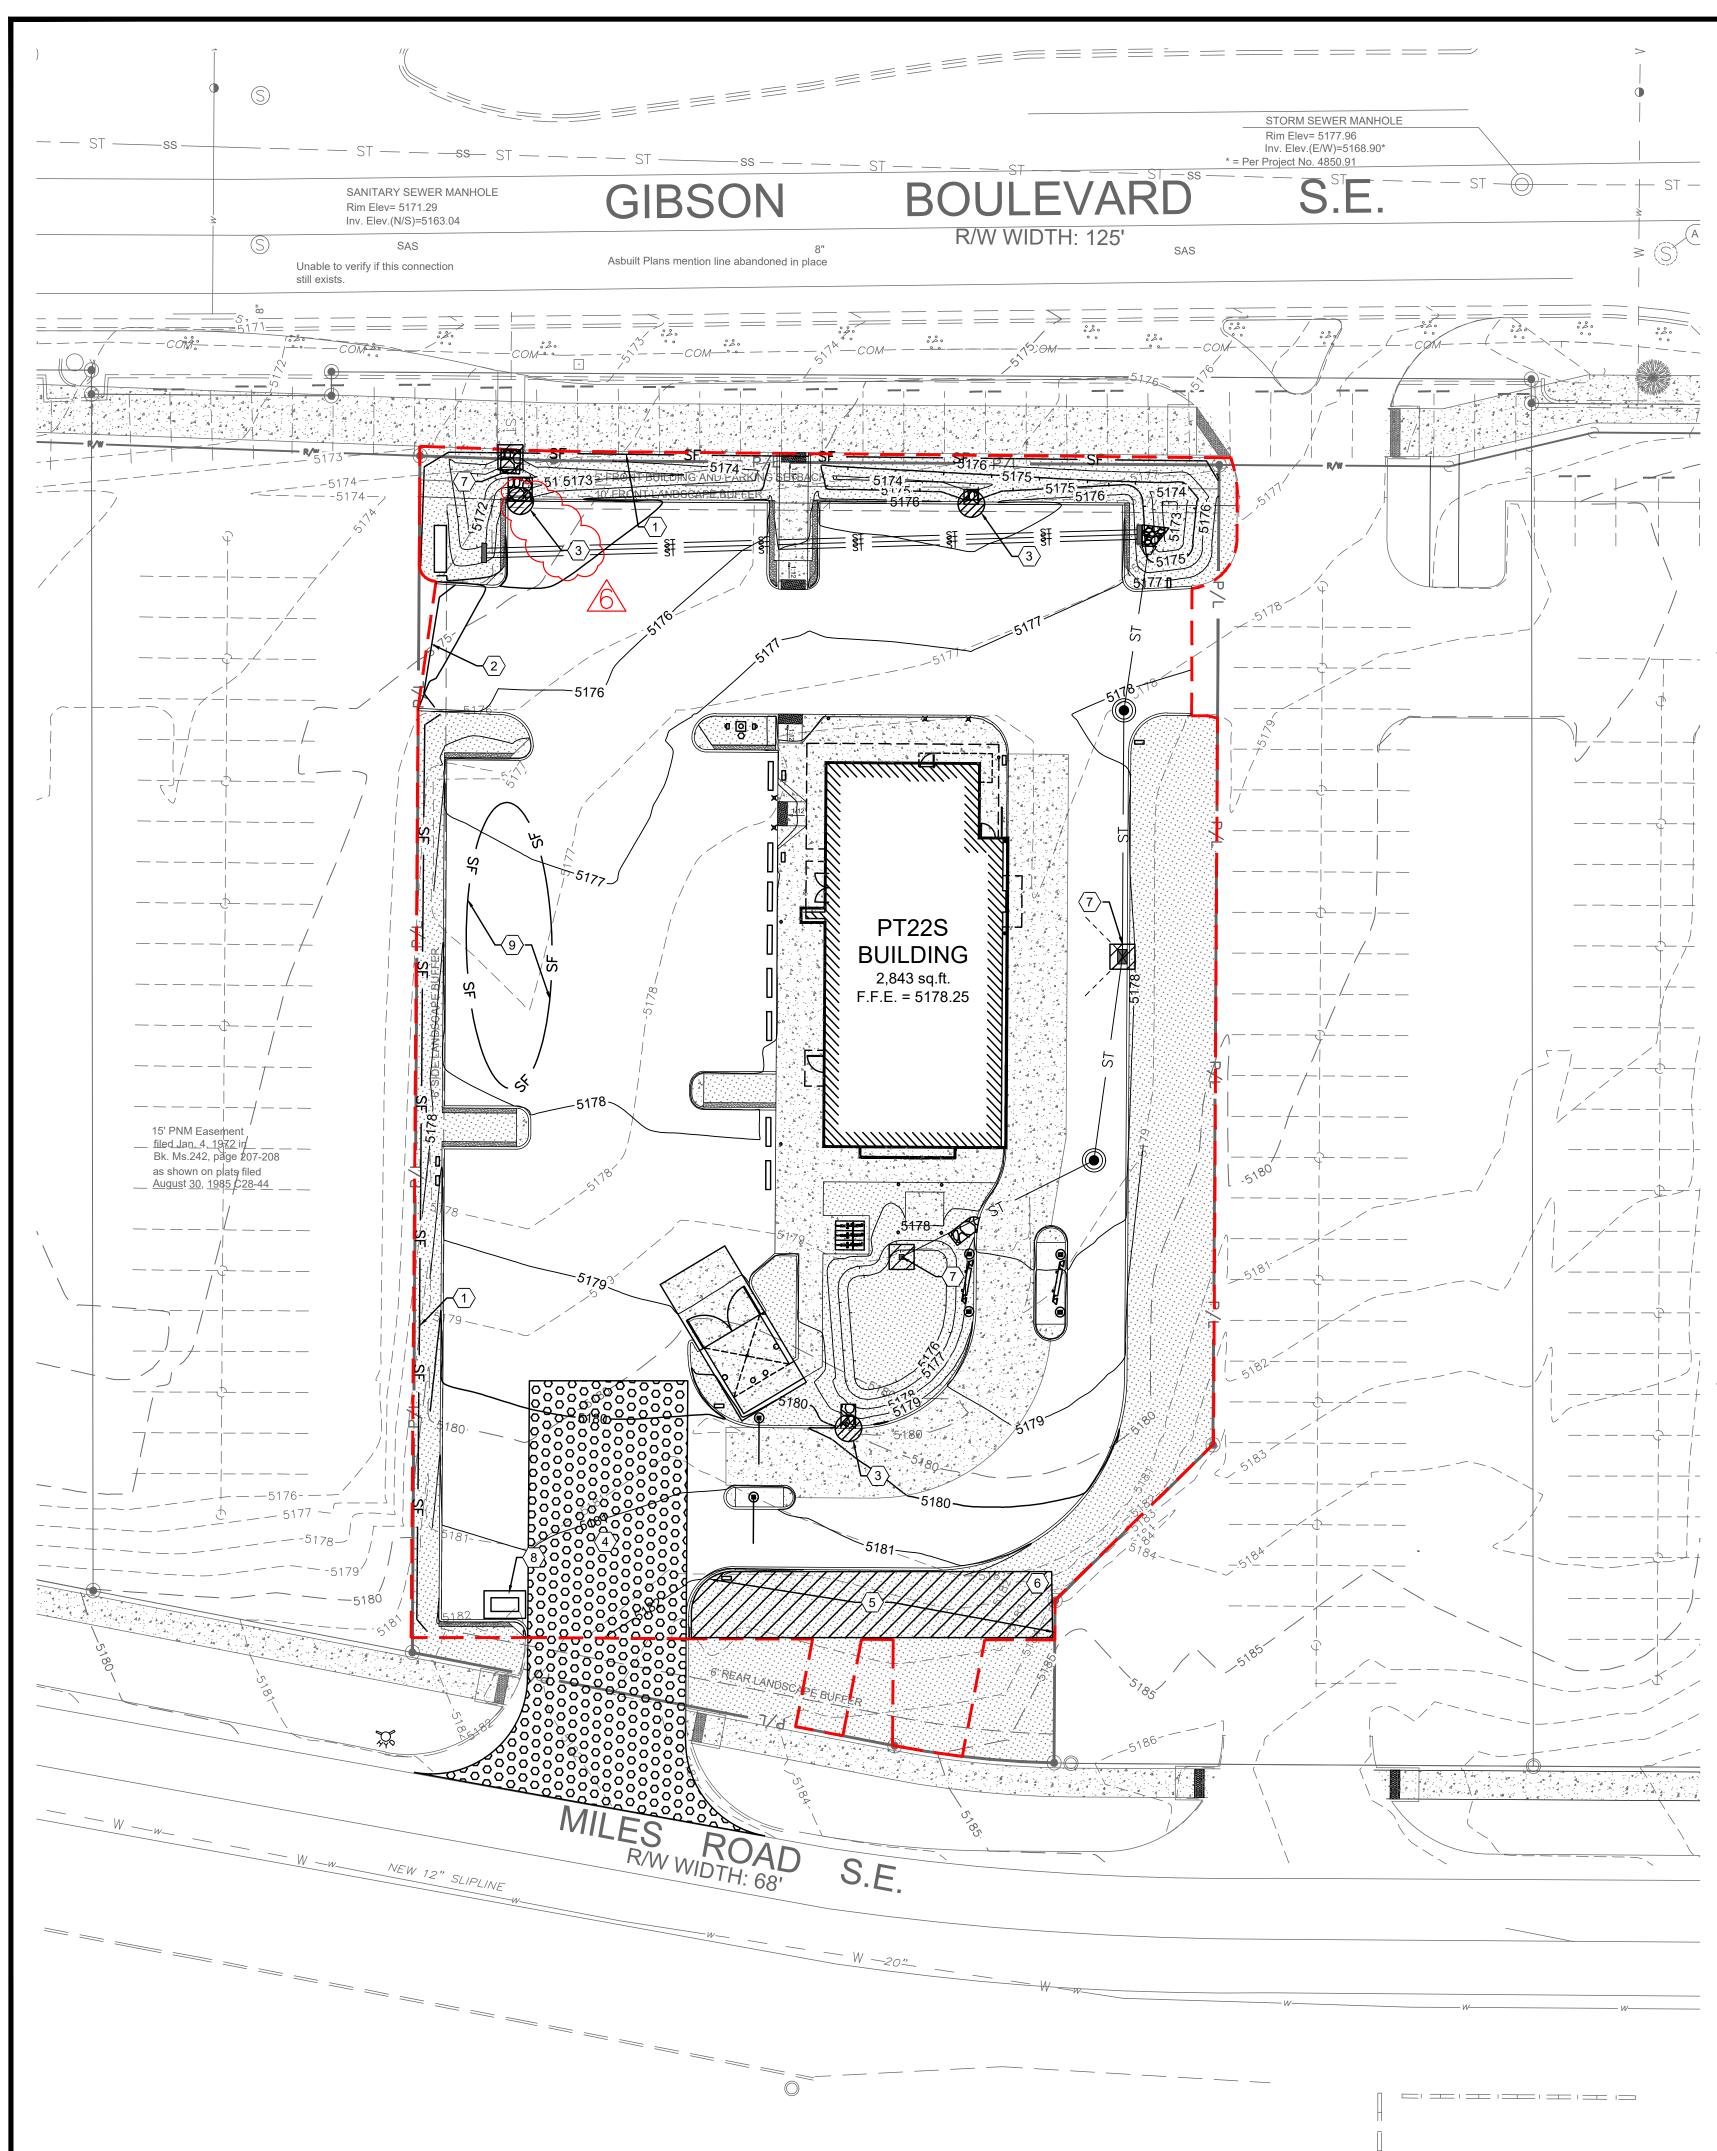

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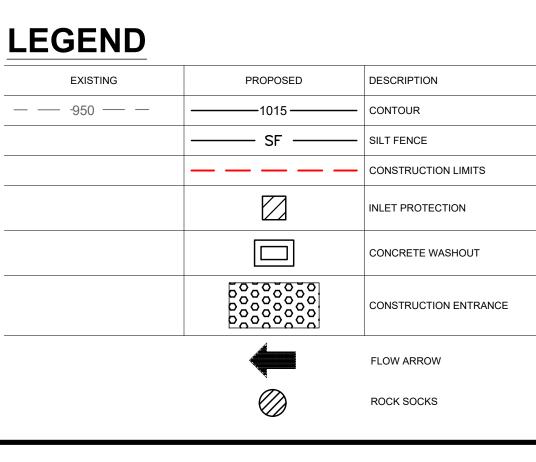
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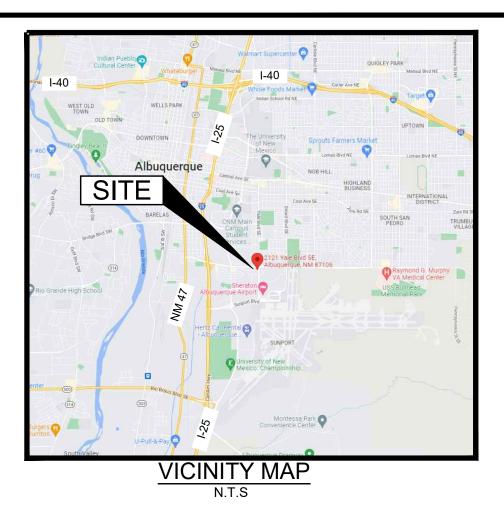
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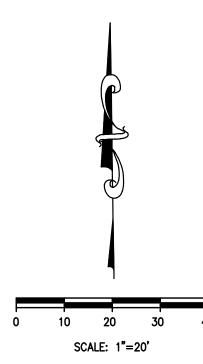
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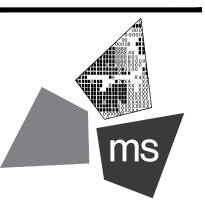
REVISION/DATE/DES	CRIPTION
60% REVIEW SET	05/16/22
TCL SUBMISSION	06/09/22
90% REVIEW SET	07/01/22
PERMIT REVIEW SET	07/22/22
TCL REVISION 1	09/15/22
TCL / G&D RESPONSE	11/28/22
TCL RESPONSE #3	12/14/22
PT22S UPDATE	01/11/23
ISSUE FOR PERMIT	05/05/23
TCL RESPONSE #4	06/26/23
BUILDING COMMENT RESPONSE	08/16/23
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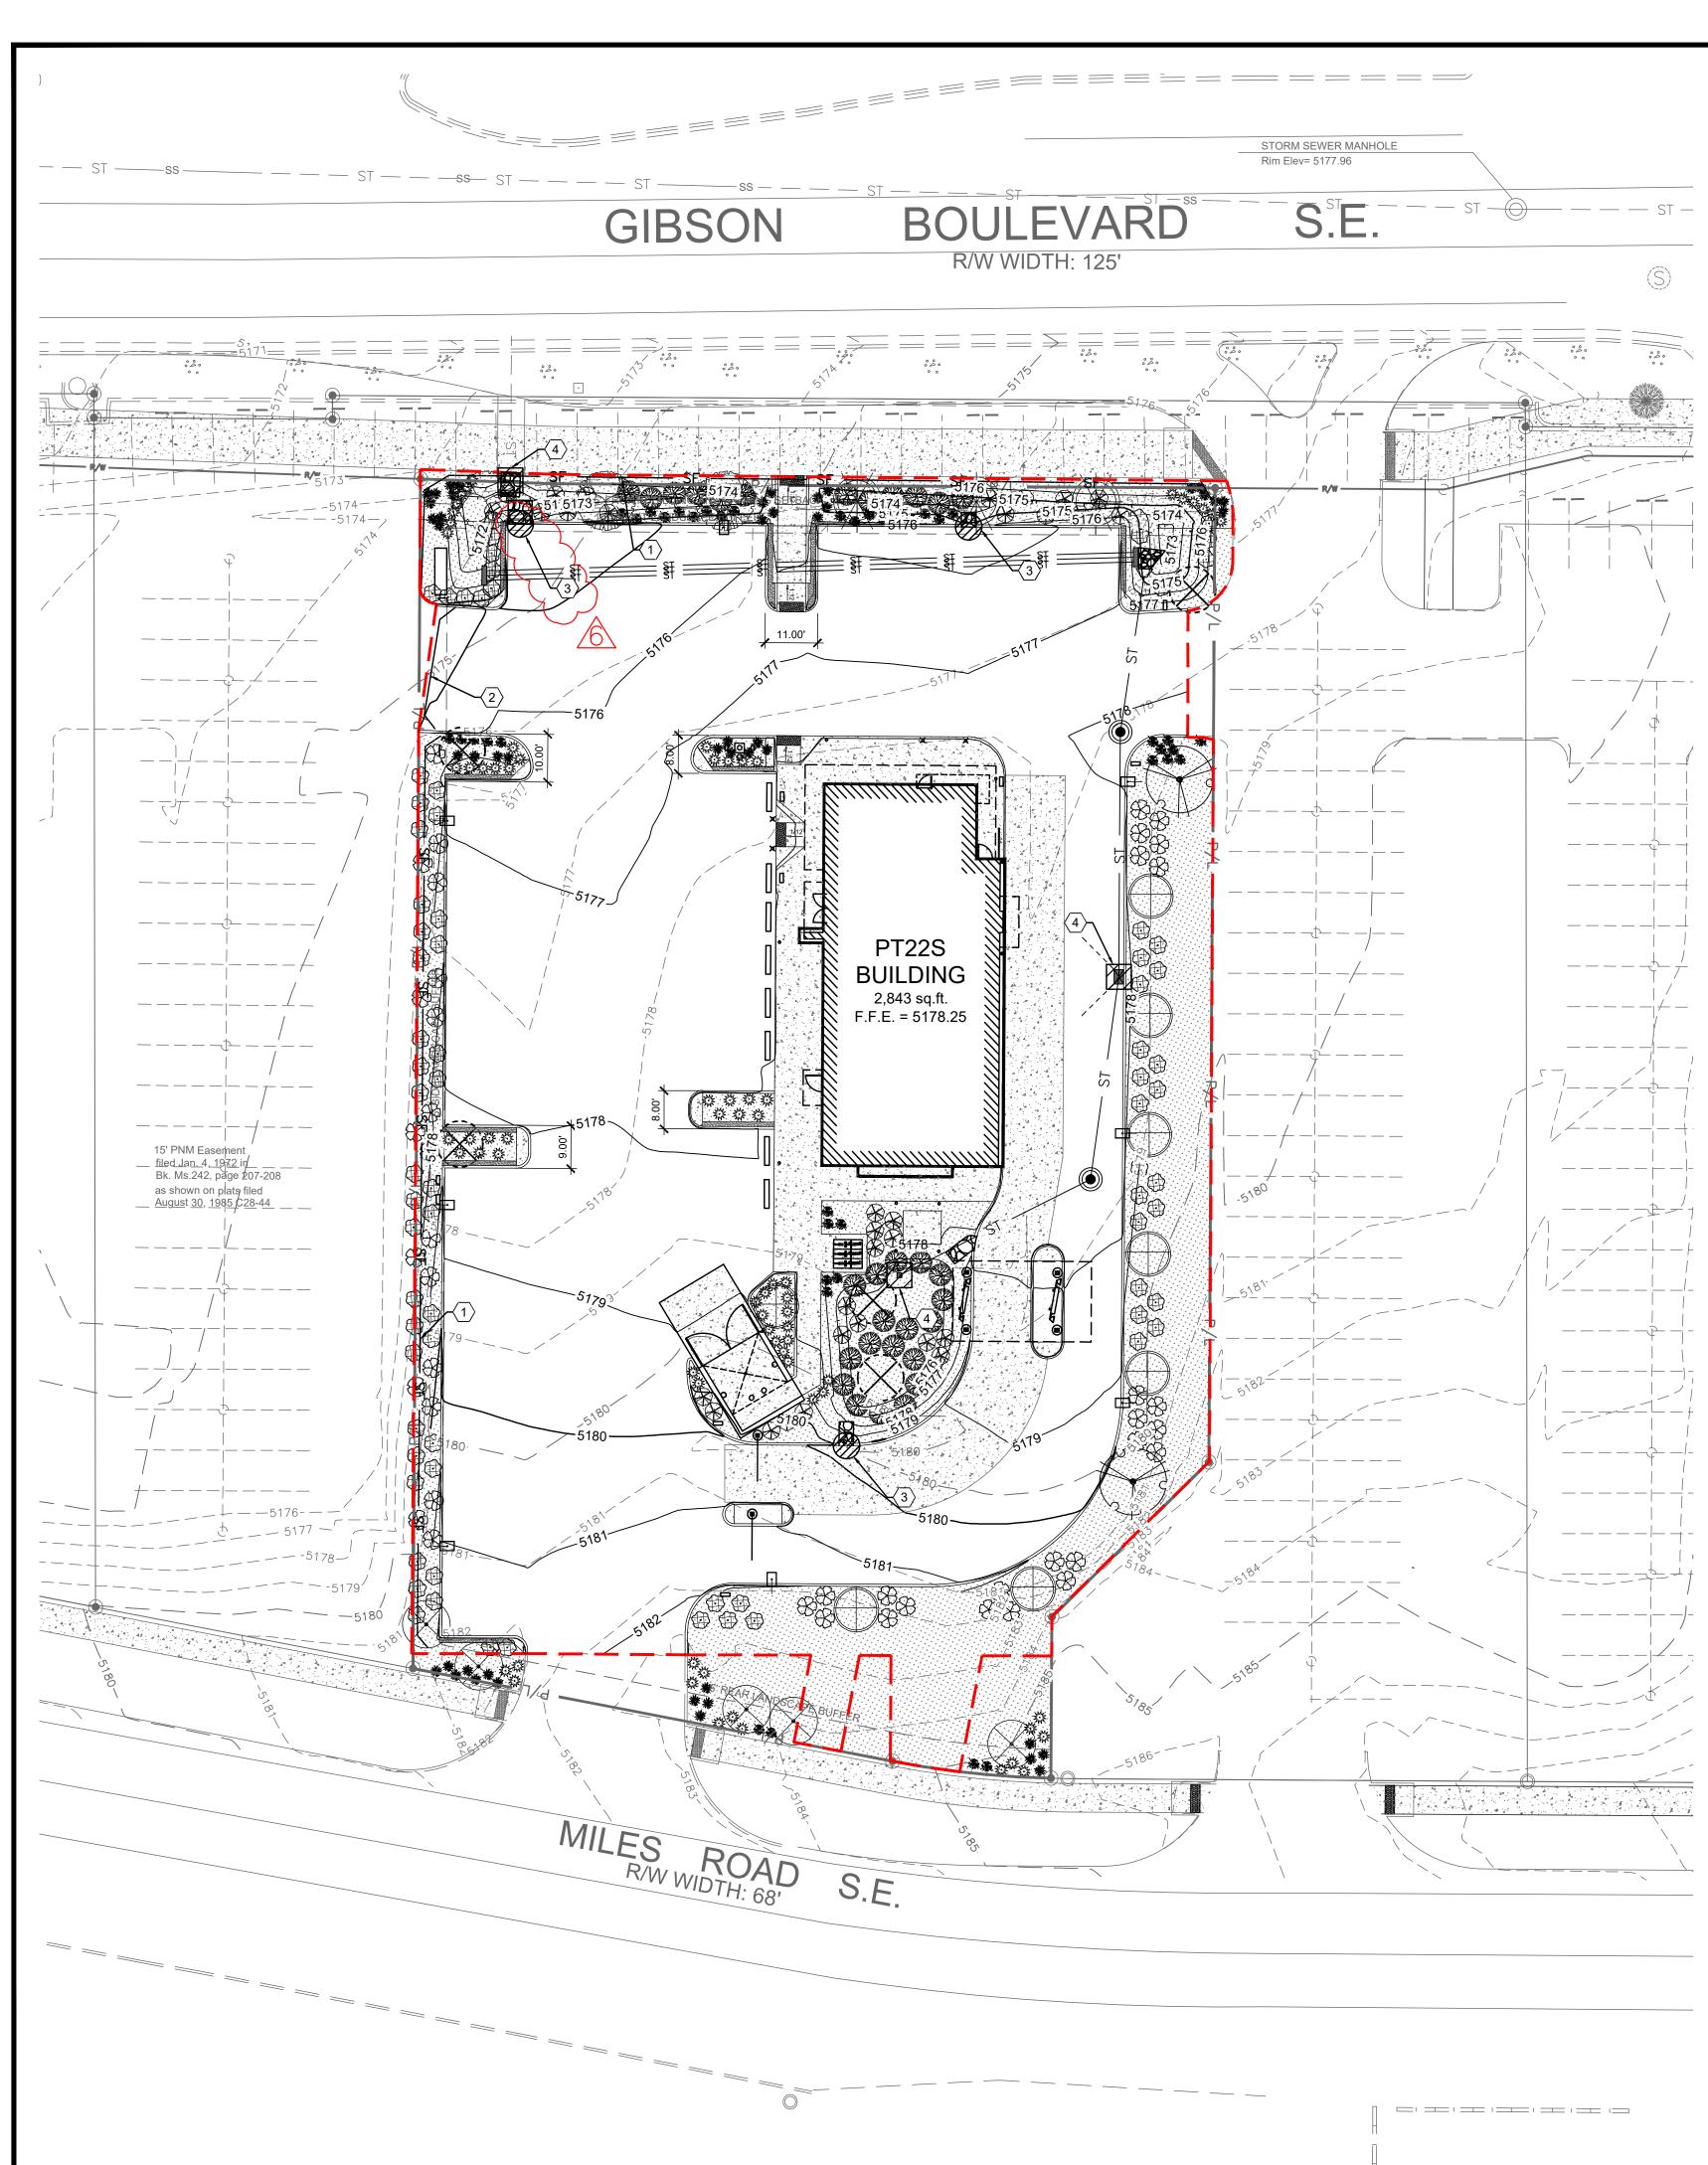
STORMWATER POLLUTION **PREVENTION PLAN** PHASE II (INTERIM)



DRAWN BI:	IDD
CHECKED BY:	JCB
PROJECT NO:	40497-22

DRAWING

C-9.



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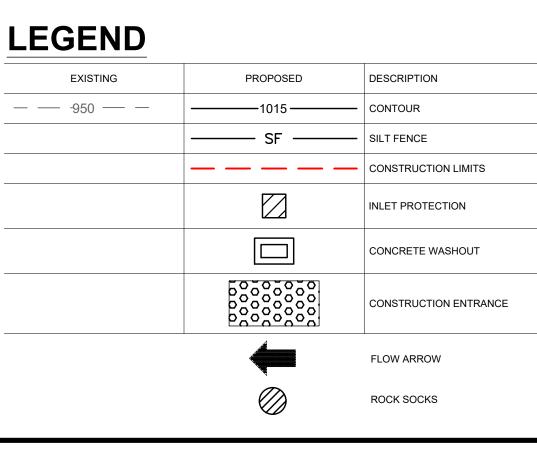
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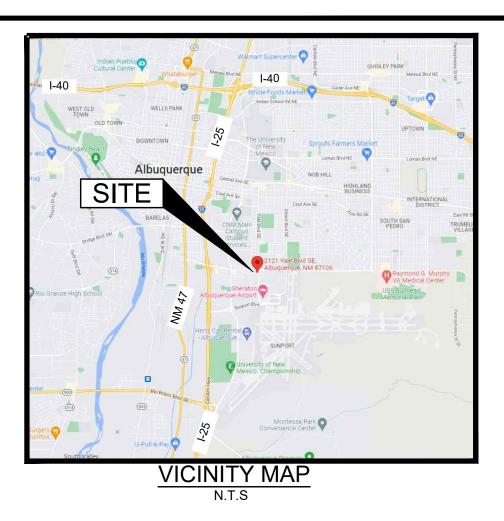
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- PLAN.
- THIS SITE SHALL BE PROPERLY COVERED TO PREVENT LOSS OF THE MATERIAL DURING TRANSPORT ON PUBLIC RIGHTS OF WAY.
- WITHIN 100 FEET OF A DRAINAGEWAY, ADDITIONAL SEDIMENT CONTROLS SUCH AS TEMPORARY DIKES OR SILT FENCE SHALL BE REQUIRED.
- DEBRIS SHALL BE REMOVED FROM A BMP WHEN THE SEDIMENT OR DEBRIS ADVERSELY IMPACTS THE FUNCTIONING OF THE BMP.





### A. ALL EROSION AND SEDIMENT CONTROL (ESC) WORK ON THESE PLANS, EXCEPT AS OTHERWISE STATED OR PROVIDED HEREON SHALL BE PERMITTED, CONSTRUCTED, INSPECTED, AND MAINTAINED IN ACCORDANCE WITH: a.) THE CITY ORDINANCE § 14-5-2-11, THE ESC ORDINANCE, b.) THE EPA's 2022 CONSTRUCTION GENERAL PERMIT (CGP), AND c.) THE CITY OF ALBUQUERQUE CONSTRUCTION BMP

B. ALL BMP''S MUST BE INSTALLED PRIOR TO BEGINNING ANY EARTH MOVING ACTIVITIES EXCEPT AS SPECIFIED HEREON IN THE PHASING PLAN. CONSTRUCTION OF EARTHEN BMP'S SUCH AS SEDIMENT TRAPS, SEDIMENT BASINS, AND DIVERSION BERMS SHALL BE COMPLETED AND INSPECTED PRIOR TO ANY OTHER CONSTRUCTION OR EARTHWORK, SELF-INSPECTION IS REQUIRED AFTER INSTALLATION

SELF-INSPECTIONS - AT A MINIMUM A ROUTINE COMPLIANCE SELF-INSPECTION IS REQUIRED TO REVIEW THE PROJECT FOR COMPLIANCE WITH THE CONSTRUCTION GENERAL PERMIT ONCE EVERY 14 DAYS AND AFTER ANY PRECIPITATION EVENT OF 1/4 INCH OR GREATER UNTIL THE SITE CONSTRUCTION HAS BEEN COMPLETED AND THE SITE DETERMINED AS STABILIZED BY THE CITY. REPORTS OF

HE SITE AND MADE AVAILABLE UPON REQUEST. REPORTS SHOULD INCLUDE RECORDS OF WEED REMOVAL PER CITY ORDINANCE (§ 9-8-1), STERILIZATION, SOIL TEST RESULTS AND RECOMMENDATION, MATERIALS AND MANUFACTURER'S SPECIFICATIONS FOR APPLICATION RATES, ESTIMATED FUNCTIONAL LONGEVITY, METHODS OF APPLICATION, INSPECTION AND MAINTENANCE. THE REDUCED SELF-INSPECTION SCHEDULE IN CGP 4.4.1 APPLIES TO STABILIZED AREA AND ANY DAMAGED OR WORN STABILIZATION MUST BE IDENTIFIED IN THE REPORTS ALONG THE WEED PROBLEMS. CORRECTIVE ACTIONS FOR STABILIZATION SHALL BE DOCUMENTED IN A

BMPs SHALL BE INSPECTED AND MAINTAINED UNTIL ALL DISTURBED AREAS ARE STABILIZED IN ACCORDANCE WITH THE FINAL STABILIZATION CRITERIA (CGP 2.2.14.b). GENERALLY, ALL DISTURBED AREAS, OTHER THAN STRUCTURES AND IMPERVIOUS SURFACES, MUST HAVE UNIFORM PERENNIAL VEGETATION THAT PROVIDES 70 PERCENT OR MORE OF THE COVER PROVIDED BY NATIVE VEGETATION OR SEED THE DISTURBED AREA AND PROVIDE NON-VEGETATIVE MULCH THAT PROVIDES COVER FOR AT LEAST THREE YEARS WITHOUT ACTIVE MAINTENANCE. FINAL STABILIZATION MUST

G. EXISTING SITE RUNOFF DISCHARGES THROUGH SIDEWALK CULVERTS INTO GIBSON BOULEVARD. NO CHANGE TO THE OVERALL DRAINAGE PATTERN IS PROPOSED WITH THIS CONSTRUCTION. OFFSITE

BMP MAINTENANCE NOTE: ALL EROSION AND SEDIMENT CONTROL PRACTICES AND OTHER PROTECTIVE MEASURES IDENTIFIED IN THE SWMP MUST BE MAINTAINED IN EFFECTIVE OPERATION CONDITION. PROPER SELECTION AND INSTALLATION OF BMPs AND IMPLEMENTATION OF COMPREHENSIVE INSPECTION AND MAINTENANCE PROCEDURES IN ACCORDANCE WITH THE SWMP, SHOULD BE ADEQUATE TO MEET THIS CONDITION. BMPs THAT ARE NOT ADEQUATELY MAINTAINED IN ACCORDANCE WITH GOOD ENGINEERING, HYDROLOGIC AND POLLUTION CONTROL PRACTICES, INCLUDING REMOVAL OF

GENERAL CONTRACTOR MUST COORDINATE WORK WITH UTILITY COMPANY AND CITY PRIOR TO BEGINNING WORK AND IS RESPONSIBLE FOR ALL MATERIALS, LABOR, REPAIRS, ETC. TO COMPLETE WORK

SURVEYOR TO OBTAIN AUTOCAD FILE FROM ENGINEER AND VERIFY ALL HORIZONTAL CONTROL DIMENSIONING PRIOR TO CONSTRUCTION STAKING. SURVEYOR MUST VERIFY ALL BENCHMARK, BASIS OF BEARING AND DATUM INFORMATION TO ENSURE IMPROVEMENTS WILL BE AT THE SAME HORIZONTAL AND VERTICAL LOCATIONS SHOWN ON THE DESIGN CONSTRUCTION DRAWINGS. PRIOR TO

M. GENERAL CONTRACTOR SHALL PROTECT ALL EXISTING SURVEY MONUMENTS. THE GENERAL CONTRACTOR SHALL HAVE LICENSED SURVEYOR REPLACE ANY DAMAGED OR DISTURBED MONUMENTS AT

GENERAL CONTRACTOR RESPONSIBLE FOR AS-BUILT DRAWINGS, TESTS, REPORTS AND/OR ANY OTHER CERTIFICATES OR INFORMATION AS REQUIRED FOR ACCEPTANCE OF WORK FROM CITY, UTILITY

ACCUMULATE IN, THE FLOW LINES AND PUBLIC RIGHTS OF WAYS OF THE CITY AS A RESULT OF CONSTRUCTION ACTIVITIES ASSOCIATED WITH THIS SITE DEVELOPMENT OR CONSTRUCTION PROJECT

ADDITIONAL EROSION AND SEDIMENT CONTROL MEASURES MAY BE REQUIRED OF THE OWNER AND HIS OR HER AGENTS DUE TO UNFORESEEN EROSION PROBLEMS OR IF THE SUBMITTED PLAN DOES NOT FUNCTION AS INTENDED. THE REQUIREMENTS OF THIS PLAN SHALL BE THE OBLIGATION OF THE PERMIT HOLDER UNTIL SUCH TIME AS THE PLAN IS PROPERLY COMPLETED AND THE PERMIT IS


THE CONTRACTOR SHALL PREVENT SEDIMENT, DEBRIS AND ALL OTHER POLLUTANTS FROM ENTERING THE STORM SEWER SYSTEM DURING ALL DEMOLITION, EXCAVATION, TRENCHING, BORING,

4. THE CONTRACTOR SHALL LOCATE, INSTALL, AND MAINTAIN ALL EROSION CONTROL AND WATER QUALITY "BEST MANAGEMENT PRACTICES" AS INDICATED IN THE APPROVED STORMWATER MANAGEMENT

THE DEVELOPER, GENERAL CONTRACTOR, GRADING CONTRACTOR AND/OR THEIR AUTHORIZED AGENTS SHALL ENSURE THAT ALL LOADS OF CUT AND FILL MATERIAL IMPORTED TO OR EXPORTED FROM

SOILS THAT WILL BE STOCKPILED FOR MORE THAN 30 DAYS SHALL BE PROTECTED FROM WIND AND WATER EROSION WITHIN 14 DAYS OF STOCKPILE CONSTRUCTION. IF STOCKPILES ARE LOCATED

APPROVED EROSION AND SEDIMENT CONTROL BEST MANAGEMENT PRACTICES SHALL BE MAINTAINED AND KEPT IN GOOD REPAIR OF THE DURATION OF THIS PROJECT. ACCUMULATED SEDIMENT AND

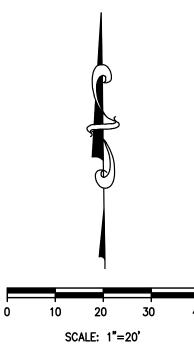


Know what's **below**. **Call** before you dig.

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	TCL SUBMISSION	06/09/22
	90% REVIEW SET	07/01/22
	PERMIT REVIEW SET	07/22/22
	TCL REVISION 1	09/15/22
	TCL / G&D RESPONSE	11/28/22
	TCL RESPONSE #3	12/14/22
	PT22S UPDATE	01/11/23
	ISSUE FOR PERMIT	05/05/23
	TCL RESPONSE #4	06/26/23
^	BUILDING COMMENT RESPONSE	08/16/23
3	BUILDING COMMENT RESPONSE	02/14/24

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ms consultants, inc. engineers, architects, planners 2221 Schrock Road Columbus, Ohio 43229-1547 phone 614.898.7100 fax 614.898.7570

### PROJECT

## **PROPOSED PT22S** BUILDING

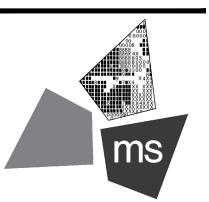2141 GIBSON BLVD SE ALBUQUERQUE, NM 87106

### SHEET TITLE

STORMWATER POLLUTION **PREVENTION PLAN** PHASE III (FINAL)



CHECKED BY:	JCB
PROJECT NO:	40497-22

DRAWING

C-9.2

PROJECT NAME AND LOCATION WHATABURGER		OTHER SEDIMENT AN
2121 YALE BLVD. SE, ALBUQUERQUE, NM 87106 OWNER NAME AND ADDRESS		TEMPORARY ER     WILL BE LEFT ID
WHATABURGER		PERMANENT ER     1 YEAR OR AT FI
300 CONCORD PLAZA DR. SAN ANTONIO, TX 78216		SEDIMENT CONT
PHONE: (210) 476-6614 CONTACT: ABRAHAM VAZQUEZ		ADDITIONAL BMP'S
EMAIL: avazquez@wbhq.com		OPEN BURNING: NO I AS TIRES, CARS, AUT
<u>SITE CONTACT</u> WHATABURGER		RESTRICTED AREAS
300 CONCORD PLAZA DR. SAN ANTONIO, TX 78216		1. WITHIN CORPOR
PHONE: (210) 476-6614		2. WITHIN 1,000 FE
CONTACT: ABRAHAM VAZQUEZ EMAIL: avazquez@wbhq.com		3. WITHIN A ONE M
GENERAL SCOPE OF PROJECT		OUTSIDE THE RESTR OFF THE PROPERTY
THIS PROJECT WILL CONSIST OF A RESTAURANT AND THE CONSTR ASSOCIATED DRAINAGE FACILITIES AND OTHER MISCELLANEOUS S		ACTIVITIES: HEATING HEATING OR WARMT
NATURE OF CONSTRUCTION ACTIVITY (CHECK ALL THAT APPLY)		LANDSCAPE WASTES
SUBDIVISION COMMERCIAL X		EPA), AND AGRICULT
INDUSTRIAL		DUST CONTROL/SUP
OTHER		DISCHARGE TO WATI MUST BE OBSERVED
SOIL TYPES		SHORT TERM FOREC
		AIR PERMITTING REC
CONSTRUCTION SITE ESTIMATES		ACTIVITIES ASSOCIA CONCRETE BATCH P
TOTAL SITE AREA: CONSTRUCTION SITE AREA TO BE DISTURBED:	<u>0.97 AC.</u> 0.92 AC.	SPECIFIC MISSOURI
PERCENTAGE IMPERVIOUS AREA BEFORE CONSTRUCTION: RUNOFF COEFFICIENT BEFORE CONSTRUCTION:	<u>100.00%</u> 0.90	EPA FOR ALL COMME
PERCENTAGE IMPERVIOUS AREA AFTER CONSTRUCTION: RUNOFF COEFFICIENT AFTER CONSTRUCTION:	73.60% 0.74	WASTE DISPOSAL: TI
	0.74	BOUNDARIES DURING OF BY THE CONTRAC
RECEIVING WATERS		AND CONSTRUCTION
CONSTRUCTION SEQUENCE		OFFSITE VEHICLE TR ROADS SHALL BE RE
THE ORDER OF MAJOR ACTIVITIES WILL BE AS FOLLOWS:		CONTROL EROSION.
<ol> <li>BEFORE AND SITE GRADING ACTIVITIES BEGIN         <ul> <li>a. INSTALL PERIMETER SILT FENCES</li> </ul> </li> </ol>		CONTROL SEDIMENT
b. INSTALL INLET PROTECTION ON EXISTING INLETS		SANITARY WASTE: TH COLLECTED OR EMP
c. CONSTRUCT TEMPORARY CONSTRUCTION ENTRANCE		
3. BEGIN SITE GRADING AND TOPSOIL STRIPPING a. ESTABLISH TOPSOIL STOCKPILE WITHIN SILT FENCE PERIM	IETER	<u>FERTILIZERS AND PE</u> MANUFACTURER. TH
b. STABILIZE DENUDED AREAS AND STOCKPILES WITHIN 14 D		SPECIFICATION OR M NOT ANTICIPATED FO
c. INSTALL EROSION CONTROL MATTING AT LOCATIONS INDIC		MAINTENANCE
<ol> <li>INSTALL UTILITIES, SANITARY SEWERS, WATER SERVICES AND</li> <li>BEGIN CONSTRUCTION OF BUILDING FOUNDATION AND STRUCTION</li> </ol>		
7. INSTALL CURBS, PREPARE PAVEMENT SUBGRADE AND PROVID		THE CONTRACTOR W THE REMOVAL OF TH
<ol> <li>PAVE AREAS AND EXTERIOR BUILDING CONSTRUCTION.</li> <li>FINAL GRADING AND PERMANENT SEEDING OF THE NON-PAVEL</li> </ol>	DAREAS OF THE SITE WITHIN 7 DAYS OF FINISHING FINAL	THE CONTRACTOR S
GRADE 10. ONCE 70% VEGETATIVE COVERAGE IS ACHIEVED, REMOVE ERC	DSION PROTECTION.	AND FOLLOWING RAI SHALL BE REQUIRED
		SWPPP AMENDMENT
POTENTIAL SOURCES OF POLLUTION CONCRETE		AND SEDIMENT CON
DETERGENTS WOOD		A. PROJECT REVIE
FERTILIZERS		B. PROVIDE AND M
PAINTS (ENAMEL AND LATEX) CLEANING SOLVENTS		C. REVIEW STABILIZ
PETROLEUM BASED PRODUCTS		CONTROLS AS N BARE SPOTS AN
EROSION AND SEDIMENT CONTROLS		D. ONCE HEALTHY
BMP DESCRIPTION: MAINTENANCE AND INSPECTION:	CLEARING AND GRUBBING AS NEEDED	HEIGHT OF THE
REFERENCE:	TECHNICAL SPECIFICATION	E. REVIEW STRUCT
BMP DESCRIPTION:	DUST CONTROL	NECESSARY. BU NECESSARY ANI
MAINTENANCE AND INSPECTION: REFERENCE:	AS NEEDED E&S DETAILS	
		F. AN INSPECTION OF 0.5 INCHES O
BMP DESCRIPTION: MAINTENANCE AND INSPECTION:	TEMPORARY SEEDING AND MULCHING WEEKLY AND AFTER HEAVY RAIN	ANY AMENDMEN
REFERENCE:	E&S DETAILS	G. IF THE CONTRAC CONSTRUCTION
BMP DESCRIPTION:	PERMANENT SEEDING AND MULCHING	BASIS AND CON
MAINTENANCE AND INSPECTION: REFERENCE:	WEEKLY AND AFTER HEAVY RAIN E&S DETAILS	DISCHARGE VOL
		INSPECTIONS QUALIFIED PERSONN
BMP DESCRIPTION: MAINTENANCE AND INSPECTION:	CONSTRUCTION ENTRANCE AS NEEDED	DISTURBED AREAS C STORAGE OF MATER
REFERENCE:	E&S DETAILS	POLLUTANTS ENTER
		AND SEDIMENT CON AND MAINTENANCE
		OF WATER OR GREA
POST CONSTRUCTION BMP'S		ALLOWABLE NON-ST
GREEN SPACE		ALLOWABLE NON-ST
		THEM FROM BECOMI 1. WATERS USED T
		<ol> <li>WATERS USED T</li> <li>WATER USED TC</li> </ol>
		<ol> <li>WATERS USED T</li> <li>WATER USED TO</li> <li>POTABLE WATER</li> <li>ROUTINE EXTER</li> </ol>
		<ol> <li>WATERS USED T</li> <li>WATER USED TC</li> <li>POTABLE WATEF</li> </ol>
		<ol> <li>WATERS USED T</li> <li>WATER USED TO</li> <li>POTABLE WATER</li> <li>ROUTINE EXTER</li> <li>PAVEMENT WAS ALL SPILLED MA</li> <li>UNCONTAMINAT</li> </ol>
		<ol> <li>WATERS USED T</li> <li>WATER USED TO</li> <li>POTABLE WATER</li> <li>ROUTINE EXTER</li> <li>PAVEMENT WAS ALL SPILLED MA</li> </ol>
		<ol> <li>WATERS USED T</li> <li>WATER USED TC</li> <li>POTABLE WATER</li> <li>POTABLE WATER</li> <li>ROUTINE EXTER</li> <li>PAVEMENT WAS ALL SPILLED MAT</li> <li>UNCONTAMINAT</li> <li>UNCONTAMINAT</li> </ol>

OSION CONTROLS WILL BE APPLIED PRIOR TO ONSET OF WINTER WEATHER FOR DISTURBED AREAS THAT LE OVER WINTER.

OSION CONTROLS WILL BE APPLIED WITHIN 7 DAYS FOR DISTURBED AREAS REMAINING DORMANT FOR OVER NAL GRADE. FROL DEVICES WILL BE IMPLEMENTED FOR ALL AREAS REMAINING DISTURBED OVER 7 DAYS.

MATERIALS MAY BE BURNED WHICH CONTAIN RUBBER, GREASE, ASPHALT, OR PETROLEUM PRODUCTS SUCH TO PARTS, PLASTICS OR PLASTIC COATED WIRE. OPEN BURNING IS NOT ALLOWED IN RESTRICTED AREAS. ARE DEFINED AS:

RATION LIMITS ET OF A MUNICIPAL CORPORATION

MILE ZONE OUTSIDE OF A CORPORATION OF 10,000 OR MORE

RICTED AREA, NO OPEN BURNING CAN TAKE PLACE WITHIN 1,000 FEET OF AN INHABITED BUILDING LOCATED WHERE THE FIRE IS SET. OPEN BURNING IS PERMISSIBLE IN A RESTRICTED AREA FOR THE FOLLOWING G TAR, WELDING AND ACETYLENE TORCHES, SMUDGE POTS AND SIMILAR OCCUPATIONAL NEEDS, AND TH FOR OUTDOOR BARBEQUES. OUTSIDE OF RESTRICTED AREAS, OPEN BURNING IS PERMISSIBLE FOR S (PLANT MATERIAL), LAND-CLEARING WASTES (PLANT MATERIAL, WITH PRIOR WRITTEN PERMISSION FROM TURAL WASTES (MATERIAL GENERATED BY CROP, HORTICULTURAL, OR LIVESTOCK PRODUCTION PRACTICES.

PRESSANTS: DUST CONTROL IS REQUIRED TO PREVENT NUISANCE CONDITIONS. DUST CONTROLS MUST BE CE WITH MANUFACTURER'S SPECIFICATION AND NOT BE APPLIED IN A MANNER, WHICH WOULD RESULT IN A ERS OF THE STATE. ISOLATION DISTANCES FROM BRIDGES, CATCH BASINS, AND OTHER DRAINAGE WAYS . APPLICATION (EXCLUDING WATER) MAY NOT OCCUR WHEN PRECIPITATION IS IMMINENT AS NOTED IN THE CAST. USED OIL MAY NOT BE APPLIED FOR DUST CONTROL.

<u>UIREMENTS:</u> ALL CONTRACTORS AND SUB CONTRACTORS MUST BE MADE AWARE THAT CERTAIN TED WITH CONSTRUCTION WILL REQUIRE AIR PERMITS. ACTIVITIES INCLUDING BUT NOT LIMITED TO MOBILE PLANTS, MOBILE ASPHALT PLANTS, CONCRETE CRUSHERS, LARGE GENERATORS, ETC., WILL REQUIRE EPA AIR PERMITS FOR INSTALLATION AND OPERATION. THESE ACTIVITIES MUST SEE AUTHORIZATION FROM NG OF MISSOURI EPA. NOTIFICATION FOR RESTORATION AND DEMOLITION MUST BE SUBMITTED TO MISSOURI ERCIAL SITES TO DETERMINE IF ASBESTOS CORRECTIVE ACTIONS ARE REQUIRED.

HE CONTRACTOR SHALL PROVIDE LITTER CONTROL AND COLLECTION OF MATERIALS WITHIN THE PROJECT G CONSTRUCTION. ALL FERTILIZER, HYDROCARBON, OR OTHER CHEMICAL CONTAINERS SHALL BE DISPOSED CTOR IN ACCORDANCE WITH THE EPA'S STANDARD PRACTICES. NO SOLID MATERIAL INCLUDING BUILDING N MATERIAL SHALL BE DISPOSED OF, DISCHARGED OR BURIED ONSITE.

ACKING: LOADED HAUL TRUCKS SHALL BE COVERED WITH A TARPAULIN. EXCESS DIRT MATERIAL ON THE MOVED IMMEDIATELY. HAULING ON UNPAVED SURFACES SHALL BE MONITORED TO MINIMIZE DUST AND HAUL ROADS SHALL BE WATERED OR OTHER CONTROLS PROVIDED AS NECESSARY TO REDUCE DUST AND

HE CONTRACTOR SHALL PROVIDE PORTABLE SANITARY WASTE FACILITIES. THESE FACILITIES SHALL BE PTIED BY A LICENSED SANITARY WASTE MANAGEMENT CONTRACTOR AS REQUIRED BY STATE REGULATIONS.

STICIDES: FERTILIZER SHALL BE APPLIED AT A RATE SPECIFIED BY THE SPECIFICATIONS OR THE E APPLICATION OF FERTILIZERS SHALL BE ACCOMPLISHED IN A MANNER AS DESCRIBED BY THE MANUFACTURER TO ENSURE THE PROPER INSTALLATION AND TO AVOID OVER FERTILIZING. PESTICIDES ARE OR THIS PROJECT.

WILL BE RESPONSIBLE FOR MAINTENANCE AND REPAIRS OF EROSION AND SEDIMENT CONTROL DEVICES AND HE EROSION AND SEDIMENT CONTROL DEVICES AFTER THE NOTICE OF TERMINATION IS EXECUTED.

HALL REVIEW THE PROJECT AND ALL EROSION AND SEDIMENT CONTROLS ON A DAILY BASIS AND DURING INFALL EVENTS. AN INSPECTION FORM HAS BEEN PROVIDED IN THE SPECIFICATIONS. THE CONTRACTOR ) TO KEEP A LOG OF ALL THE DAILY INSPECTION REPORTS, GRADING AND STABILIZATION ACTIVITIES, AND S AT THE SITE. THE FOLLOWING PRACTICES WILL BE IMPLEMENTED TO MAINTAIN AND MONITOR EROSION ITROLS.

W ON A DAILY BASIS.

IAINTAIN RAIN GAUGES ONSITE (IF NOT AVAILABLE IN THE AREA) TO RECORD RAINFALL DATA DAILY.

IZATION PRACTICES AND CONTROLS ON A DAILY BASIS AND MAINTAIN AND REPAIR THESE MEASURES AND IECESSARY. TEMPORARY AND/OR PERMANENT SEEDING, MULCHING AND SODDING SHALL BE REPAIRED IN ND WASHOUTS, AND HEALTHY GROWTH ESTABLISHED.

GROWTH OF TURF IS ESTABLISHED, THE CONTRACTOR SHALL MAINTAIN THESE AREAS TO INSURE THE GRASS DOES NOT REACH MORE THAN 6 INCHES ABOVE THE ESTABLISHED GRADE.

FURAL PRACTICES ON A DAILY BASIS AND MAINTAIN AND REPAIR THESE MEASURES AND CONTROLS AS JILT UP SEDIMENTS SHALL BE REMOVED FROM SILT FENCES AND FILTER CLOTH SHALL BE REPLACED AS ID WHEN THEY HAVE SERVED THEIR USEFULNESS.

AND MAINTENANCE REPORT SHALL BE COMPLETED WEEKLY AND WITHIN 24 HOURS OF A RAINFALL EVENT DR MORE. THE CONTRACTOR SHALL CREATE AN INSPECTION AND MAINTENANCE REPORT LOG AND NOTE NTS TO THE SWPPP THAT OCCUR DURING CONSTRUCTION.

CTOR ELECTS TO APPLY FOR PERMITS FOR DISCHARGE OF STORMWATER FROM THE SITE DURING , ALL POINTS OF DISCHARGE OF STORMWATER RUNOFF FROM THE SITE SHALL BE INSPECTED ON A DAILY TROLS AND MEASURES REPAIRED AS NECESSARY TO MAINTAIN ACCEPTABLE WATER QUALITY AND UMES IN ACCORDANCE WITH THE PERMIT.

NEL SHALL INSPECT ALL POINTS OF DISCHARGE, AS APPLICABLE, FROM THE PROJECT SITE AND ALL OF THE CONSTRUCTION SITE THAT HAVE NOT BEEN STABILIZED. DISTURBED AREAS AND AREAS USED FOR RIALS EXPOSED TO PRECIPITATION SHALL BE INSPECTED FOR EVIDENCE OF, OR POTENTIAL FOR RING THE STORMWATER MANAGEMENT SYSTEM. THE STORMWATER MANAGEMENT SYSTEM AND EROSION ITROL MEASURES SHALL BE OBSERVED TO ENSURE THAT THEY ARE OPERATING CORRECTLY. INSPECTION REPORTS SHALL BE COMPLETED AT LEAST EVERY WEEK AND FOLLOWING A RAINFALL EVENT OF 0.5 INCHES ATER (SEE ATTACHED FORM). THESE FORMS SHALL BE RETAINED FOR A PERIOD OF AT LEAST 3 YEARS TE THE SITE IS FINALLY STABILIZED.

### ORMWATER DISCHARGE MANAGEMENT

ORMWATER DISCHARGES AND THE MEASURES USED TO ELIMINATE OR REDUCE THEM AND TO PREVENT ING CONTAMINATED MAY INCLUDE DEPENDING ON THE PERMIT: TO WASH VEHICLES WHERE DETERGENTS ARE NOT USED

O CONTROL DUST

R INCLUDING UNCONTAMINATED WATER LINE FLUSHINGS

RNAL BUILDING WASH DOWN THAT DOES NOT USE DETERGENTS

SH WATER WHERE SPILLS OR LEAKS OF TOXIC OR HAZARDOUS MATERIALS HAVE NOT OCCURRED (UNLESS TERIAL HAS BEEN REMOVED) AND WHERE DETERGENTS ARE NOT USED

ED AIR CONDITIONING OR COMPRESSOR CONDENSATE

TED GROUND WATER OR SPRING WATER

R FOOTING DRAINS WHERE FLOWS ARE NOT CONTAMINATED WITH PROCESS MATERIALS SUCH AS SOLVENTS ED EXCAVATION DEWATERING

RIGATION

ESTABLISH PROPER EQUIPMENT/VEHICLE FUELIN EQUIPMENT FUELING AND MAINTENANCE, OIL CHANGING, ETC., SHALL BE PERFORMED AWAY FROM WATERCOURSES, DITCHES, OR STORM DRAINS, IN AN AREA DESIGNATED FOR THAT PURPOSE. THE DESIGNATED AREA SHALL BE EQUIPPED FOR RECYCLING OIL AND CATCHING SPILLS. SECONDARY CONTAINMENT SHALL BE PROVIDED FOR ALL FUEL OIL STORAGE TANKS. THESE AREAS MUST BE INSPECTED EVERY SEVEN DAYS AND WITHIN 24 HOURS OF A 0.5 INCH OR GREATER RAIN EVENT TO ENSURE THERE ARE NO EXPOSED MATERIALS WHICH WOULD CONTAMINATE STORM WATER. SPILL PREVENTION CONTROL PLAN

SITE OPERATORS MUST BE AWARE THAT SPILL PREVENTION CONTROL AND COUNTERMEASURES (SPCC) REQUIREMENTS APPLY. AN SPCC PLAN IS REQUIRED FOR SITES WITH ONE SINGLE ABOVEGROUND STORAGE OF 1,320 GALLONS OR MORE, OR 42,000 GALLONS OF UNDERGROUND STORAGE. SOILS THAT HAVE BEEN CONTAMINATED MUST BE DISPOSED OF IN ACCORDANCE WITH SECTION "CONTAMINATED SOILS" FOUND BELOW.

SPILLS ON PAVEMENT SHALL BE ABSORBED WITH SAWDUST, CAT LITTER OR OTHER ABSORBENT MATERIAL AND DISPOSED OF WITH THE TRASH AT A LICENSED SANITARY LANDFILL. HAZARDOUS OR INDUSTRIAL WASTES SUCH AS MOST SOLVENTS, GASOLINE, OIL-BASED PAINTS, AND CEMENT CURING COMPOUNDS REQUIRE SPECIAL HANDLING. SPILLS SHALL BE REPORTED TO THE EPA (1-913-281-0991). SPILLS OF 25 GALLONS OR MORE OF PETROLEUM PRODUCTS SHALL BE REPORTED TO EPA (1-913-281-0991), THE LOCAL FIRE DEPARTMENT, AND THE LOCAL EMERGENCY PLANNING COMMITTEE WITHIN 30 MINUTES OF THE DISCOVERY OF THE RELEASE. ALL SPILLS, WHICH RESULT IN CONTACT WITH WATER OF THE STATE, MUST BE REPORTED TO THE EPA'S HOTLINE.

### CONTAMINATED SOILS

IF SUBSTANCES SUCH AS OIL, DIESEL FUEL, HYDRAULIC FLUID, ANTIFREEZE, ETC., ARE SPILLED, LEAKED, OR RELEASED ONTO THE SOIL, THE SOIL SHOULD BE DUG UP AND DISPOSED OF AT A LICENSED SANITARY LANDFILL OR OTHER APPROVED PETROLEUM CONTAMINATED SOIL REMEDIATION FACILITY (NOT A CONSTRUCTION/DEMOLITION DEBRIS LANDFILL). PLEASE BE AWARE THAT STORM WATER RUN OFF ASSOCIATED WITH CONTAMINATED SOILS ARE NOT BEING AUTHORIZED UNDER THE EPA'S GENERAL STORMWATER PERMIT ASSOCIATED WITH CONSTRUCTION ACTIVITIES. IN THE EVENT THERE ARE LARGE EXTENSIVE AREAS OF CONTAMINATED SOILS ADDITIONAL MEASURES ABOVE AND BEYOND THE CONDITIONS OF THE EPA'S GENERAL CONSTRUCTION STORMWATER PERMIT WILL BE REQUIRED. DEPENDING ON THE EXTENT OF CONTAMINATION, ADDITIONAL TREATMENT AND/OR COLLECTION AND DISPOSAL MAY BE REQUIRED. ALL STORMWATER DISCHARGES ASSOCIATED WITH CONTAMINATED SOILS MUST BE AUTHORIZED UNDER AN ALTERNATE NPDES PERMIT.

### **REVISION/DATE/DESCRIPTION**

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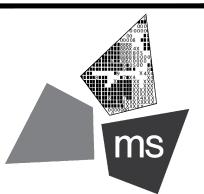
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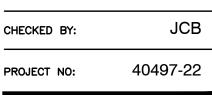
### PROJECT

PROPOSED PT22S BUILDING

2141 GIBSON BLVD SE ALBUQUERQUE, NM 87106


SHEET TITLE SWPPP NOTES & DETAILS





DRAWING

C-10.0

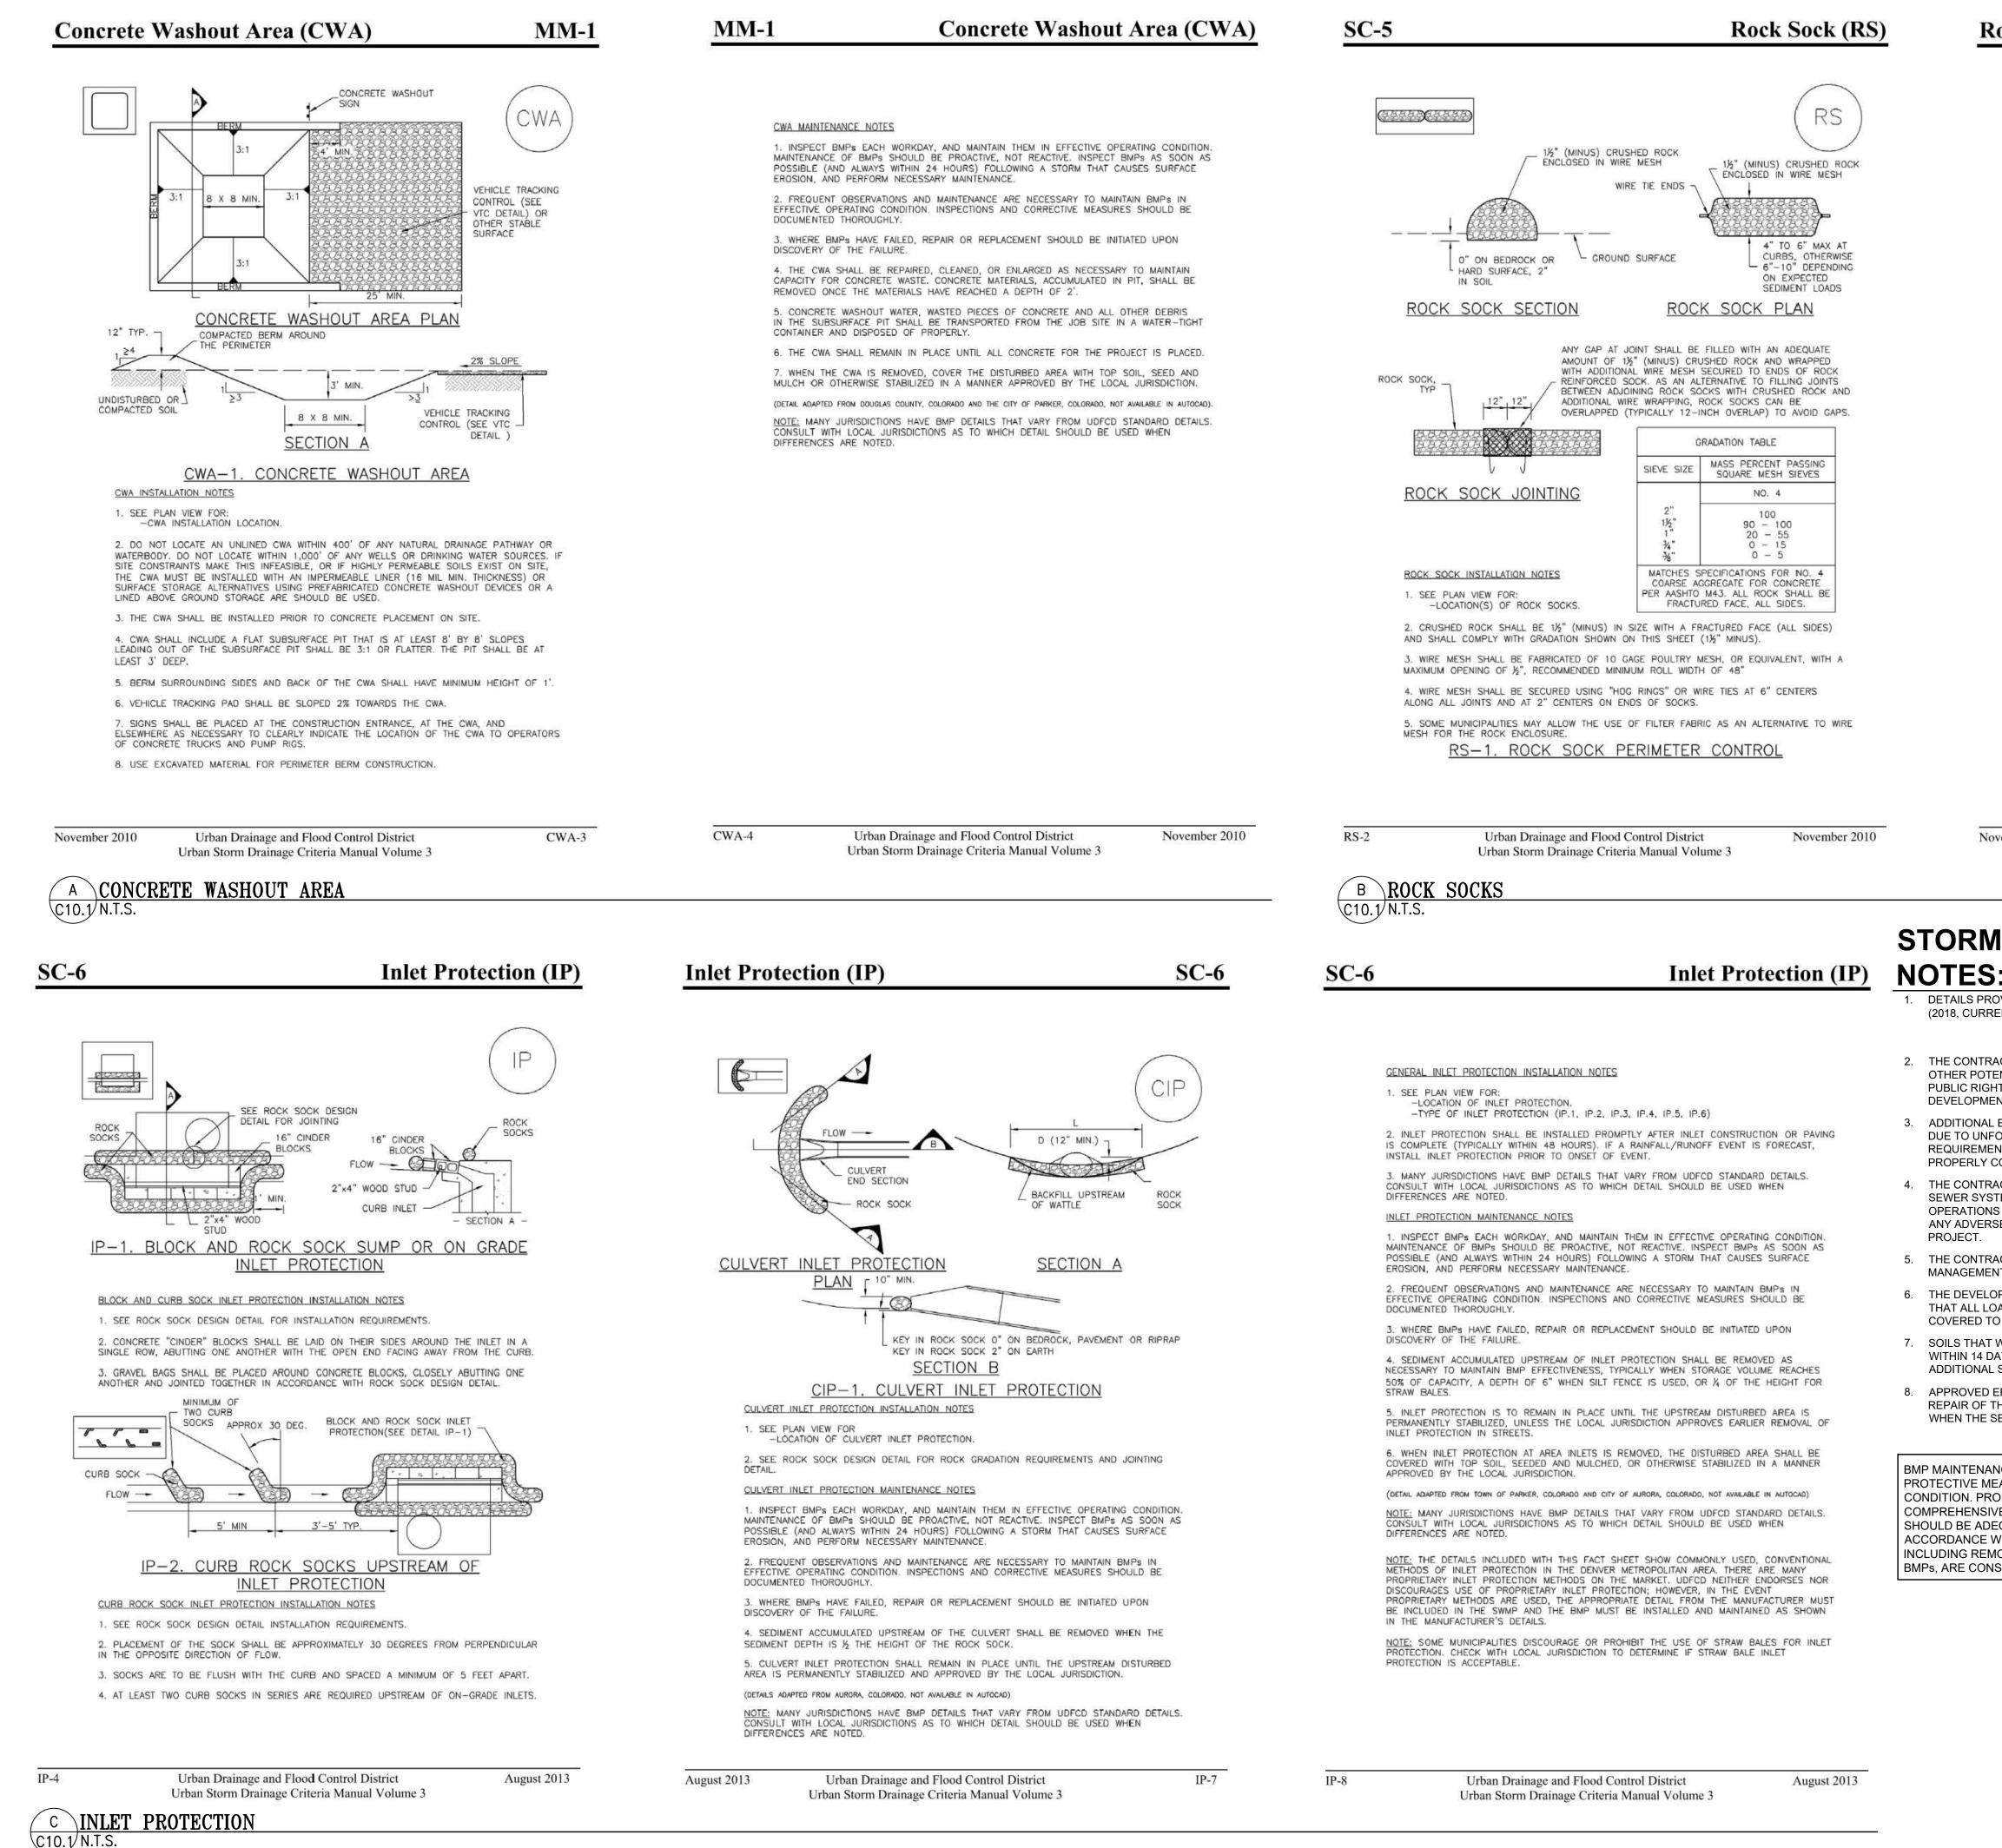

## **Rock Sock (RS)**

## SC-5


### REVISION/DATE/DESCRIPTION

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PERMIT REVIEW SET	07/22/22
TCL REVISION 1	09/15/22
TCL / G&D RESPONSE	11/28/22
TCL RESPONSE #3	12/14/22
PT22S UPDATE	01/11/23
ISSUE FOR PERMIT	05/05/23
TCL RESPONSE #4	06/26/23
BUILDING COMMENT RESPONSE	08/16/23
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### PROJECT

PROPOSED PT22S BUILDING

2141 GIBSON BLVD SE ALBUQUERQUE, NM 87106


### SHEET TITLE

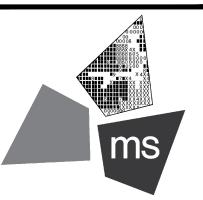SWPPP NOTES & DETAILS



CHECKED BY:	JCB
PROJECT NO:	40497-22

DRAWING

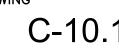

ROCK SOCK MAINTENANCE NOTES

1. INSPECT BMPs EACH WORKDAY, AND MAINTAIN THEM IN EFFECTIVE OPERATING CONDITION. MAINTENANCE OF BMPs SHOULD BE PROACTIVE, NOT REACTIVE. INSPECT BMPs AS SOON AS POSSIBLE (AND ALWAYS WITHIN 24 HOURS) FOLLOWING A STORM THAT CAUSES SURFACE EROSION, AND PERFORM NECESSARY MAINTENANCE

. FREQUENT OBSERVATIONS AND MAINTENANCE ARE NECESSARY TO MAINTAIN BMPs IN EFFECTIVE OPERATING CONDITION. INSPECTIONS AND CORRECTIVE MEASURES SHOULD BE DOCUMENTED THOROUGHLY.

3. WHERE BMPs HAVE FAILED, REPAIR OR REPLACEMENT SHOULD BE INITIATED UPON DISCOVERY OF THE FAILURE. 4. ROCK SOCKS SHALL BE REPLACED IF THEY BECOME HEAVILY SOILED, OR DAMAGED

BEYOND REPAIR. 5. SEDIMENT ACCUMULATED UPSTREAM OF ROCK SOCKS SHALL BE REMOVED AS NEEDED TO MAINTAIN FUNCTIONALITY OF THE BMP, TYPICALLY WHEN DEPTH OF ACCUMULATED SEDIMENTS IS APPROXIMATELY 1/2 OF THE HEIGHT OF THE ROCK SOCK.

6. ROCK SOCKS ARE TO REMAIN IN PLACE UNTIL THE UPSTREAM DISTURBED AREA IS STABILIZED AND APPROVED BY THE LOCAL JURISDICTION.

7. WHEN ROCK SOCKS ARE REMOVED, ALL DISTURBED AREAS SHALL BE COVERED WITH TOPSOIL, SEEDED AND MULCHED OR OTHERWISE STABILIZED AS APPROVED BY LOCAL

(DETAIL ADAPTED FROM TOWN OF PARKER, COLORADO AND CITY OF AURORA, COLORADO, NOT AVAILABLE IN AUTOCAD) NOTE: MANY JURISDICTIONS HAVE BMP DETAILS THAT VARY FROM UDFCD STANDARD DETAILS. CONSULT WITH LOCAL JURISDICTIONS AS TO WHICH DETAIL SHOULD BE USED WHEN DIFFERENCES ARE NOTED.

NOTE: THE DETAILS INCLUDED WITH THIS FACT SHEET SHOW COMMONLY USED, CONVENTIONAL METHODS OF ROCK SOCK INSTALLATION IN THE DENVER METROPOLITAN AREA. THERE ARE MANY OTHER SIMILAR PROPRIETARY PRODUCTS ON THE MARKET. UDFCD NEITHER NDORSES NOR DISCOURAGES USE OF PROPRIETARY PROTECTION PRODUCTS; HOWEVER, IN THE EVENT PROPRIETARY METHODS ARE USED, THE APPROPRIATE DETAIL FROM THE MANUFACTURER MUST BE INCLUDED IN THE SWMP AND THE BMP MUST BE INSTALLED AND MAINTAINED AS SHOWN IN THE MANUFACTURER'S DETAILS.

November 2010

Urban Drainage and Flood Control District Urban Storm Drainage Criteria Manual Volume 3 RS-3

# **STORMWATER MANAGEMENT PLANS GENERAL**

DETAILS PROVIDED ON THIS SHEET ARE SUPERCEDED BY THE CITY OF ALBUQUERQUE CONSTRUCTION SITE MANUAL (2018, CURRENT EDITION). THE CONSTRUCTION SITE MANUAL GOVERNS IF ANY CONFLICTS ARISE.

2. THE CONTRACTOR AND/OR AUTHORIZED AGENTS SHALL REMOVE ALL SEDIMENT, MUD, CONSTRUCTION DEBRIS, OR OTHER POTENTIAL POLLUTANTS THAT MAY HAVE BEEN DISCHARGED TO OR, ACCUMULATE IN, THE FLOW LINES AND PUBLIC RIGHTS OF WAYS OF THE CITY AS A RESULT OF CONSTRUCTION ACTIVITIES ASSOCIATED WITH THIS SITE DEVELOPMENT OR CONSTRUCTION PROJECT. SAID REMOVAL SHALL BE CONDUCTED IN A TIMELY MANNER.

ADDITIONAL EROSION AND SEDIMENT CONTROL MEASURES MAY BE REQUIRED OF THE OWNER AND HIS OR HER AGENTS DUE TO UNFORESEEN EROSION PROBLEMS OR IF THE SUBMITTED PLAN DOES NOT FUNCTION AS INTENDED. THE REQUIREMENTS OF THIS PLAN SHALL BE THE OBLIGATION OF THE PERMIT HOLDER UNTIL SUCH TIME AS THE PLAN IS PROPERLY COMPLETED AND THE PERMIT IS RELEASED.

4. THE CONTRACTOR SHALL PREVENT SEDIMENT, DEBRIS AND ALL OTHER POLLUTANTS FROM ENTERING THE STORM SEWER SYSTEM DURING ALL DEMOLITION, EXCAVATION, TRENCHING, BORING, GRADING OR OTHER CONSTRUCTION OPERATIONS THAT ARE PART OF THIS PROJECT. THE CONTRACTOR SHALL BE HELD RESPONSIBLE FOR REMEDIATION OF ANY ADVERSE IMPACTS TO ADJACENT WATERWAYS, WETLANDS, ETC., RESULTING FROM WORK DONE AS PART OF THIS

5. THE CONTRACTOR SHALL LOCATE, INSTALL, AND MAINTAIN ALL EROSION CONTROL AND WATER QUALITY "BEST MANAGEMENT PRACTICES" AS INDICATED IN THE APPROVED STORMWATER MANAGEMENT PLAN.

6. THE DEVELOPER, GENERAL CONTRACTOR, GRADING CONTRACTOR AND/OR THEIR AUTHORIZED AGENTS SHALL ENSURE THAT ALL LOADS OF CUT AND FILL MATERIAL IMPORTED TO OR EXPORTED FROM THIS SITE SHALL BE PROPERLY COVERED TO PREVENT LOSS OF THE MATERIAL DURING TRANSPORT ON PUBLIC RIGHTS OF WAY.

7. SOILS THAT WILL BE STOCKPILED FOR MORE THAN 30 DAYS SHALL BE PROTECTED FROM WIND AND WATER EROSION WITHIN 14 DAYS OF STOCKPILE CONSTRUCTION. IF STOCKPILES ARE LOCATED WITHIN 100 FEET OF A DRAINAGEWAY, ADDITIONAL SEDIMENT CONTROLS SUCH AS TEMPORARY DIKES OR SILT FENCE SHALL BE REQUIRED.

8. APPROVED EROSION AND SEDIMENT CONTROL BEST MANAGEMENT PRACTICES SHALL BE MAINTAINED AND KEPT IN GOOD REPAIR OF THE DURATION OF THIS PROJECT. ACCUMULATED SEDIMENT AND DEBRIS SHALL BE REMOVED FROM A BMP WHEN THE SEDIMENT OR DEBRIS ADVERSELY IMPACTS THE FUNCTIONING OF THE BMP.


BMP MAINTENANCE NOTE: ALL EROSION AND SEDIMENT CONTROL PRACTICES AND OTHER PROTECTIVE MEASURES IDENTIFIED IN THE SWMP MUST BE MAINTAINED IN EFFECTIVE OPERATION CONDITION. PROPER SELECTION AND INSTALLATION OF BMPs AND IMPLEMENTATION OF COMPREHENSIVE INSPECTION AND MAINTENANCE PROCEDURES IN ACCORDANCE WITH THE SWMP SHOULD BE ADEQUATE TO MEET THIS CONDITION. BMPs THAT ARE NOT ADEQUATELY MAINTAINED IN ACCORDANCE WITH GOOD ENGINEERING, HYDROLOGIC AND POLLUTION CONTROL PRACTICES, INCLUDING REMOVAL OF COLLECTED SEDIMENT OUTSIDE THE ACCEPTABLE TOLERANCES OF THE BMPs, ARE CONSIDERED TO BE NO LONGER OPERATING EFFECTIVELY AND MUST BE ADDRESSED



# Silt Fence (SF)



SC-1

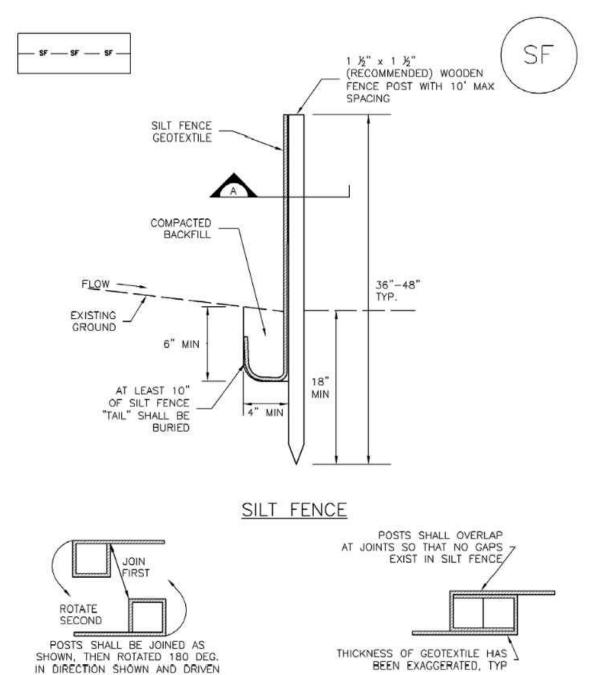


SECTION A

SF-1. SILT FENCE

DISCOVERY OF THE FAILURE. SEDIMENTS IS APPROXIMATELY 6". TEARING, OR COLLAPSE

SF-4

SM-4

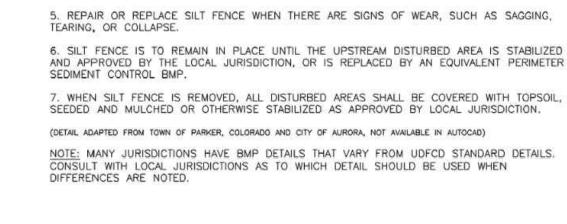

Urban Drainage and Flood Control District

Urban Storm Drainage Criteria Manual Volume 3

SILT FENCE INSTALLATION NOTES

PONDING AND DEPOSITION

TRENCH BY HAND

DOWN THE STAKE.

SILT FENCE MAINTENANCE NOTES


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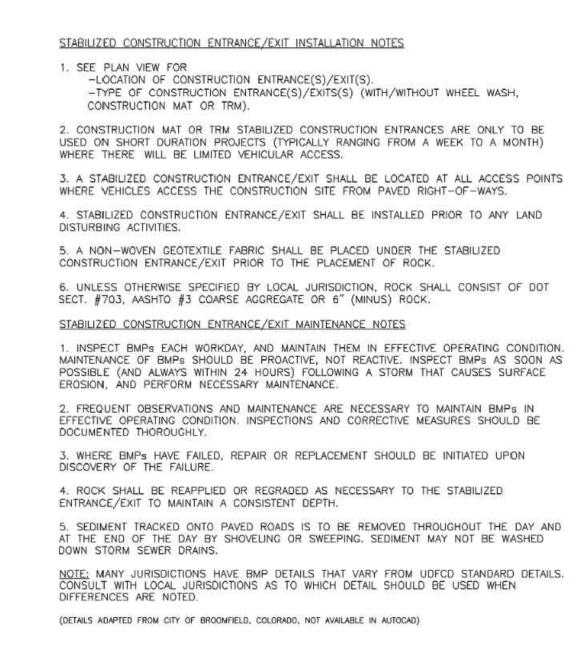
November 2010

INTO THE GROUND


Urban Drainage and Flood Control District SF-3 Urban Storm Drainage Criteria Manual Volume 3





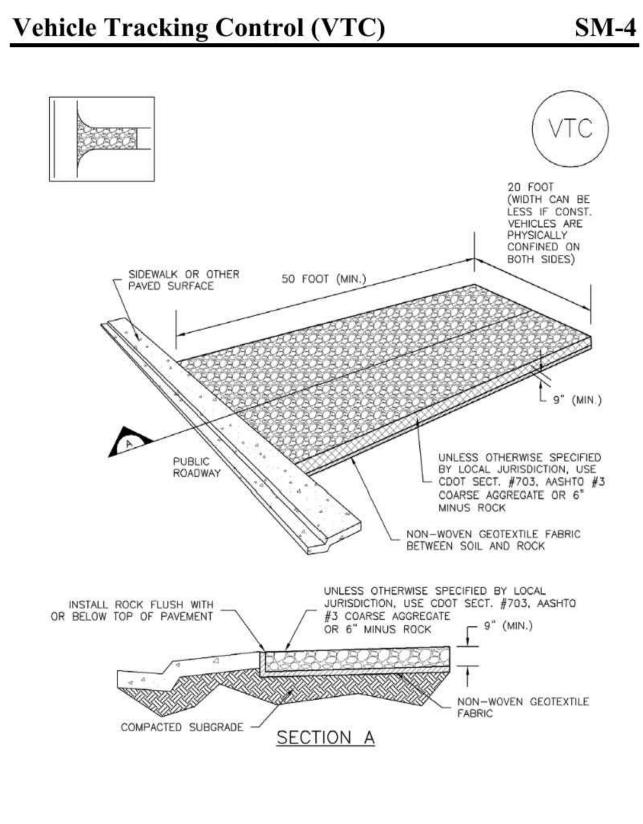

VTC-1. AGGREGATE VEHICLE TRACKING CONTROL

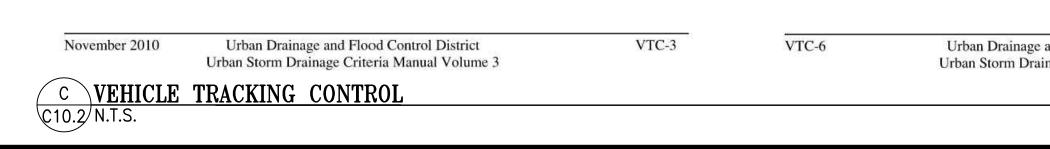

## Silt Fence (SF)

## Stockpile Management (SP)

## **MM-2**

- 1. SILT FENCE MUST BE PLACED AWAY FROM THE TOE OF THE SLOPE TO ALLOW FOR WATER PONDING. SILT FENCE AT THE TOE OF A SLOPE SHOULD BE INSTALLED IN A FLAT LOCATION AT LEAST SEVERAL FEET (2-5 FT) FROM THE TOE OF THE SLOPE TO ALLOW ROOM FOR
- 2. A UNIFORM 6" X 4" ANCHOR TRENCH SHALL BE EXCAVATED USING TRENCHER OR SILT FENCE INSTALLATION DEVICE. NO ROAD GRADERS, BACKHOES, OR SIMILAR EQUIPMENT SHALL BE USED.
- 3. COMPACT ANCHOR TRENCH BY HAND WITH A "JUMPING JACK" OR BY WHEEL ROLLING. COMPACTION SHALL BE SUCH THAT SILT FENCE RESISTS BEING PULLED OUT OF ANCHOR
- 4. SILT FENCE SHALL BE PULLED TIGHT AS IT IS ANCHORED TO THE STAKES. THERE SHOULD BE NO NOTICEABLE SAG BETWEEN STAKES AFTER IT HAS BEEN ANCHORED TO THE STAKES. 5. SILT FENCE FABRIC SHALL BE ANCHORED TO THE STAKES USING 1" HEAVY DUTY STAPLES OR NAILS WITH 1" HEADS. STAPLES AND NAILS SHOULD BE PLACED 3" ALONG THE FABRIC
- 6. AT THE END OF A RUN OF SILT FENCE ALONG A CONTOUR, THE SILT FENCE SHOULD BE TURNED PERPENDICULAR TO THE CONTOUR TO CREATE A "J-HOOK." THE "J-HOOK" EXTENDING PERPENDICULAR TO THE CONTOUR SHOULD BE OF SUFFICIENT LENGTH TO KEEP RUNOFF FROM FLOWING AROUND THE END OF THE SILT FENCE (TYPICALLY 10' - 20'). 7. SILT FENCE SHALL BE INSTALLED PRIOR TO ANY LAND DISTURBING ACTIVITIES.
- 1. INSPECT BMPs EACH WORKDAY, AND MAINTAIN THEM IN EFFECTIVE OPERATING CONDITION MAINTENANCE OF BMPs SHOULD BE PROACTIVE, NOT REACTIVE. INSPECT BMPs AS SOON AS POSSIBLE (AND ALWAYS WITHIN 24 HOURS) FOLLOWING A STORM THAT CAUSES SURFACE EROSION, AND PERFORM NECESSARY MAINTENANCE.
- 2. FREQUENT OBSERVATIONS AND MAINTENANCE ARE NECESSARY TO MAINTAIN BMPs IN EFFECTIVE OPERATING CONDITION. INSPECTIONS AND CORRECTIVE MEASURES SHOULD BE
- 3. WHERE BMPs HAVE FAILED, REPAIR OR REPLACEMENT SHOULD BE INITIATED UPON
- 4. SEDIMENT ACCUMULATED UPSTREAM OF THE SILT FENCE SHALL BE REMOVED AS NEEDED TO MAINTAIN THE FUNCTIONALITY OF THE BMP, TYPICALLY WHEN DEPTH OF ACCUMULATED
- 5. REPAIR OR REPLACE SILT FENCE WHEN THERE ARE SIGNS OF WEAR, SUCH AS SAGGING,
- AND APPROVED BY THE LOCAL JURISDICTION, OR IS REPLACED BY AN EQUIVALENT PERIMETER
- 7. WHEN SILT FENCE IS REMOVED, ALL DISTURBED AREAS SHALL BE COVERED WITH TOPSOIL, SEEDED AND MULCHED OR OTHERWISE STABILIZED AS APPROVED BY LOCAL JURISDICTION.
- CONSULT WITH LOCAL JURISDICTIONS AS TO WHICH DETAIL SHOULD BE USED WHEN

Vehicle Tracking Control (VTC)

November 2010

SP - 3.0' MIN STOCKPILE SILT FENCE (SEE SF DETAIL FOR INSTALLATION REQUIREMENTS) STOCKPILE PROTECTION PLAN MAXIMUM SILT FENCE (SEE SF DETAIL FOR INSTALLATION REQUIREMENTS) SECTION A SP-1. STOCKPILE PROTECTION STOCKPILE PROTECTION INSTALLATION NOTES


1. SEE PLAN VIEW FOR: -LOCATION OF STOCKPILES. -TYPE OF STOCKPILE PROTECTION.

OR SLUMPS AGAINST THE PERIMETER, AND OTHER FACTORS.

. INSTALL PERIMETER CONTROLS IN ACCORDANCE WITH THEIR RESPECTIVE DESIGN DETAILS. ILT FENCE IS SHOWN IN THE STOCKPILE PROTECTION DETAILS: HOWEVER, OTHER TYPES OF PERIMETER CONTROLS INCLUDING SEDIMENT CONTROL LOGS OR ROCK SOCKS MAY BE UITABLE IN SOME CIRCUMSTANCES. CONSIDERATIONS FOR DETERMINING THE APPROPRIATE YPE OF PERIMETER CONTROL FOR A STOCKPILE INCLUDE WHETHER THE STOCKPILE IS LOCATED ON A PERVIOUS OR IMPERVIOUS SURFACE, THE RELATIVE HEIGHTS OF THE PERIMETER CONTROL AND STOCKPILE, THE ABILITY OF THE PERIMETER CONTROL TO CONTAIN THE STOCKPILE WITHOUT FAILING IN THE EVENT THAT MATERIAL FROM THE STOCKPILE SHIFTS

3. STABILIZE THE STOCKPILE SURFACE WITH SURFACE ROUGHENING, TEMPORARY SEEDING AND MULCHING, EROSION CONTROL BLANKETS, OR SOIL BINDERS. SOILS STOCKPILED FOR AN EXTENDED PERIOD (TYPICALLY FOR MORE THAN 60 DAYS) SHOULD BE SEEDED AND MULCHED WITH A TEMPORARY GRASS COVER ONCE THE STOCKPILE IS PLACED (TYPICALLY WITHIN 14 DAYS). USE OF MULCH ONLY OR A SOIL BINDER IS ACCEPTABLE IF THE STOCKPILE WILL BE IN PLACE FOR A MORE LIMITED TIME PERIOD (TYPICALLY 30-60 DAYS).

4. FOR TEMPORARY STOCKPILES ON THE INTERIOR PORTION OF A CONSTRUCTION SITE, WHERE OTHER DOWNGRADIENT CONTROLS, INCLUDING PERIMETER CONTROL, ARE IN PLACE, STOCKPILE PERIMETER CONTROLS MAY NOT BE REQUIRED.

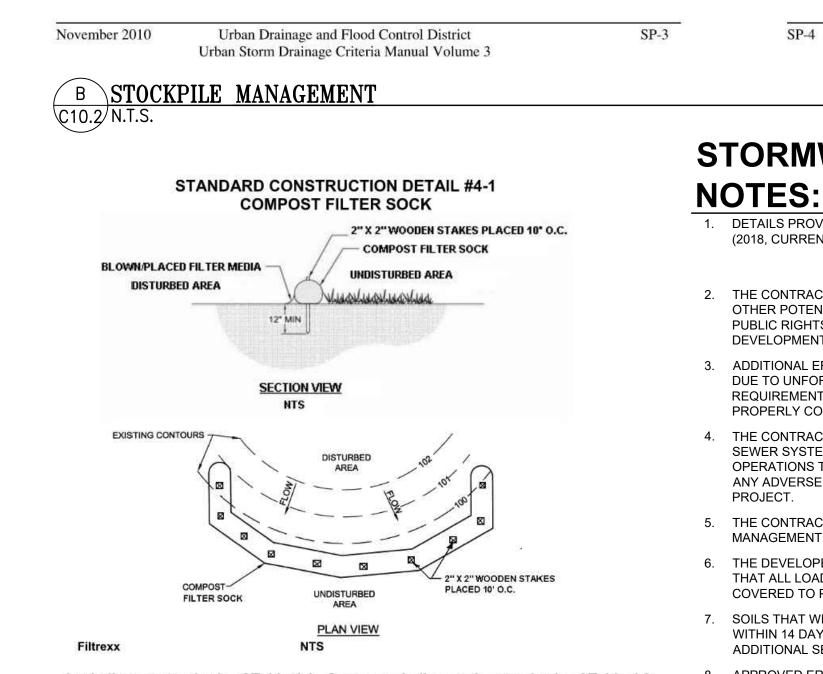

ric shall meet standards of Table 4.1. Compost shall meet the standards of Table 4.2.

filter sock shall be placed at existing level grade. Both ends of the sock shall be at least 8 feet up slope at 45 degrees to the main sock alignment (Figure 4.1). a slope length above any sock shall not exceed that shown on Figure 4.2. Stakes may ed immediately downslope of the sock if so specified by the manufacturer.

all not be permitted to cross filter socks.

ated sediment shall be removed when it reaches half the aboveground height of the disposed in the manner described elsewhere in the plan.

all be inspected weekly and after each runoff event. Damaged socks shall be repaired g to manufacturer's specifications or replaced within 24 hours of inspection.

dable filter socks shall be replaced after 6 months; photodegradable socks after 1 year. vlene socks shall be replaced according to manufacturer's recommendations.

bilization of the area tributary to the sock, stakes shall be removed. The sock may be ice and vegetated or removed. In the latter case, the mesh shall be cut open and the read as a soil supplement.

Urban Drainage and Flood Control District Urban Storm Drainage Criteria Manual Volume 3

November 2010

363-2134-008 / March 31, 2012 / Page 65 COMPOST FILTER SOCK

## **MM-2**

## Stockpile Management (SM)

STOCKPILE PROTECTION MAINTENANCE NOTES

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3. WHERE BMPs HAVE FAILED, REPAIR OR REPLACEMENT SHOULD BE INITIATED UPON DISCOVERY OF THE FAILURE

STOCKPILE PROTECTION MAINTENANCE NOTES 4. IF PERIMETER PROTECTION MUST BE MOVED TO ACCESS SOIL STOCKPILE, REPLACE

PERIMETER CONTROLS BY THE END OF THE WORKDAY. 5. STOCKPILE PERIMETER CONTROLS CAN BE REMOVED ONCE ALL THE MATERIAL FROM THE

STOCKPILE HAS BEEN USED. (DETAILS ADAPTED FROM PARKER, COLORADO, NOT AVAILABLE IN AUTOCAD)

NOTE: MANY JURISDICTIONS HAVE BMP DETAILS THAT VARY FROM UDFCD STANDARD DETAILS. ONSULT WITH LOCAL JURISDICTIONS AS TO WHICH DETAIL SHOULD BE USED WHEN DIFFERENCES ARE NOTED.

Urban Drainage and Flood Control District Urban Storm Drainage Criteria Manual Volume 3 November 2010

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3. ADDITIONAL EROSION AND SEDIMENT CONTROL MEASURES MAY BE REQUIRED OF THE OWNER AND HIS OR HER AGENTS DUE TO UNFORESEEN EROSION PROBLEMS OR IF THE SUBMITTED PLAN DOES NOT FUNCTION AS INTENDED. THE REQUIREMENTS OF THIS PLAN SHALL BE THE OBLIGATION OF THE PERMIT HOLDER UNTIL SUCH TIME AS THE PLAN IS PROPERLY COMPLETED AND THE PERMIT IS RELEASED.

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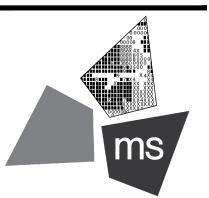
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### PROJECT

## **PROPOSED PT22S** BUILDING

2141 GIBSON BLVD SE ALBUQUERQUE, NM 87106

## SHEET TITLE

**SWPPP NOTES &** DETAILS



CHECKED BY:	JCB
PROJECT NO:	40497-22

DRAWING

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