
CITY OF ALBUQUERQUE

Planning Department Alan Varela, Director

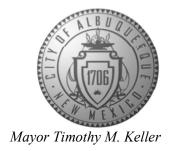

February 14, 2025

Heather Macomber Langan Engineering 2999 Olympus Blvd. Suite 165 Dallas, TX 75019

RE: McDonald's Gibson LC#030-0274

2000 Gibson Blvd. SE Grading and Drainage Plan Engineer's Stamp Date: 01/30/25 Hydrology File: M15D021G

Dear Ms. Macomber:

Based upon the information provided in your submittal received 01/14/2025, the Grading & Drainage Plan **is approved** for Grading Permit, Building Permit, and Paving Permit. Please attach a copy of this approved plan in the construction sets for Building Permit processing along with a copy of this letter.

PO Box 1293

PRIOR TO CERTIFICATE OF OCCUPANCY:

Albuquerque

1. Engineer's Certification, per the DPM Part 6-14 (F): Engineer's Certification Checklist For Non-Subdivision is required.

NM 87103

2. Please provide the Drainage Covenant with Exhibit A for the stormwater quality ponds per Article 6-15(C) of the DPM prior to Permanent Release of Occupancy. Please submit the original copies along with the \$ 25.00 recording fee check made payable to Bernalillo County to the Hydrology Section of Development Review Services on the Ground floor of Plaza de Sol.

www.cabq.gov

As a reminder, if the project total area of disturbance (including the staging area and any work within the adjacent Right-of-Way) is 1 acre or more, then an Erosion and Sediment Control (ESC) Plan and Owner's certified Notice of Intent (NOI) is required to be submitted to the Stormwater Quality Engineer (Doug Hughes, PE, jhughes@cabq.gov, 505-924-3420) 14 days prior to any earth disturbance.

If you have any questions, please contact me at 505-924-3314 or amontoya@cabq.gov.

Sincerely,

Anthony Montoya, Jr., P.E. Senior Engineer, Hydrology

anth Mars

Planning Department, Development Review Services



City of Albuquerque Planning Department


Development & Building Services Division


DRAINAGE AND TRANSPORTATION INFORMATION SHEET (DTIS)

		Hydrology File #			
Legal Description:					
City Address, UPC, OR Parcel:					
Applicant/Agent:		_ Contact:			
Address:		Phone:			
Email:					
Applicant/Owner:		Contact	:		
Address:					
Email:					
TYPE OF DEVELOPMENT: Plat (# of lots)			Single Family Home		
			All other Developments		
	RE-SUBMITTAL:	YES	NO		
DEPARTMENT: TRANS	PORTATION	HYDROLO	OGY/DRAINAGE		
Check all that apply under Both	the Type of Submittal a	nd the Type	of Approval Sought:		
TYPE OF SUBMITTAL:		TYPE OF	APPROVAL SOUGHT:		
Engineering / Architect Certification		Pad Certification			
Conceptual Grading & Drainage Plan		Building Permit			
Grading & Drainage Plan, and/or Drainage		Grading Permit			
Report		Paving Permit			
Drainage Report (Work Order)		SO-19 Permit			
Drainage Master Plan		Foundation Permit			
Conditional Letter of Map Revision (CLOMR)		Certificate of Occupancy - Temp Pern			
Letter of Map Revision (LOMR)	Preliminary / Final Plat			
Floodplain Development Permit		Site Plan for Building Permit - DFT			
Traffic Circulation Layout (TCL) – Administrative		Work Order (DRC)			
Traffic Circulation Layout (TCL) – DFT Approval		Release of Financial Guarantee (ROFG) CLOMR / LOMR			
Traffic Impact Study (TIS)		Conceptual TCL - DFT			
Street Light Layout		OTHER (SPECIFY)			
		OTTLIC	(51 2011 1)		

REV. 04/03/24

DATE SUBMITTED:

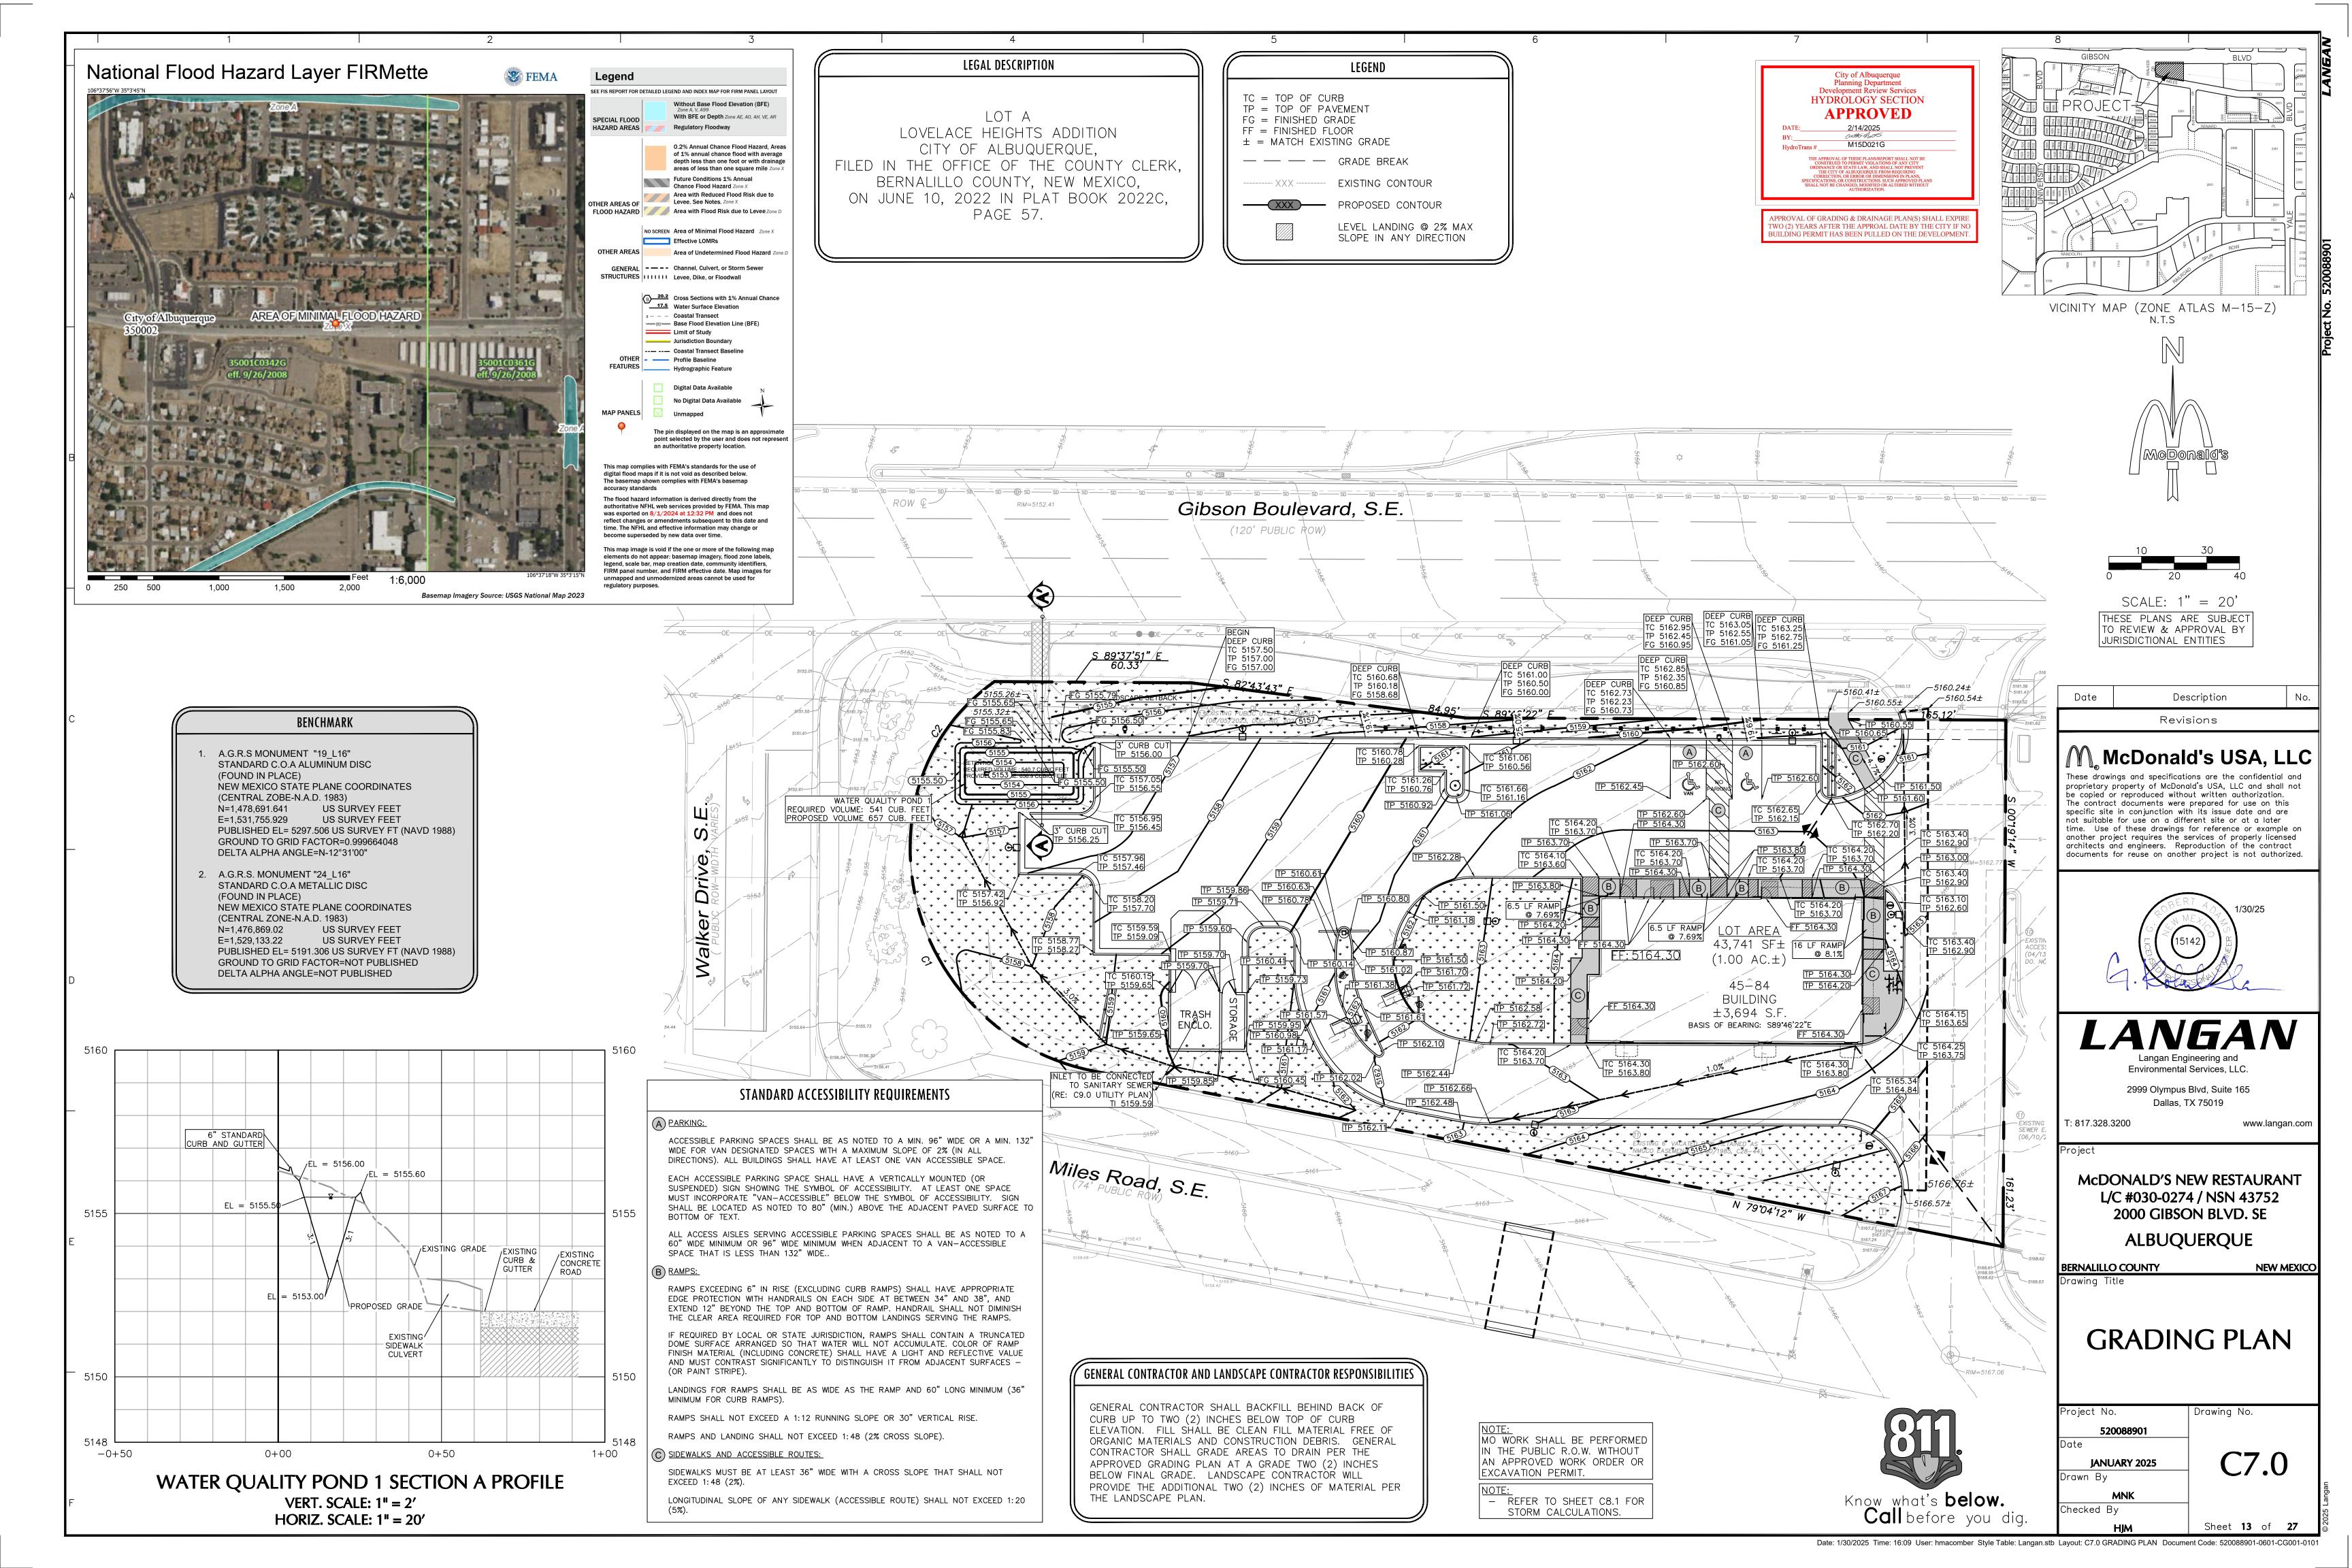

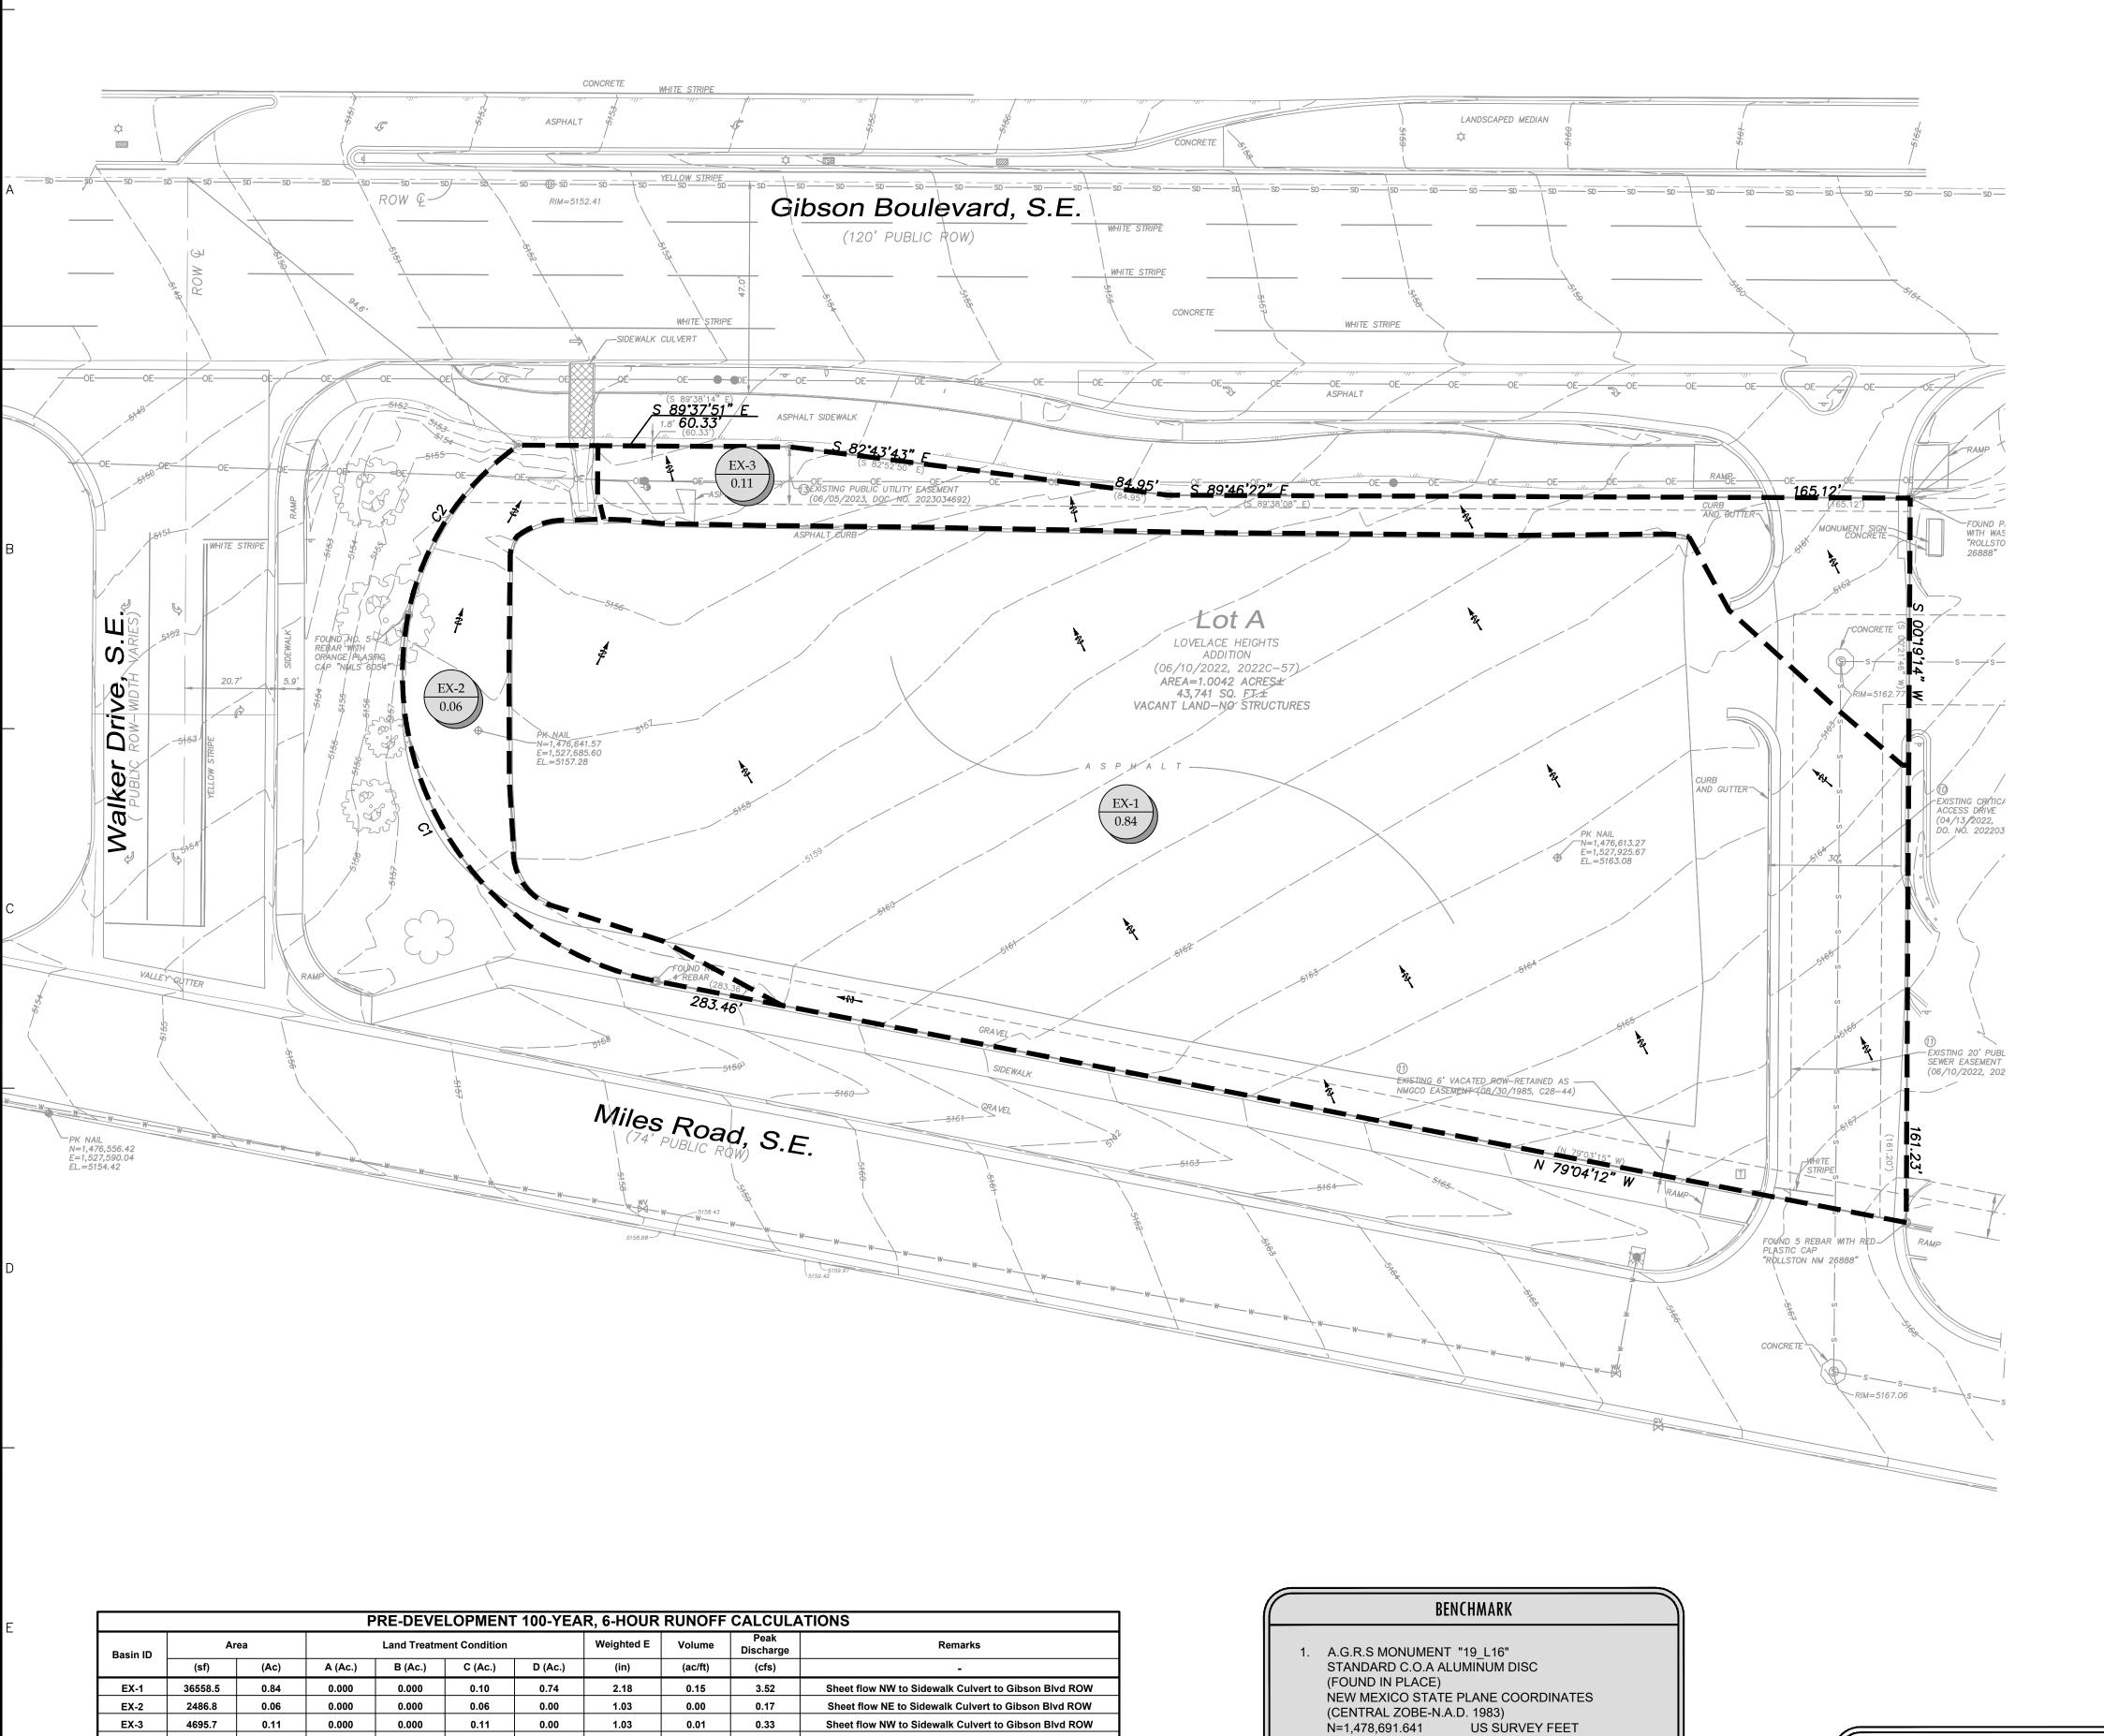

0.0 0.3 0.7

Note: Calculations in accordance with the City of Albuquerque Development Process Manual. The site is in Precipitation Zone 2.

E=1,531,755.929 US SURVEY FEET PUBLISHED EL= 5297.506 US SURVEY FT (NAVD 1988) GROUND TO GRID FACTOR=0.999664048 DELTA ALPHA ANGLE=N-12°31'00"


2. A.G.R.S. MONUMENT "24 L16" STANDARD C.O.A METALLIC DISC (FOUND IN PLACE) NEW MEXICO STATE PLANE COORDINATES (CENTRAL ZONE-N.A.D. 1983) N=1,476,869.02 US SURVEY FEET E=1,529,133.22 US SURVEY FEET PUBLISHED EL= 5191.306 US SURVEY FT (NAVD 1988)

GROUND TO GRID FACTOR=NOT PUBLISHED

DELTA ALPHA ANGLE=NOT PUBLISHED

LEGEND

DRAINAGE AREA LINE

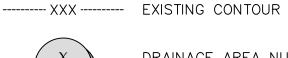



XXX

DRAINAGE AREA NUMBER DRAINAGE AREA (ACRES)



EXISTING FLOW ARROW

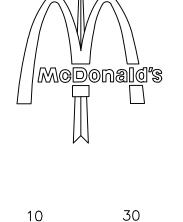

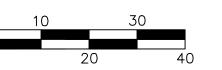

SCALE: 1" = 20'

City of Albuquerque Planning Department Development Review Services HYDROLOGY SECTION **APPROVED** 2/14/2025 anth Mar M15D021G

APPROVAL OF GRADING & DRAINAGE PLAN(S) SHALL EXPIRE TWO (2) YEARS AFTER THE APPROAL DATE BY THE CITY IF NO BUILDING PERMIT HAS BEEN PULLED ON THE DEVELOPMENT


Description

Date

Revisions

McDonald's USA, LLC

proprietary property of McDonald's USA, LLC and shall not be copied or reproduced without written authorization. The contract documents were prepared for use on this not suitable for use on a different site or at a later time. Use of these drawings for reference or example on another project requires the services of properly licensed architects and engineers. Reproduction of the contract documents for reuse on another project is not authorized.

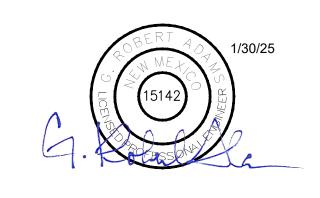

LANGAN Langan Engineering and Environmental Services, LLC.

2999 Olympus Blvd, Suite 165 Dallas, TX 75019

T: 817.328.3200

www.langan.com

McDONALD NEW RESTAURANT L/C #030-0274 / NSN 43752 2000 GIBSON BLVD. SE

ALBUQUERQUE

BERNALILLO COUNTY Drawing Title

NEW MEXICO

PRE-DEVELOPED DRAINAGE PLAN

Project No. 520088901 JANUARY 2025


Drawn By

Checked By

C8.0

Drawing No.

Know what's **below. Call** before you dig. Date: 1/8/2025 Time: 14:37 User: mkayembe Style Table: Langan.stb Layout: C8.0 PRE-DEVELOPED DRAINAGE PLAN Document Code: 520088901-0601-CG001-0102

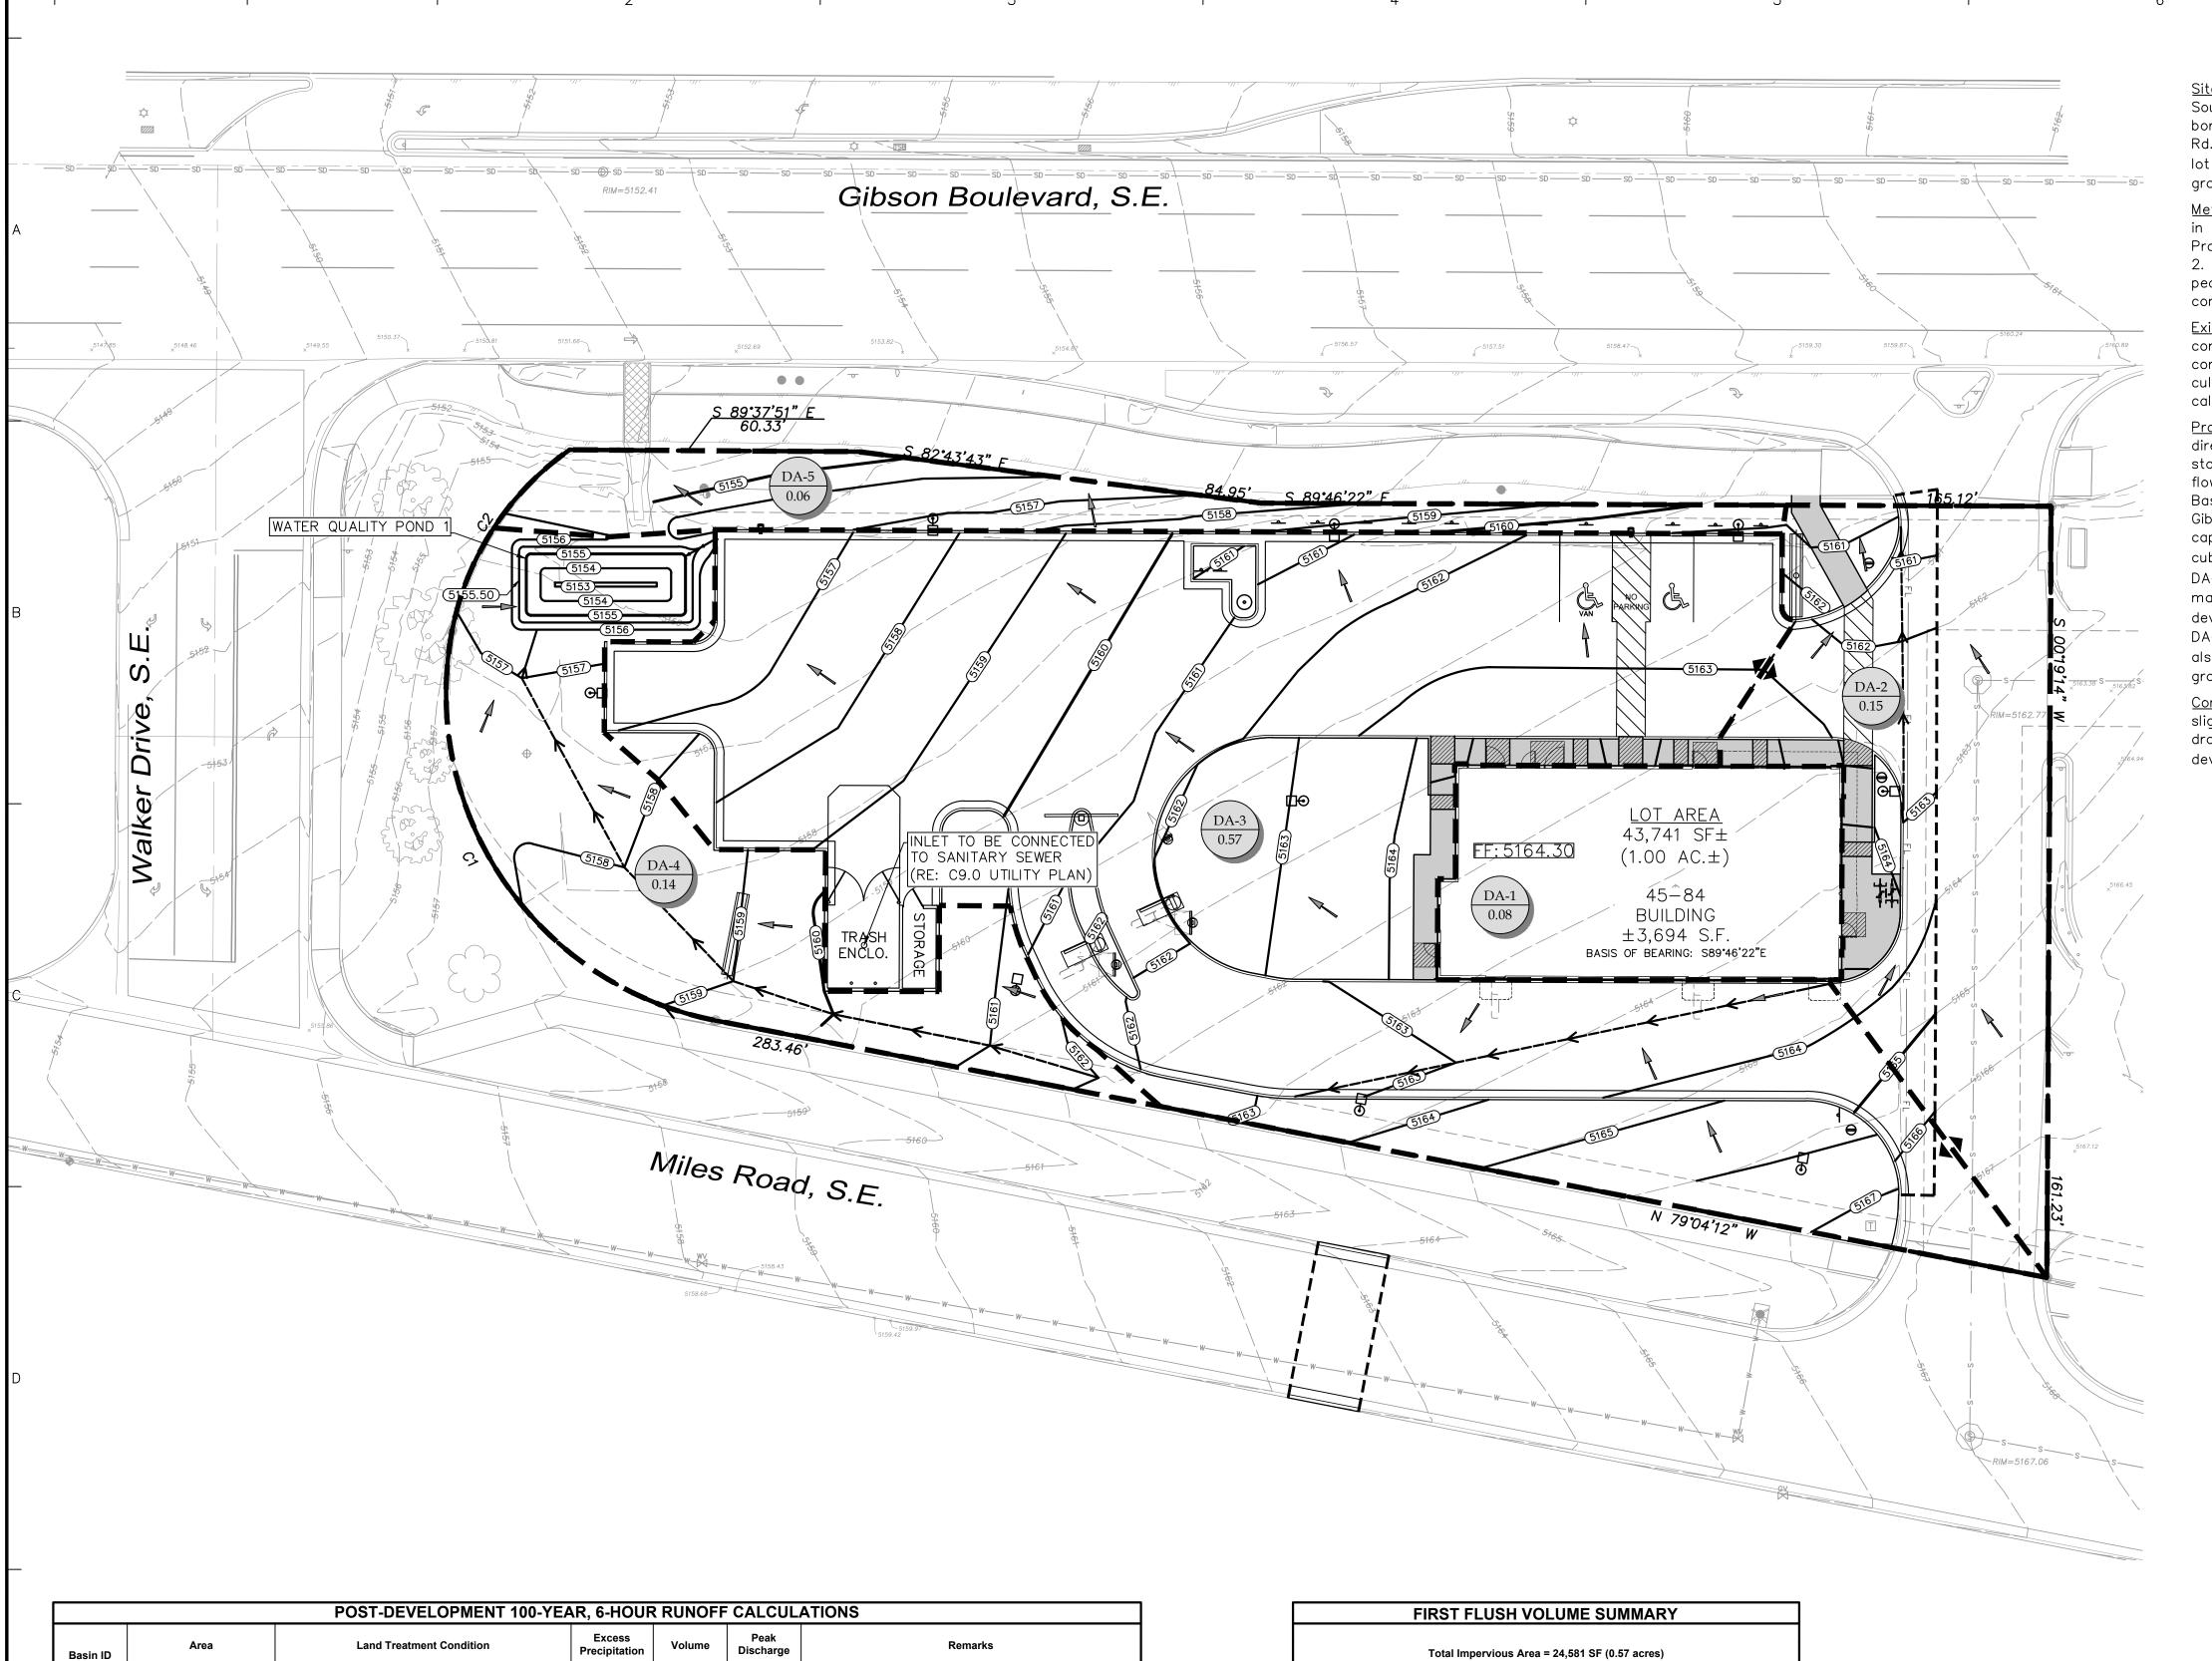

DRAINAGE REPORT


<u>Site Location</u> — The site is located on an approximately 1.0 acre lot at the Southeast corner of Gibson Blvd., S.E. and Walker Drive. The site is bordered to the East by a common access drive and to the South by Miles Rd. Proposed construction will include the demolition of the existing parking lot and construction of a new McDonald's restaurant with associated paving, grading, landscaping, utility, and stormwater management infrastructure.


<u>Methodology</u> — The proposed storm water management system was evaluated in accordance with Chapter 6 of the City of Albuquerque Development Process Manual. The site is located in Bernalillo County Precipitation Zone 2. The 100-year, 6-hour frequency rainfall event was used to calculate peak discharge rates and runoff volumes under existing and proposed

<u>Existing Conditions</u> — Storm water runoff generally drains from the southeast corner of the site to the northwest corner of the site under existing conditions. It flows to an existing flume and through an existing sidewalk culvert that deposits into Gibson Blvd. S.E. Existing conditions runoff calculations are shown on Sheet C8.0 Pre—Developed Drainage Plan.

<u>Proposed Conditions</u> — Under proposed conditions, nearly all site flow will be directed to two curb cuts near the northwest corner and to a first flush storm water quality basin. Drainage areas DA-1, DA-3, and DA-4 will sheet flow through the parking lot to be captured by the Storm Water Quality Basin and ultimately through the existing flume and sidewalk culvert into Gibson Blvd. S.E. The first flush storm water quality basin has a total capacity of 657 cubic feet which exceeds the first flush requirement of 541 cubic feet. A small portion of the site on the east side (Drainage area DA-2) drains directly to to Gibson Blvd. S.E. which is unavoidable, but also matches existing conditions and is in general conformance with the overall development's approved master grading and drainage design. Drainage area DA-5 is a landscape area that will sheet flow to Gibson Blvd. S.E. which also is in conformance with the overall development's approved master grading and drainage design.

<u>Conclusions</u> — The overall amount of impervious area at this site will be slightly reduced under the proposed conditions. It also follows the existing drainage patterns and is in general conformance with the overall development's approved master grading and drainage design.

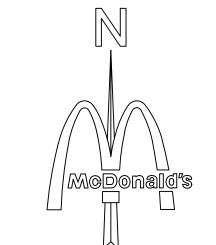

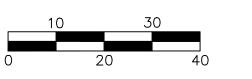

SCALE: 1" = 20'

NOTE: MO WORK SHALL BE PERFORMED IN THE PUBLIC R.O.W. WITHOUT AN APPROVED WORK ORDER OR EXCAVATION PERMIT.




PPROVAL OF GRADING & DRAINAGE PLAN(S) SHALL EXPIRE WO (2) YEARS AFTER THE APPROAL DATE BY THE CITY IF NO

Date Description

Revisions

McDonald's USA, LLC

proprietary property of McDonald's USA, LLC and shall not be copied or reproduced without written authorization. The contract documents were prepared for use on this time. Use of these drawings for reference or example on another project requires the services of properly licensed architects and engineers. Reproduction of the contract documents for reuse on another project is not authorized.

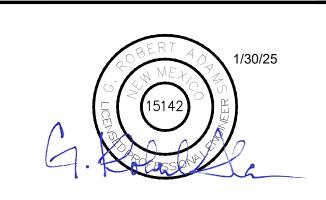

Environmental Services, LLC. 2999 Olympus Blvd, Suite 165 Dallas, TX 75019

T: 817.328.3200

McDONALD'S NEW RESTAURANT L/C #030-0274 / NSN 43752

ALBUQUERQUE

2000 GIBSON BLVD. SE

BERNALILLO COUNTY Drawing Title

Drawing No.

NEW MEXICO

www.langan.com

POST-DEVELOPED DRAINAGE PLAN

520088901 JANUARY 2025 Drawn By

⊃roject No.

Checked By

C8.1

Total Impervious Area = 24,581 SF (0.57 acres)

Required Retention Volume (0.26 in/acre) = 540.7 Cubic Feet

Retention Volume Provided = 656.9 Cubic Feet

Roof Drain Flow to pond

Sheet flow to North to Gibson Blvd ROW

Sheet flow to pond

Sheet Flow to Gibson Blvd ROW

Deficiency / Bypass (cf)

0.0

0.0

0.0

0.63

0.42

0.20

Pond #

1.0

N/A

N/A

0.10

0.01

0.01

C | D

0.00

FIRST FLUSH VOLUME CALCULATIONS

0.14

0.06

Note: Calculations in accordance with the City of Albuquerque Development Process Manual. The site is in Precipitation Zone 2.

SWQV Req.(cf)⁽¹⁾

540.7

0.0

0.0

0.00

0.06

2815.90

Basin ID

DA-1, DA-3

DA-2

DA-4

DA-5

0.00

Impervious Area (Ac)

0.57

0.14

0.00

0.00

(1) - Required volume is 0.26" from the impervious surface (re-development)

2.15

1.03

1.03

SWQV Provided (cf)(2)

656.9

0.0

POND 1 STAGE-STORAGE VOLUME							
- 1	Area	Avg. Area	Inc. Depth	Inc. Volume	Total Volume		
Elevation	(sq. ft.)	(sq. ft.)	(ft.)	(cu. Ft.)	(cu. ft.)		
5153	17.76				0.00		
		101.57	1.00	101.57			
5154	185.37				101.57		
		305.61	1.00	305.61			
5155	425.84				407.17		
		499.46	0.50	249.73			
5155.5	573.07				656.90		

Know what's **below. Call** before you dig.

LEGEND

DRAINAGE AREA NUMBER

DRAINAGE AREA (ACRES)

PROPOSED FLOW ARROW

DRAINAGE AREA LINE

----- XXX ----- EXISTING CONTOUR

PROPOSED CONTOUR

XXX