



* SEE SPEC. SECTION 920 OF CITY OF ALBUQUERQUE PUBLIC WORKS STANDARD SPECIFICATIONS * CONSTRUCT MANHOLE IN ACCORDANCE WITH THE DETAIL CRITERIA ABOVE AND PER CITY OF ALBUQUERQUE PUBLIC WORKS STANDARD DETAIL 2101 FOR TYPE "C" MH. * SEE SPEC. SECTION 106 (GROUT AND MORTAR) OF CITY OF ALBUQUERQUE PUBLIC WORKS STANDARD SPECIFICATIONS






* SEE DETAIL 2415 OF CITY OF ALBUQUERQUE PUBLIC WORKS STANDARD SPECIFICATIONS

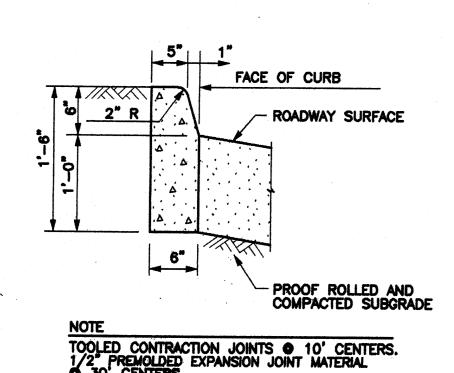


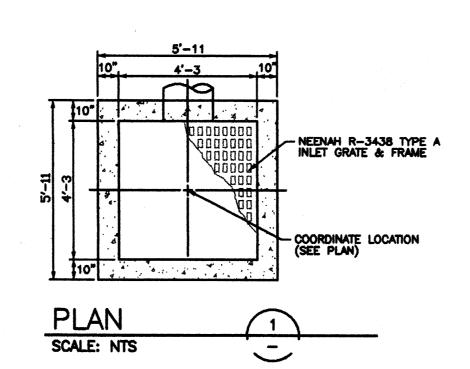

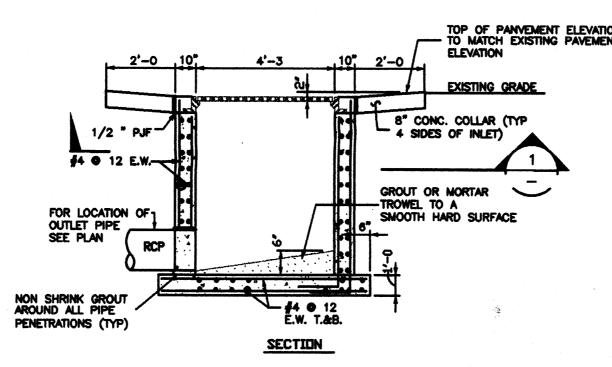



- * CONSTRUCT CB IN ACCORDANCE WITH THE DETAIL CRITERIA ABOVE AND PER CITY OF ALBUQUERQUE PUBLIC WORKS STANDARD DETAIL 2206 (SINGLE)
- * SEE SPEC. SECTION 106 (GROUT AND MORTAR) AND SPEC. SECTION 129 (DUCTILE IRON) OF CITY OF ALBUQUERQUE PUBLIC WORKS STANDARD SPECIFICATIONS FOR INSTALLATION OF DUCTILE IRON INLETS FROM ROOF LEADERS (INVERTS PER PLANS)



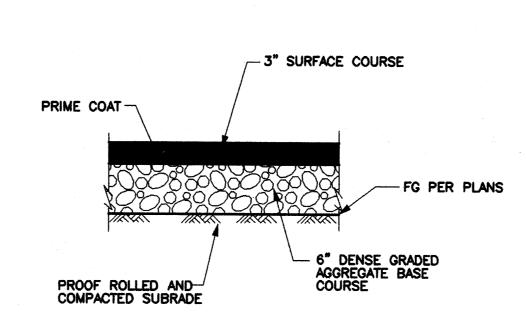


* SEE PROJECT SPEC. SECTION 02612 AND CITY OF ALBUQUERQUE PUBLIC WORKS STANDARD SPECIFICATIONS SECTION 116, TYPE "C"

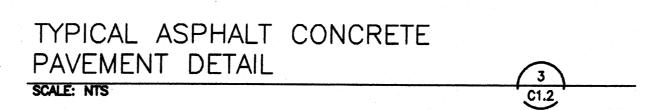


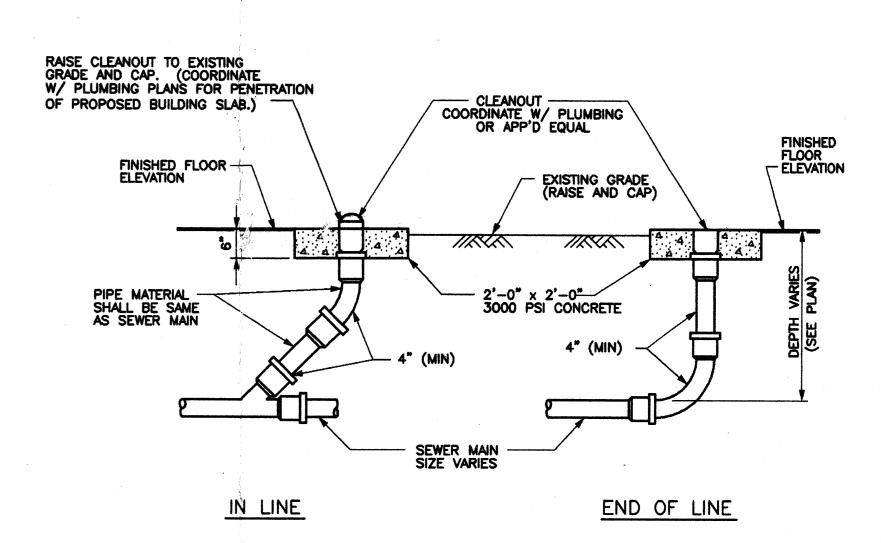

CLEANOUT DETAIL SCALE: NTS

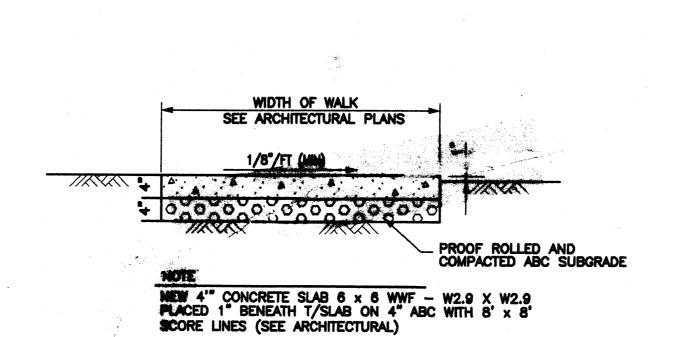



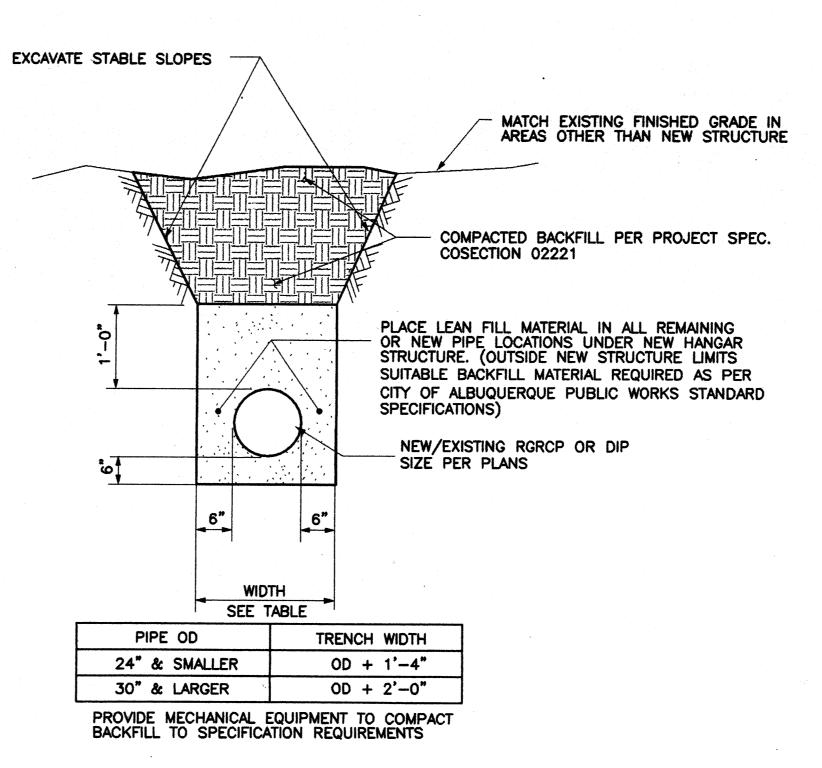


* SEE SECTIONS 129 (DUCTILE IRON PIPE), 123 (REINFORCED CONCRETE PIPE), 204 (FILL CONSTRUCTION), 207 (LEAN FILL CONSTRUCTION), AND 701 (TRENCHING, EXCAVATION, AND BACKFILL) OF CITY OF ALBUQUERQUE PUBLIC WORKS STANDARD SPECIFICATIONS.

PIPE	TRENCH	DETAIL	7
SCALE: NTS			C1.2

SHEET TITLE

DETAILS



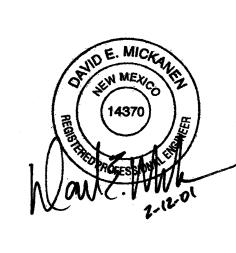




DRAWN BY M. BALCIUS DEPT. CK. D. MICKANEN DEPT. APPR. D. MICKANEN COORD. CK. D. MICKANEN P.M. APPR. J. ATWOOD CLIENT APPR. N/A


LOCKWOOD GREENE
Consulting · Design · Construction 1620 W. Fountainhead Parkway Suite 350 Tempe, Arizona 85282 (480) 829-9000 * (480) 894-8656 Fax ECLIPSE AVIATION AT SUNPORT ALBUQUERQUE INTERNATIONAL SUNPORT ALBUQUERQUE, NM. 87106


DATE 12-FEB-2001 JOB NO. REV. NO. DWG. NO.

0 12-FEB-2001 INITIAL ISSUE

NO DATE

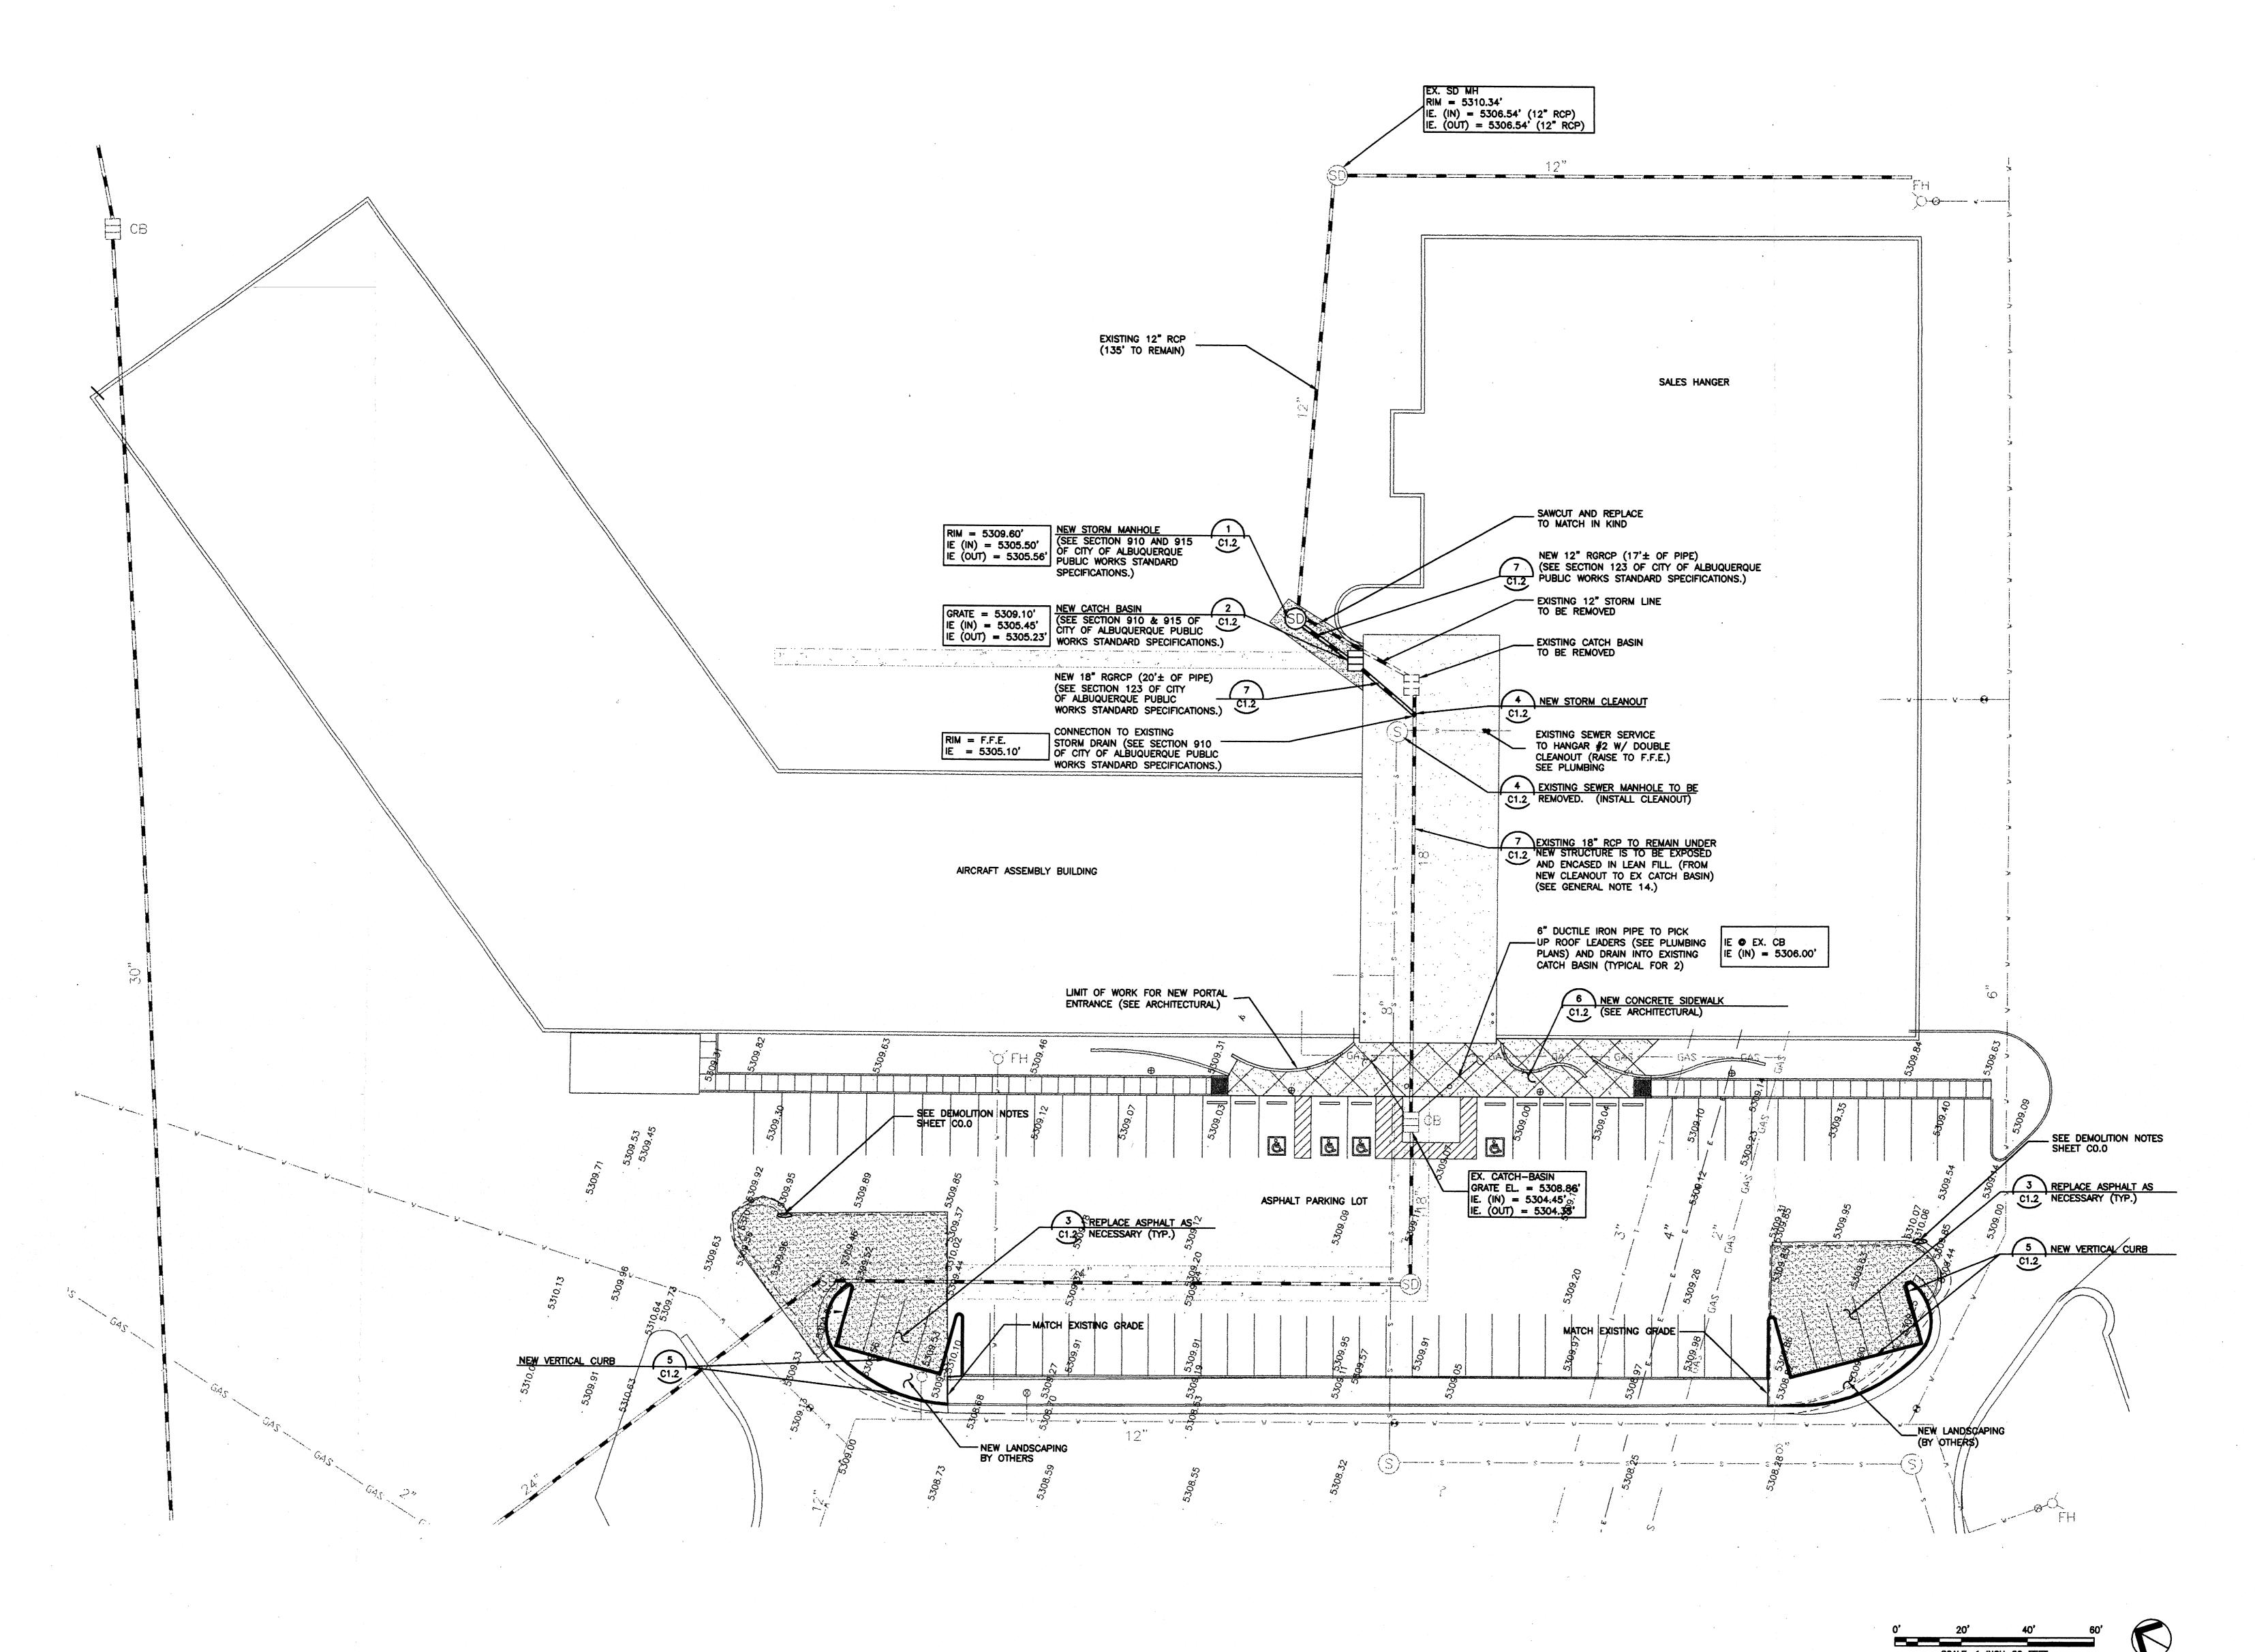

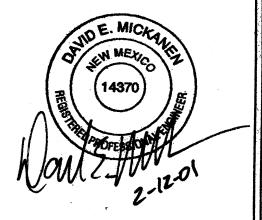


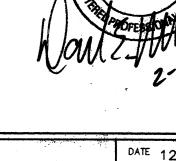



MRB DEM JLA
BY CK. APPR.

0 12-FEB-2001 INITIAL ISSUE

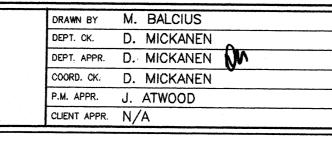

LOCKWOOD GREENE
Consulting · Design · Construction 1620 W. Fountainhead Parkway Suite 350 Tempe, Arizona 85282 (480) 829-9000 * (480) 894-8656 Fax

GRADING & DRAINAGE PLAN

ECLIPSE AVAITION AT SUNPORT ALBUQUERQUE INTERNATIONAL SUNPORT ALBUQUERQUE, NM. 87106

DATE 12-FEB-2001 012849 1"=20'

EXPANSION

FINISH GRADE

HYDRAN

FIRE PROTECTION

GATE VALVE GUTTER ELEVATION

HOT WATER RETURN HYDROGEN GAS

HOT WATER

FINISH FINISH FLOOR FINISH FLOOR ELEVATION

LARED END SECTION

GALLONS PER MINUTE GALVANIZED STEEL

HEADWALL HIGH DENSITY POLYETHYLENE

ABBREVIATIONS: ACRE AGGREGATE ARGON GAS ASBESTOS CEMENT BITUMINOUS COATED CORRUGATED METAL PIPE BOTTOM ELEVATION BUILDING BASE OF WALL ELEVATION CABLE TELEVISION (OVERHEAD)
CABLE TELEVISION (UNDERGROUND)
CAST IRON SOIL PIPE
CATCHE BASIS CENTER LINE
CHILLED WATER
CHILLED WATER RETURN
CHORD LENGTH
CLEAN OUT COMPRESSED AIR
CONCRETE
CONCRETE MASONRY UNIT
CONDENSATE
CORRUGATED METAL PIPE
CUBIC FEET
CUBIC YARD DITCH BOTTOM DOMESTIC WATER EACH FACE EACH WAY EDGE OF PAVEMENT ELECTRICAL CABLE (OVERHEAD)
ELECTRICAL CABLE (UNDERGROUND)
ELECTRICAL MANHOLE
ELEVATION
ELEVATION
EXISTING

INSIDE DIAMETER INVERT ELEVATION IRON PIN FOUND

LINEAR FEET MAXIMUM MECHANICAL JOINT MONUMENT

NATURAL GAS NITROGEN GAS NON-REINFORCED CONCRETE PIPE NOT APPLICABLE NOT IN CONTRACT NOT TO SCALE

NUMBER OUTSIDE DIAMETER OXYGEN GAS

PAVEMENT POINT OF CURVE POINT OF FROG POINT OF INTERSECTION POINT OF TANGENCY PREFORMED JOINT FILLER POINT OF VERTICAL CURVE POLYVINYL CHLORIDE PIPE POINT OF VERTICAL INTERSECTION POINT OF VERTICAL TANGENCY

POUNDS PER SQUARE FEET POUNDS PER SQUARE INCH POINT OF SWITCH POST INDICATOR VALVE POTABLE WATER

RADIUS RAILROAD RAW WATER REINFORCED CONCRETE PIPE REINFORCEMENT RUBBER-GASKET REINFORCED CONCRETE PIPE RIGHT OF WAY

SANITARY SEWER (GRAVITY) SPLASH PAD STORM DRAIN SEWER SQUARE FEET

TELEPHONE CABLE (UNDERGROUND)
TEMPORARY BENCH MARK TOP OF CURB ELEVATION TOP OF GRATE ELEVATION TOP OF WALL ELEVATION TRENCH DRAIN

TOP OF PAVEMENT ELEVATION TOP OF SLAB ELEVATION TOP AND BOTTOM VERTICAL CURVE VITRIFIED CLAY PIPE

WIDE

SECTION AND DETAIL IDENTIFICATION:

SECTION NUMBER OR DETAIL LETTER -

SECTION OR DETAIL

DWG WHERE SECTION OR DETAIL IS DRAWN ----

* NOT ALL SYMBOLS SHOWN ARE APPLICABLE TO THIS PROJECT. ** SEE ABBREVIATIONS LISTING FOR UTILITY IDENTIFICATION.

PROJECT INFORMATION

ADDRESS: 2503 CLARK CARR LOOP SE ALBUQUERQUE, NEW MEXICO 87106 ZONING CLASSIFICATION: BUILDING CODE: UBC - 1997 / ALBUQUERQUE UAC CONSTRUCTION TYPE: SITE AREA: 348,562 S.F. OR 7.88 ACRES± TOTAL CROSS-BLDG. AREA: 89,981 S.F. OCCUPANCY CLASSIFICATION: F-1, B

OWNER/DEVELOPER: ECLIPSE AVIATION, INC.
ECLIPSE FACILITY
2503 CLARK CARR LOOP SE
ALBUQUERQUE, NEW MEXICO 87106
ATTN.: DOUG LANE
505-245-7555
FAX 505-245-7888

ENGINEER/ARCHITECT: LOCKWOOD GREENE 1620 W. FOUNTAINHEAD PARKWAY SUITE 350 TEMPE, ARIZONA 85282 ATTN.: DAVID E. MICKANEN, PE 480-829-9000 FAX 480-894-8656

CIVIL SHEET INDEX

LEGEND, SYMBOLS, AND NOTES GRADING AND DRAINAGE PLAN DETAILS

0 | 12-FEB-2001 INITIAL ISSUE

CO.0 C1.0 C1.2

GENERAL NOTES

1. ALL EXISTING SITE INFORMATION: TOPOGRAPHY, BUILDING LOCATIONS, ROADS & PAVEMENT LOCATIONS AND SITE UTILITIES. WERE OBTAINED FROM A SURVEY PREPARED BY: SURV-TEK, INC., 5643 PARADISE BLVD. N.W., ALBUQUERQUE, NM 87114 CALLED TOPOGRAPHIC/DESIGN SURVEY OF ECLIPSE AVIATION, ALBUQUERQUE INTERNATIONAL AIRPORT, BERNALILLO COUNTY, NM AND DATED FEBRUARY 8, 2001.

2. THE INFORMATION SHOWN ON THESE DRAWINGS CONCERNING TYPE AND LOCATION OF UNDERGROUND AND OTHER UTILITIES IS NOT GUARANTEED TO BE ACCURATE OR ALL-INCLUSIVE. THE CONTRACTOR IS RESPONSIBLE FOR MAKING HIS OWN DETERMINATIONS AS TO THE TYPE AND LOCATION OF UNDERGROUND AND OTHER UTILITIES AS MAY BE NECESSARY TO AVOID DAMAGE THERETO. CONTRACTOR SHALL USE EXTREME CARE WHEN PERFORMING ANY DEMOLITION OR GRADING OPERATIONS IN THE PROXIMITY OF THESE EXISTING UTILITIES. ANY DAMAGE TO EXISTING UTILITIES WILL BE REPAIRED AT THE CONTRACTOR'S EXPENSE. NOTIFY OWNER WHEN ANY UNIDENTIFIED UTILITIES ARE

3. VISIT THE SITE AND MAKE ALL INVESTIGATIONS NECESSARY TO DETERMINING THE EXTENT OF THE WORK REQUIRED TO CONSTRUCT THE PROJECT.

4. ANY DAMAGE TO EXISTING IMPROVEMENTS, SUCH AS, BUT NOT LIMITED TO, DRAINAGE, UTILITIES, PAVEMENT, STRIPING, CURB, ETC. CAUSED BY THE CONTRACTOR DURING CONSTRUCTION, SHALL BE REPAIRED BY THE CONTRACTOR AT NO ADDITIONAL COST TO THE

5. OBTAIN WRITTEN AUTHORIZATION FROM THE OWNER'S REPRESENTATIVE AND FROM THE UTILITY OWNERS PRIOR TO INTERRUPTING ANY EXISTING UTILITY (IE: WATER, SEWER, GAS. ELECTRICAL, OR TELEPHONE).

6. CONSTRUCTION ACCESS TO BE AT DESIGNATED LOCATION ONLY.

7. ALL WORK SHALL COMPLY WITH APPLICABLE STATE, FEDERAL AND LOCAL CODES. ALL NECESSARY LICENSES SHALL BE OBTAINED BY THE CONTRACTOR AT HIS EXPENSE. 8. DEVIATIONS FROM THESE PLANS AND SPECIFICATIONS WITHOUT WRITTEN CONSENT OF THE ARCHITECT/ENGINEER MAY BE CAUSE FOR THE WORK TO BE UNACCEPTABLE TO THE

9. CONTRACTOR IS RESPONSIBLE FOR OBTAINING AND ADHERING TO THE CITY OF ALBUQUERQUE DEPARTMENT OF PUBLIC WORKS STANDARD DETAILS AND SPECIFICATIONS.

10. CONTRACTOR SHALL BE RESPONSIBLE FOR VERIFICATION OF ALL MEASUREMENTS AND DIMENSIONS PRIOR TO ORDERING ANY MATERIALS OR CONDUCTING ANY WORK.

11. ARCHITECT/ENGINEER SHALL BE NOTIFIED A MINIMUM OF FORTY-EIGHT (48) HOURS FOR SITE INSPECTIONS, TESTING VERIFICATIONS, AND FOR ANY OTHER PORTION OF THE WORK REQUIRING ENGINEERS SERVICES AT SITE.

12. ALL WORK SHALL BE PERFORMED IN ACCORDANCE WITH THE LATEST EDITION OF THE CITY OF ALBUQUERQUE PUBLIC WORKS STANDARDS AND SPECIFICATIONS. 13. AGGREGATE BASE COURSE MATERIAL SHALL BE IN ACCORDANCE WITH CITY OF

ALBUQUERQUE PUBLIC WORKS STANDARD DETAILS AND SPECIFICATIONS AND HAVE A MINIMUM THICKNESS OF 6 INCHES COMPACTED TO 95% OF MAXIMUM DRY DENSITY AS INDICATED BY ASTM D1557, UNLESS OTHERWISE INDICATED ON THE PLANS.

14. CONTRACTOR SHALL ENCASE ALL STORM SEWER WITHIN LIMITS OF NEW STRUCTURE (EXISTING OR NEW) IN LEAN FILL MATERIAL. LEAN FILL SHALL BE A MIXTURE OF PORTLAND CEMENT, AGGREGATE AND WATER HAVING A SLUMP OF 7±1 PER ASTM C-143 AND SHALL BE AS PER CITY OF ALBUQUERQUE PUBLIC WORKS STANDARD SPECIFICATIONS SECTION

UTILITY NOTES

COVERING TRENCHES AT INSTALLATION.

1. ALL FIRE PROTECTION AND POTABLE WATER LINES SHALL HAVE A MINIMUM 3.0' OF

2. SEE MECHANICAL AND PLUMBING DRAWINGS FOR CONTINUATION OF UTILITY LINES WITHIN 5' OF THE LIMITS OF THE BUILDING

3. SEE ELECTRICAL SITE PLAN FOR LOCATION OF LIGHT POLES, POWER POLES. POWER LINES, COMMUNICATION LINES AND DUCT BANKS.

4. VERIFY LOCATIONS AND INVERT ELEVATIONS AT ALL PIPE CROSSINGS, INTERSECTIONS, PLUGS, BENDS, AND ENDS OF PIPE FOR ALL NEW UTILITY CONSTRUCTION AND ANY EXISTING LINES PRIOR TO START OF CONSTRUCTION. MAKE MODIFICATIONS, IF REQUIRED, TO ENSURE THE CLEARANCE BETWEEN ALL UTILITIES IS ADEQUATE, MEETS SPECIFICATIONS, AND TO AVOID CONFLICTS.

5. THE TOP ELEVATION OF MANHOLES CONSTRUCTED IN PAVED AREAS SHALL MATCH FINISH GRADE. THE TOP ELEVATION OF MANHOLES CONSTRUCTED IN GRASS AREAS SHALL BE SIX (6") INCHES ABOVE FINISH GRADE.

6. CONTRACTOR SHALL GROUT AROUND ALL PIPE ENTRANCES TO SEWER MANHOLES WITH NON-SHRINKING GROUT TO ASSURE WATER-TIGHT CONNECTION. 7. CONTRACTOR SHALL COORDINATE INSPECTION WITH APPROPRIATE AUTHORITIES PRIOR TO

8. CONSTRUCTION SHALL COMPLY WITH GOVERNING CODES AND REQUIREMENTS.
CONTRACTOR SHALL CONDUCT ALL REQUIRED TESTS TO THE SATISFACTION OF THE UTILITY COMPANIES AND OWNERS INSPECTING AUTHORITIES.

9. CONTRACTOR SHALL COMPLY TO THE FULLEST EXTENT WITH THE LATEST STANDARDS OF OSHA DIRECTIVES, INCLUDING 29 CFR PART 1926 SUBPART P, OR ANY OTHER AGENCY HAVING JURISDICTION FOR EXCAVATION AND TRENCHING PROCEDURE. (SEE CITY OF ALBUQUERQUE PUBLIC WORKS STANDARD SPECIFICATIONS) CONTRACTOR SHALL USE SUPPORT SYSTEMS, SLOPING, BENCHING AND OTHER MEANS OF PROTECTION. THIS IS TO INCLUDE, BUT NOT LIMITED FOR ACCESS AND EGRESS FROM ALL EXCAVATION AND TRENCHING. CONTRACTOR IS RESPONSIBLE TO COMPLY WITH PERFORMANCE CRITERIA FOR

10. NEW DUCTILE IRON PIPE AND FITTINGS SHALL BE AS PER PROJECT SPEC SECTION 02555 AND IN ACCORDANCE WITH CITY OF ALBUQUERQUE PUBLIC WORKS SPECIFICATIONS

11. NEW DOMESTIC WATER SERVICE LINE SHALL BE IN ACCORDANCE WITH CITY OF ALBUQUERQUE PUBLIC WORKS SPECIFICATIONS AND DETAILS.

12. NEW FIRE LINE INSTALLATION SHALL CONFORM TO THE APPLICABLE CITY OF

ALBUQUERQUE STANDARD SPECIFICATIONS AND DETAILS AND SHALL BE CONSTRUCTED OF DUCTILE IRON PIPE. 13. BEDDING AND BACK FILL FOR SANITARY SEWER LATERALS SHALL CONFORM TO CITY OF ALBUQUERQUE PUBLIC WORKS SPECIFICATIONS AND DETAILS.

14. ALL SEWER CONNECTIONS AND CLEAN OUT CONSTRUCTION SHALL CONFORM TO CITY OF ALBUQUERQUE PUBLIC WORKS SPECIFICATIONS AND DETAILS. EXISTING SEWER TAPS ARE

15. THRUST BLOCKS FOR WATER LINES SHALL BE IN ACCORDANCE WITH CITY OF ALBUQUERQUE PUBLIC WORKS DETAIL 2320.

16. NEW STORM SEWER PIPES, JOINTS, SPECIALS, AND MANHOLES SHALL BE INSTALLED IN ACCORDANCE WITH CITY OF ALBUQUERQUE PUBLIC WORKS SPECIFICATIONS SECTIONS 910 AND 915 AND ALL ASSOCIATED DETAILS.

17. FIRE HYDRANTS SHALL BE INSTALLED IN ACCORDANCE WITH CITY OF ALBUQUERQUE PUBLIC WORKS SPECIFICATION AND ALL ASSOCIATED DETAILS.

18. SANITARY AND STORM SEWER MANHOLES SHALL CONFORM TO CITY OF ALBUQUERQUE PUBLIC WORKS SPECIFICATION SECTION 920 AND ALL ASSOCIATED DETAILS. 19. NEW RGRCP STORM SEWER PIPE SHALL CONFORM WITH ASTM C-76 FOR CLASS III STRENGTH AND SHALL COMPLY WITH PROJECT SPEC. SECTION 02500 AND BE ACCORDANCE

20. PORTLAND CEMENT CONCRETE SHALL BE 3,000 PSI TYPE II CEMENT CONCRETE AS PER PROJECT SPEC. 03300 AND CITY OF ALBUQUERQUE PUBLIC WORKS SPECIFICATION

WITH CITY OF ALBUQUERQUE PUBLIC WORKS SPECIFICATION SECTIONS 123, 910, AND 915

DEMOLITION NOTES

1. DEMOLITION TO CONFORM TO CITY OF ALBUQUERQUE PUBLIC CODES. 2. VISIT SITE AND DETERMINE EXTENT OF DEMOLITION REQUIRED.

3. COORDINATE DEMOLITION WORK WITH WORK ALREADY UNDER CONTRACT AND SCHEDULE ACTIVITIES WITH CONTRACTOR. COORDINATE DEMOLITION TO ACCOMMODATE OWNER'S OPERATIONS AND MAINTAIN SITE SECURITY/SAFETY.

4. DISPOSE OF UNSALVAGED DEMOLISHED MATERIALS OFF SITE IN A LEGAL MANNER. 5. STOCKPILE SALVAGED DEMOLISHED MATERIALS ON SITE AS DIRECTED BY

6. LOCATE AND MARK ALL EXISTING UTILITY LINES TO BE ABANDONED AND OBTAIN CONTRACTOR APPROVAL PRIOR TO DEMOLITION. 7. PLUG OPEN ENDS OF ABANDONED GRAVITY UTILITY LINES WITH CONCRETE. USE SUITABLE PLUG WITH CONCRETE THRUST BLOCKING (NFPA 24) FOR PRESSURE PIPE.

REQUIRED TO FACILITATE PROPOSED CONSTRUCTION. 9. DO NOT DISTURB EXISTING UTILITIES TO REMAIN IN SERVICE. DO NOT REMOVE EXISTING UTILITIES TO BE DEMOLISHED UNTIL PROPOSED UTILITY CONSTRUCTION IS COMPLETED AND IN SERVICE. DEMOLISH OR ABANDON EXISTING UTILITIES AS INDICATED AFTER PROPOSED INSTALLATION IS TESTED AND ACCEPTED BY

8. DEMOLISH EXISTING UNDERGROUND UTILITIES INDICATED TO BE ABANDONED AS

10. SAW CUT EXISTING PAVEMENT AT LIMITS OF DEMOLITION OR REMOVE TO THE NEXT NEAREST JOINT BEYOND LIMITS OF DEMOLITION, IF CONCRETE. REPLACE PAVEMENT WHEN REMOVAL EXTENDS BEYOND LIMITS OF DEMOLITION.

11. REPAIR OR REPLACE DAMAGED ITEMS NOT DESIGNATED TO BE DEMOLISHED. RESTORE TO ORIGINAL CONDITION AS DIRECTED BY CONTRACTOR AT NO ADDITIONAL COST

12. POLLUTION CONTROLS: USE WATER SPRINKLING AND OTHER SUITABLE METHODS AS NECESSARY TO LIMIT THE AMOUNT OF DUST AND DIRT RISING AND SCATTERING IN THE AIR, TO THE LOWEST LEVEL OF AIR POLLUTION PRACTICAL FOR THE CONDITION OF WORK.

13. WORK TO BE DEMOLISHED BY CONTRACTOR IS SHOWN ON THE GRADING AND DRAINAGE PLAN AS GREY AND DASHED LINETYPE

GRADING AND DRAINAGE NOTES

1. HAUL PERMITS, WHEN REQUIRED, MUST BE OBTAINED PRIOR TO OR CONCURRENTLY WITH THE GRADING AND DRAINAGE PERMIT.

2. EXCAVATION CONTRACTOR MUST GIVE LOCATION FOR WASTING EXCESS EXCAVATION AND A LETTER FROM THE OWNER GIVING PERMISSION FOR DUMPING PRIOR TO STARTING ONSITE CONSTRUCTION. IF EXCESS EXCAVATION EXCEEDS 100 CUBIC YARDS, THE DISPOSAL SITE WILL ALSO REQUIRE A GRADING AND DRAINAGE PERMIT.

3. CONTACT MR. JIM HINDE WITH THE CITY OF ALBUQUERQUE SUNPORT AUTHORITY 48 HRS BEFORE ANY ON-SITE AND/OR OFF-SITE CONSTRUCTION BEGINS, TELEPHONE (505)

4. AN APPROVED GRADING AND DRAINAGE PLAN SHALL BE KEPT ON THE JOBSITE AT ALL TIMES. DEVIATION FROM THE PLAN MUST BE PRECEDED BY AN APPROVED PLAN REVISION.

5. GRADING AND DRAINAGE PLAN APPROVAL INCLUDES THE CONSTRUCTION OF ALL SURFACE IMPROVEMENTS SHOWN ON THE APPROVED PLAN, INCLUDING, BUT NOT LIMITED TO. RETENTION AREAS, SEDIMENTATION BASINS, AND/OR OTHER DRAINAGE FACILITIES, DRAINAGE PATTERNS, WALLS, CURBS, ASPHALT PAVEMENT, AND BUILDING FLOOR ELEVATIONS.

6. ALL DRAINAGE PROTECTIVE DEVICES SUCH AS SWALES, INTERCEPTOR DITCHES, PIPES, PROTECTIVE BERMS, BARRIER WALLS, CONCRETE CHANNELS, OR OTHER MEASURES DESIGNED TO PROTECT ADJACENT BUILDINGS OR PROPERTY FROM STORM RUNOFF MUST BE COMPLETED PRIOR TO BUILDING CONSTRUCTION.

7. DAMAGED AND/OR DISPLACED CONCRETE CURB, GUTTER, SIDEWALK, OR DRIVEWAY SLAB THAT IS WITHIN THE RIGHT-OF-WAY SHALL BE REPAIRED OR REPLACED, AS NOTED BY CITY INSPECTORS, BEFORE FINAL ACCEPTANCE OF THE WORK. 8. CONSTRUCTION WITHIN THE RIGHT-OF-WAY SHALL CONFORM TO THE LATEST APPLICABLE

CITY OF ALBUQUERQUE STANDARD SPECIFICATIONS FOR PUBLIC WORKS CONSTRUCTION. 9. COMPACTION SHALL COMPLY WITH CITY OF ALBUQUERQUE STANDARD SPECIFICATIONS SECTION 204.

10. OBSTRUCTIONS TO PROPOSED IMPROVEMENTS IN THE RIGHT-OF-WAY SHALL BE REMOVED OR RELOCATED BEFORE BEGINNING CONSTRUCTION OF THE PROPOSED

NECESSARY TO INSURE A SITE FREE OF DRAINAGE PROBLEMS. 12. CONTRACTOR SHALL SAWCUT EXISTING PAVEMENT FOR NEW WORK. NEW PAVEMENT SHALL GRADE TO DRAIN AND MATCH EXISTING PAVEMENT ELEVATIONS WHERE NEW MEETS

11. CONTRACTOR SHALL MAKE ADJUSTMENTS TO PAVING AND GRADING ELEVATIONS AS

CITY LEGEND BUILDING

ASPH

SOME THE PROPERTY OF THE PROPE

DIP

CONCRETE -----FENCE STORM DRAIN TRENCH DRAIN -----22 ------SANITARY SEWER FIRE PROTECTION WATER PIPE

ASPHALT PAVEMENT

ASPHALT OVERLAY

NATURAL GAS UNDERGROUND ELECTRIAL UNDERGROUND TELEPHONE WATER METER

MANHOLE GRATE INLET

CURB AND GUTTER FIRE HYDRANT WATER VALVE

SPOT ELEVATIONS

INVERT ELEVATION

⊖w

PROPOSED

akseaksnakseakseakseakseakseakseakse

*4

DUCTILE IRON PIPE RUBBER GASKET REINFORCED CONCRETE PIPE

ELEVATION FINISH GRADE

EDGE OF PAVEMENT HIGH POINT CLEAN OUT

Gibson Blyd Se ose Kirtland Addition Armijo eorge Rd Se MAGNETIC VARIANCE 10° 53' East (May 1993) **66** ECLIPSE AVIATION **SUNPORT FACILITY** Kinney′ ہے۔


VICINITY MAP

DRAINAGE SCOPE:

THE SCOPE OF WORK INCLUDED IN THE DESIGN IS THE RELOCATION OF A CATCH BASIN. THE ADDITION OF A 17 FOOT LENGTH OF 12" RGRCP, THE ADDITION OF A 20 FOOT LENGTH OF 18" RGRCP, INSTALLING A NEW STORM DRAIN MANHOLE, AND INSTALLING A NEW CLEANOUT WHERE THE NEW STORM DRAIN TIES INTO THE EXISTING STORM DRAIN

DUE TO THE NEW SCOPE OF WORK NOT IMPACTING OR AFFECTING THE EXISTING SITE DRAINAGE, NO HYDRAULIC CALCULATIONS ARE REQUIRED.

SHEET TITLE

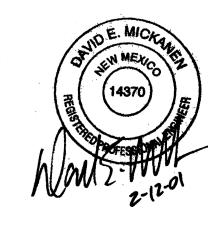



2503 CLARK CAPR LOOP SE, ALBUQUERQUE, RM 87106 (505) 245 - 7555

DRAWN BY M. BALCIUS DEPT. CK. D. MICKANEN DEPT. APPR. D. MICKANEN COORD. CK. D. MICKANEN P.M. APPR. J. ATWOOD CLIENT APPR. N/A


AND ALL ASSOCIATED DETAILS.


LOCKWOOD GREENE Consulting · Design · Construction 1620 W. Fountainhead Parkway Suite 350 Tempe, Arizona 85282 (480) 829-9000 * (480) 894-8656 Fax

LEGEND, SYMBOLS, AND NOTES

ECLIPSE AVIATION AT SUNPORT ALBUQUERQUE INTERNATIONAL SUNPORT ALBUQUERQUE, NM. 87106


DATE 12-FEB-2000 012849 REV. NO. AS NOTED

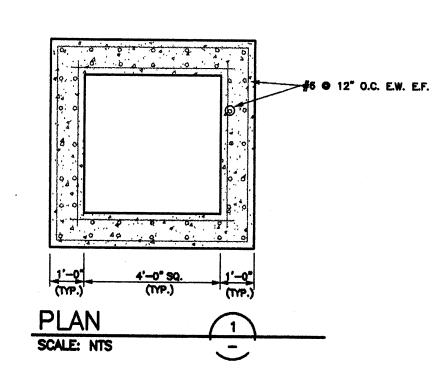


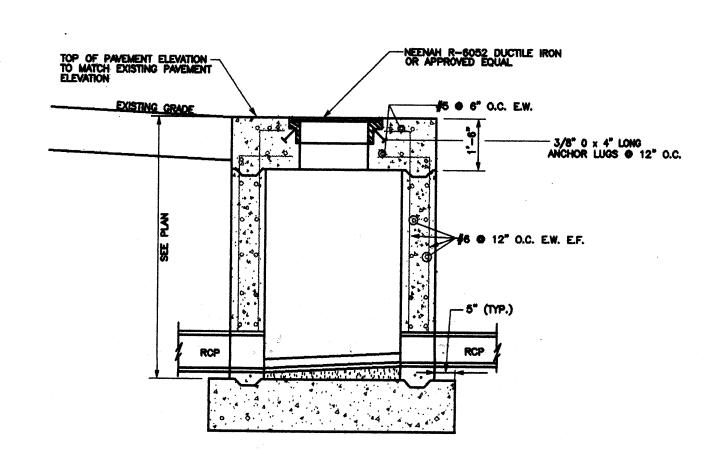

- * SEE SPEC. SECTION 920 OF CITY OF ALBUQUERQUE PUBLIC WORKS STANDARD SPECIFICATIONS * CONSTRUCT MANHOLE IN ACCORDANCE WITH THE DETAIL CRITERIA ABOVE AND PER CITY OF ALBUQUERQUE PUBLIC WORKS STANDARD DETAIL 2101 FOR TYPE "C" MH.
- * SEE SPEC. SECTION 106 (GROUT AND MORTAR) OF CITY OF ALBUQUERQUE PUBLIC WORKS STANDARD SPECIFICATIONS


MANHOLE DETAIL SCALE: NTS

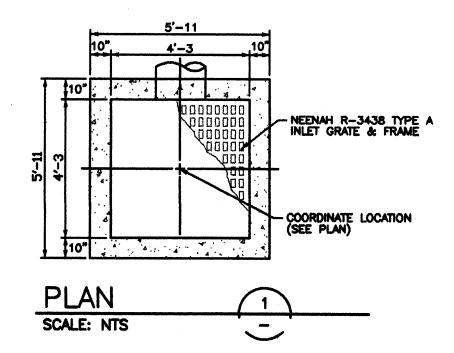

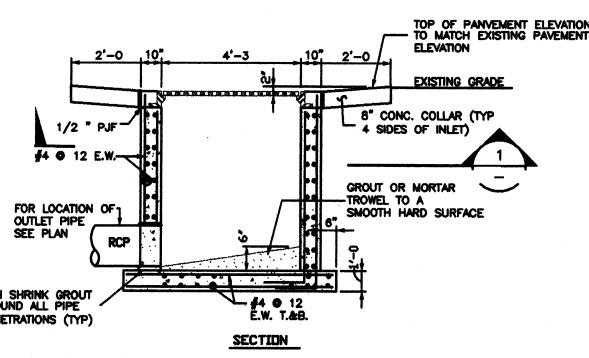


- * CONSTRUCT CB IN ACCORDANCE WITH THE DETAIL CRITERIA ABOVE AND PER CITY OF ALBUQUERQUE PUBLIC WORKS STANDARD DETAIL 2206 (SINGLE)
- * SEE SPEC. SECTION 106 (GROUT AND MORTAR) AND SPEC. SECTION 129 (DUCTILE IRON) OF CITY OF ALBUQUERQUE PUBLIC WORKS STANDARD SPECIFICATIONS FOR INSTALLATION OF DUCTILE IRON INLETS FROM ROOF LEADERS (INVERTS PER PLANS)

CATCH BASIN DETAIL

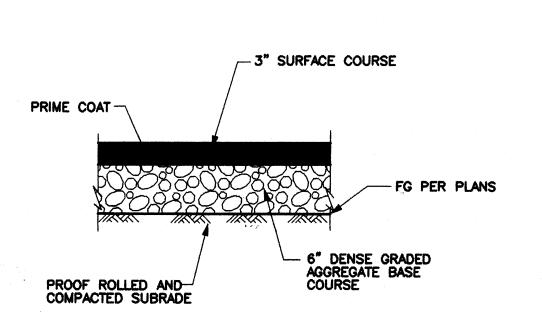


* SEE PROJECT SPEC. SECTION 02612 AND CITY OF ALBUQUERQUE PUBLIC WORKS STANDARD SPECIFICATIONS SECTION 116, TYPE "C"

TYPICAL ASPHALT CONCRETE PAVEMENT DETAIL SCALE: NTS

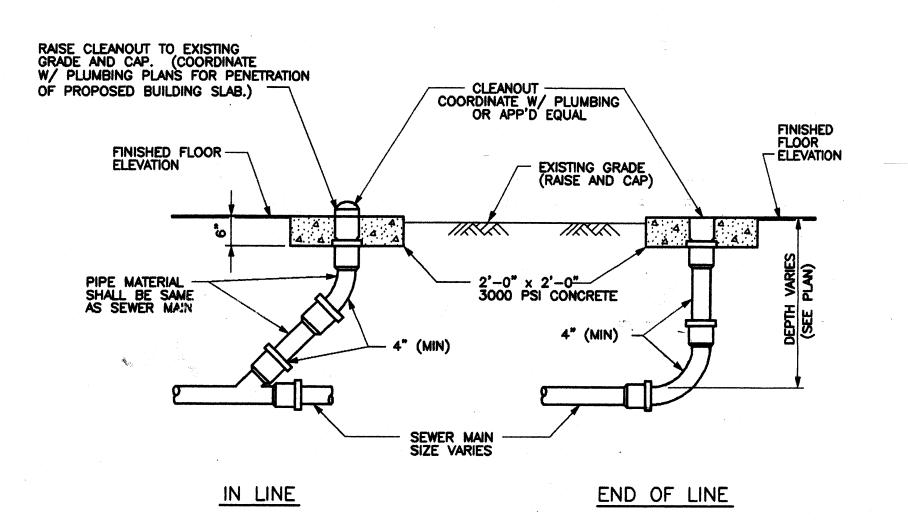


CLEANOUT DETAIL SCALE: NTS

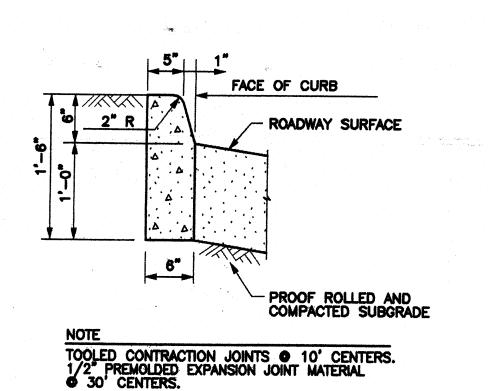


* SEE DETAIL 2415 OF CITY OF ALBUQUERQUE PUBLIC WORKS STANDARD SPECIFICATIONS

VERTICAL CURB DETAIL

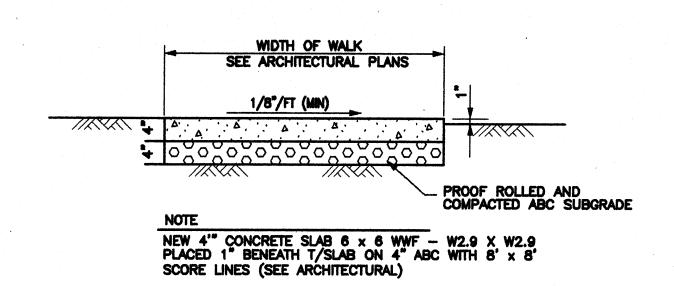


CONCRETE SIDEWALK SCALE: NTS

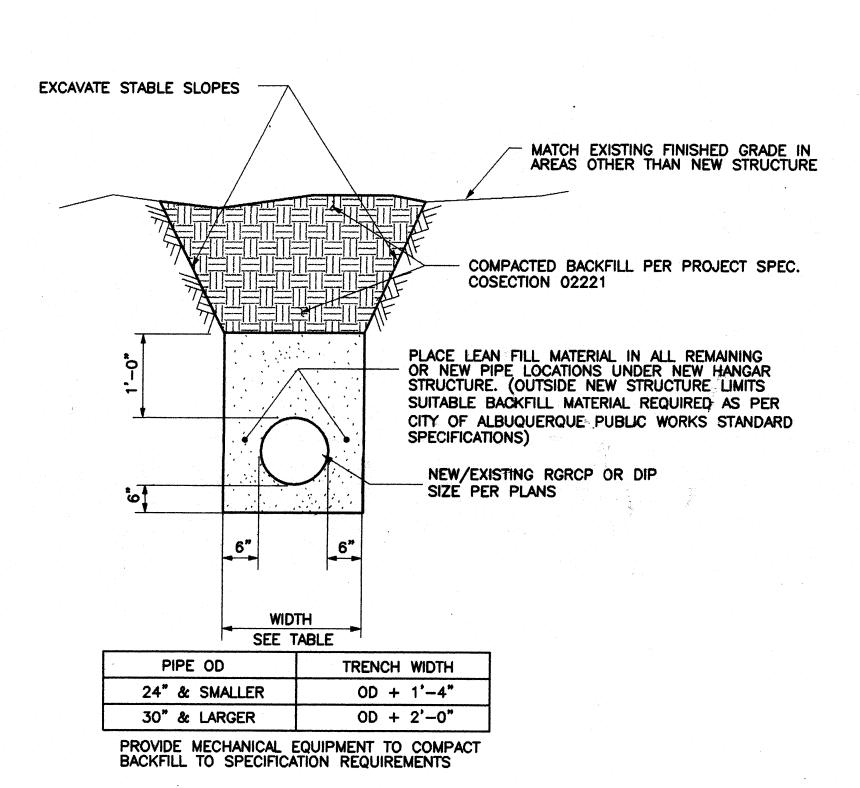


* SEE SECTIONS 129 (DUCTILE IRON PIPE), 123 (REINFORCED CONCRETE PIPE), 204 (FILL CONSTRUCTION), 207 (LEAN FILL CONSTRUCTION), AND 701 (TRENCHING, EXCAVATION, AND BACKFILL) OF CITY OF ALBUQUERQUE PUBLIC WORKS STANDARD SPECIFICATIONS.

PIPE TRENCH DETAIL SCALE: NTS

SHEET TITLE

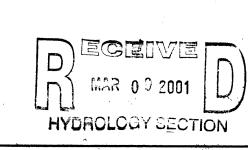

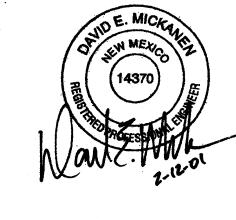


MRB DEM JLA
BY CK. APPR.

AVIATION
2503 CLARK CARR LOOP SE. ALBUQUERQUE, NM 87106 (505) 245 ~ 7555

DRAWN BY M. BALCIUS DEPT. CK. D. MICKANEN DEPT. APPR. D. MICKANEN COORD. CK. D. MICKANEN P.M. APPR. J. ATWOOD CLIENT APPR. N/A

LOCKWOOD GREENE Consulting · Design · Construction 1620 W. Fountainhead Parkway Suite 350 Tempe, Arizona 85282 (480) 829-9000 * (480) 894-8656 Fax ECLIPSE AVIATION AT SUNPORT ALBUQUERQUE INTERNATIONAL SUNPORT ALBUQUERQUE, NM. 87106

DATE 12-FEB-2001 JOB NO. 012849 REV. NO. O DWG. NO. AS NOTED

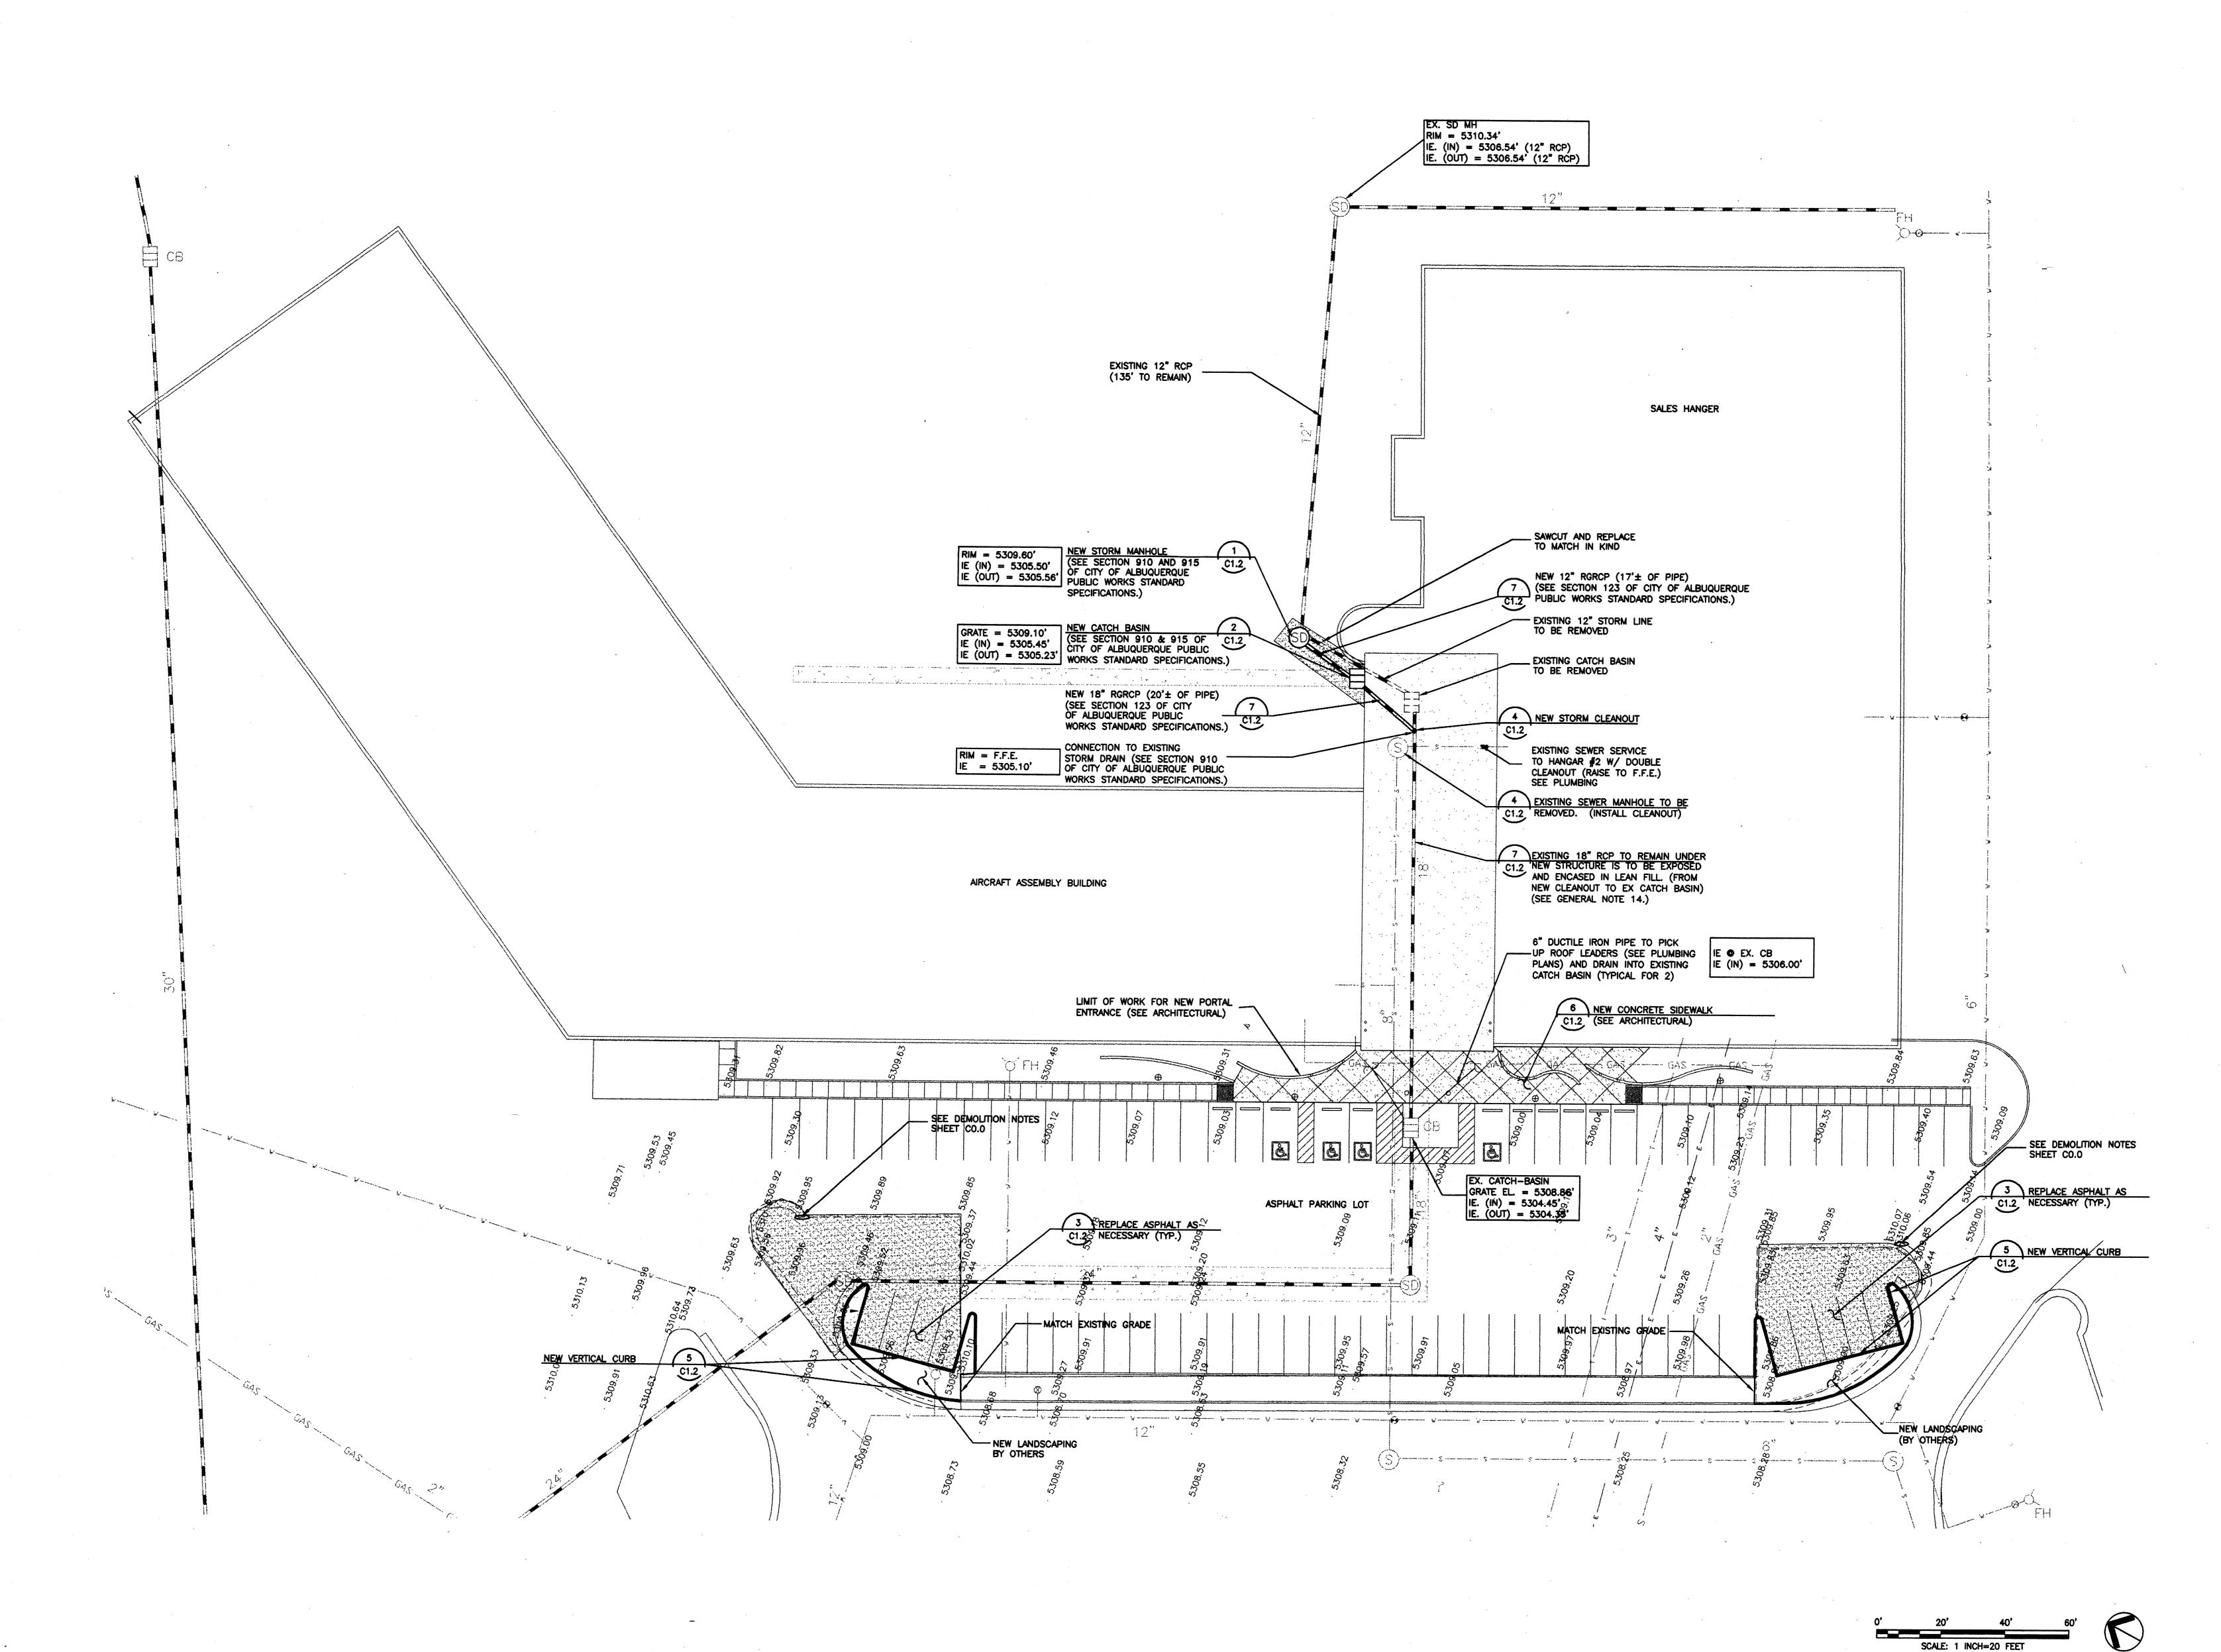





DRAWN BY M. BALCIUS

DEPT. CK. D. MICKANEN

DEPT. APPR. D. MICKANEN

COORD. CK. D. MICKANEN

P.M. APPR. J. ATWOOD

CLIENT APPR. N/A

LOCKWOOD GREENE
Consulting · Design · Construction

1620 W. Fountainhead Parkway Suite 350 Tempe, Arizona 85282
(480) 829-9000 * (480) 894-8656 Fax

GRADING & DRAINAGE
PLAN

ECLIPSE AVAITION AT SUNPORT ALBUQUERQUE, NM. 87106

JOB NO.

O12849

REV. NO.

DWG. NO.

DWG. NO.

DWG. NO.

ABBREVIATIONS:

ACRE AGGREGATE ARGON GAS ASBESTOS CEMENT BITUMINOUS BITUMINOUS COATED CORRUGATED METAL PIPE BOTTOM ELEVATION BASE OF WALL ELEVATION CABLE TELEVISION (OVERHEAD)
CABLE TELEVISION (UNDERGROUND)
CAST IRON SOIL PIPE CATCH BASIN CHILLED WATER CHILLED WATER RETURN COLUMN COMPRESSED AIR
CONCRETE MASONRY UNIT CONDENSATE CORRUGATED METAL PIPE CURB AND GUTTER DITCH BOTTOM DOMESTIC WATER DUCTILE IRON PIPE EDGE OF PAVEMENT LECTRICAL CABLE (OVERHEAD)
LECTRICAL CABLE (UNDERGROUND)
LECTRICAL MANHOLE LEVATION LEVATION EXISTING **EXPANSION** FINISH FINISH FLOOR FINISH FLOOR ELEVATION FLARED END SECTION MAIN GALLONS PER MINUTE GALVANIZED STEEL **GUTTER ELEVATION** HEADWALL HIGH DENSITY POLYETHYLENE HIGH POINT HOT WATER HOT WATER RETURN HYDROGEN GAS

GENERAL NOTES

INSIDE DIAMETER INVERT ELEVATION

MECHANICAL JOINT

NON-REINFORCED CONCRETE PIPE NOT APPLICABLE

LINEAR FEET

LOW POINT

MANHOLE

MAXIMUM

MONUMENT

NITROGEN GAS

NOT IN CONTRACT

ON CENTER OUTSIDE DIAMETER OXYGEN GAS

POINT OF CURVE POINT OF FROG

POLYETHYLENE

POTABLE WATER

PROPERTY LINE

REINFORCEMENT

RIGHT OF WAY

STATION

TOP OF

WIDE

SQUARE FEET

TOP ELEVATION

POINT OF INTERSECTION

PREFORMED JOINT FILLER POINT OF VERTICAL CURVE

POLYVINYL CHLORIDE PIPE

POINT OF VERTICAL INTERSECTION

POINT OF VERTICAL TANGENCY

POUNDS PER SQUARE FEET POUNDS PER SQUARE INCH

REINFORCED CONCRETE PIPE

SANITARY SEWER (GRAVITY)

TELEPHONE CABLE (UNDERGROUND)
TEMPORARY BENCH MARK

STORM DRAIN SEWER

TOP OF CURB ELEVATION
TOP OF GRATE ELEVATION
TOP OF WALL ELEVATION
TRENCH DRAIN

TOP OF SLAB ELEVATION TOP AND BOTTOM

VERTICAL CURVE VITRIFIED CLAY PIPE

RUBBER-GASKET REINFORCED CONCRETE PIPE

POINT OF SWITCH POST INDICATOR VALVE

POINT OF TANGENCY

NOT TO SCALE

NUMBER

PAVEMENT

1. ALL EXISTING SITE INFORMATION: TOPOGRAPHY, BUILDING LOCATIONS, ROADS & PAVEMENT LOCATIONS AND SITE UTILITIES, WERE OBTAINED FROM A SURVEY PREPARED BY: SURV-TEK, INC., 5643 PARADISE BLVD. N.W., ALBUQUERQUE, NM 87114 CALLED TOPOGRAPHIC/DESIGN SURVEY OF ECLIPSE AVIATION, ALBUQUERQUE INTERNATIONAL AIRPORT, BERNALILLO COUNTY, NM AND DATED FEBRUARY 8, 2001.

2. THE INFORMATION SHOWN ON THESE DRAWINGS CONCERNING TYPE AND LOCATION OF UNDERGROUND AND OTHER UTILITIES IS NOT GUARANTEED TO BE ACCURATE OR ALL-INCLUSIVE. THE CONTRACTOR IS RESPONSIBLE FOR MAKING HIS OWN DETERMINATIONS AS TO THE TYPE AND LOCATION OF UNDERGROUND AND OTHER UTILITIES AS MAY BE NECESSARY TO AVOID DAMAGE THERETO. CONTRACTOR SHALL USE EXTREME CARE WHEN PERFORMING ANY DEMOLITION OR GRADING OPERATIONS IN THE PROXIMITY OF THESE EXISTING UTILITIES. ANY DAMAGE TO EXISTING UTILITIES WILL BE REPAIRED AT THE CONTRACTOR'S EXPENSE. NOTIFY OWNER WHEN ANY UNIDENTIFIED UTILITIES ARE

3. VISIT THE SITE AND MAKE ALL INVESTIGATIONS NECESSARY TO DETERMINING THE EXTENT OF THE WORK REQUIRED TO CONSTRUCT THE PROJECT.

4. ANY DAMAGE TO EXISTING IMPROVEMENTS, SUCH AS, BUT NOT LIMITED TO, DRAINAGE, UTILITIES, PAVEMENT, STRIPING, CURB, ETC. CAUSED BY THE CONTRACTOR DURING CONSTRUCTION, SHALL BE REPAIRED BY THE CONTRACTOR AT NO ADDITIONAL COST TO THE

5. OBTAIN WRITTEN AUTHORIZATION FROM THE OWNER'S REPRESENTATIVE AND FROM THE UTILITY OWNERS PRIOR TO INTERRUPTING ANY EXISTING UTILITY (IE: WATER, SEWER, GAS, ELECTRICAL, OR TELEPHONE).

6. CONSTRUCTION ACCESS TO BE AT DESIGNATED LOCATION ONLY.

ALL WORK SHALL COMPLY WITH APPLICABLE STATE, FEDERAL AND LOCAL CODES. ALL NECESSARY LICENSES SHALL BE OBTAINED BY THE CONTRACTOR AT HIS EXPENSE. 8. DEVIATIONS FROM THESE PLANS AND SPECIFICATIONS WITHOUT WRITTEN CONSENT OF THE ARCHITECT/ENGINEER MAY BE CAUSE FOR THE WORK TO BE UNACCEPTABLE TO THE ENGINEER.

9. CONTRACTOR IS RESPONSIBLE FOR OBTAINING AND ADHERING TO THE CITY OF ALBUQUERQUE DEPARTMENT OF PUBLIC WORKS STANDARD DETAILS AND SPECIFICATIONS. 10. CONTRACTOR SHALL BE RESPONSIBLE FOR VERIFICATION OF ALL MEASUREMENTS AND

DIMENSIONS PRIOR TO ORDERING ANY MATERIALS OR CONDUCTING ANY WORK. 11. ARCHITECT/ENGINEER SHALL BE NOTIFIED A MINIMUM OF FORTY-EIGHT (48) HOURS FOR SITE INSPECTIONS, TESTING VERIFICATIONS, AND FOR ANY OTHER PORTION OF THE

WORK REQUIRING ENGINEERS SERVICES AT SITE. 12. ALL WORK SHALL BE PERFORMED IN ACCORDANCE WITH THE LATEST EDITION OF THE CITY OF ALBUQUERQUE PUBLIC WORKS STANDARDS AND SPECIFICATIONS.

13. AGGREGATE BASE COURSE MATERIAL SHALL BE IN ACCORDANCE WITH CITY OF ALBUQUERQUE PUBLIC WORKS STANDARD DETAILS AND SPECIFICATIONS AND HAVE A MINIMUM THICKNESS OF 6 INCHES COMPACTED TO 95% OF MAXIMUM DRY DENSITY AS INDICATED BY ASTM D1557, UNLESS OTHERWISE INDICATED ON THE PLANS.

14. CONTRACTOR SHALL ENCASE ALL STORM SEWER WITHIN LIMITS OF NEW STRUCTURE 'EXISTING OR NEW) IN LEAN FILL MATERIAL. LEAN FILL SHALL BE A MIXTURE OF PORTLAND CEMENT, AGGREGATE AND WATER HAVING A SLUMP OF 7±1 PER ASTM C-143 AND SHALL BE AS PER CITY OF ALBUQUERQUE PUBLIC WORKS STANDARD SPECIFICATIONS SECTION

SECTION AND DETAIL IDENTIFICATION:

SECTION NUMBER OR DETAIL LETTER ---

SECTION OR DETAIL

DWG WHERE SECTION OR DETAIL IS DRAWN -

* NOT ALL SYMBOLS SHOWN ARE APPLICABLE TO THIS PROJECT. ** SEE ABBREVIATIONS LISTING FOR UTILITY IDENTIFICATION.

PROJECT INFORMATION

ADDRESS: 2503 CLARK CARR LOOP SE ALBUQUERQUE, NEW MEXICO 87106

ZONING CLASSIFICATION: BUILDING CODE:

UBC - 1997 / ALBUQUERQUE UAC

CONSTRUCTION TYPE: SITE AREA:

348,562 S.F. OR 7.88 ACRES±

TOTAL CROSS-BLDG. AREA: OCCUPANCY CLASSIFICATION: F-1, B

OWNER/DEVELOPER:

ECLIPSE AVIATION, INC.
ECLIPSE FACILITY
2503 CLARK CARR LOOP SE
ALBUQUERQUE, NEW MEXICO 87106
ATTN.: DOUG LANE
505-245-7555
FAX 505-245-7888

ENGINEER/ARCHITECT: LOCKWOOD GREENE 1620 W. FOUNTAINHEAD PARKWAY SUITE 350 TEMPE, ARIZONA 85282 ATTN.: DAVID E. MICKANEN, PE 480-829-9000 FAX 480-894-8656

CIVIL SHEET INDEX

LEGEND, SYMBOLS, AND NOTES GRADING AND DRAINAGE PLAN DETAILS

C1.0

UTILITY NOTES

1. ALL FIRE PROTECTION AND POTABLE WATER LINES SHALL HAVE A MINIMUM 3.0' OF 2. SEE MECHANICAL AND PLUMBING DRAWINGS FOR CONTINUATION OF UTILITY LINES WITHIN

5' OF THE LIMITS OF THE BUILDING. 3. SEE ELECTRICAL SITE PLAN FOR LOCATION OF LIGHT POLES, POWER POLES, POWER

LINES, COMMUNICATION LINES AND DUCT BANKS. 4. VERIFY LOCATIONS AND INVERT ELEVATIONS AT ALL PIPE CROSSINGS, INTERSECTIONS, PLUGS, BENDS, AND ENDS OF PIPE FOR ALL NEW UTILITY CONSTRUCTION AND ANY EXISTING LINES PRIOR TO START OF CONSTRUCTION. MAKE MODIFICATIONS, IF REQUIRED,

TO ENSURE THE CLEARANCE BETWEEN ALL UTILITIES IS ADEQUATE, MEETS SPECIFICATIONS,

AND TO AVOID CONFLICTS. 5. THE TOP ELEVATION OF MANHOLES CONSTRUCTED IN PAVED AREAS SHALL MATCH FINISH GRADE. THE TOP ELEVATION OF MANHOLES CONSTRUCTED IN GRASS AREAS SHALL BE SIX (6") INCHES ABOVE FINISH GRADE.

6. CONTRACTOR SHALL GROUT AROUND ALL PIPE ENTRANCES TO SEWER MANHOLES WITH NON-SHRINKING GROUT TO ASSURE WATER-TIGHT CONNECTION.

7. CONTRACTOR SHALL COORDINATE INSPECTION WITH APPROPRIATE AUTHORITIES PRIOR TO COVERING TRENCHES AT INSTALLATION. 8. CONSTRUCTION SHALL COMPLY WITH GOVERNING CODES AND REQUIREMENTS.

CONTRACTOR SHALL CONDUCT ALL REQUIRED TESTS TO THE SATISFACTION OF THE UTILITY

9. CONTRACTOR SHALL COMPLY TO THE FULLEST EXTENT WITH THE LATEST STANDARDS OF OSHA DIRECTIVES, INCLUDING 29 CFR PART 1926 SUBPART P, OR ANY OTHER AGENCY HAVING JURISDICTION FOR EXCAVATION AND TRENCHING PROCEDURE. (SEE CITY OF ALBUQUERQUE PUBLIC WORKS STANDARD SPECIFICATIONS) CONTRACTOR SHALL USE SUPPORT SYSTEMS, SLOPING, BENCHING AND OTHER MEANS OF PROTECTION. THIS IS TO INCLUDE, BUT NOT LIMITED FOR ACCESS AND EGRESS FROM ALL EXCAVATION AND

COMPANIES AND OWNERS INSPECTING AUTHORITIES.

10. NEW DUCTILE IRON PIPE AND FITTINGS SHALL BE AS PER PROJECT SPEC SECTION 02555 AND IN ACCORDANCE WITH CITY OF ALBUQUERQUE PUBLIC WORKS SPECIFICATIONS

FRENCHING. CONTRACTOR IS RESPONSIBLE TO COMPLY WITH PERFORMANCE CRITERIA FOR

11. NEW DOMESTIC WATER SERVICE LINE SHALL BE IN ACCORDANCE WITH CITY OF ALBUQUERQUE PUBLIC WORKS SPECIFICATIONS AND DETAILS.

12. NEW FIRE LINE INSTALLATION SHALL CONFORM TO THE APPLICABLE CITY OF ALBUQUERQUE STANDARD SPECIFICATIONS AND DETAILS AND SHALL BE CONSTRUCTED OF DUCTILE IRON PIPE.

ALBUQUERQUE PUBLIC WORKS SPECIFICATIONS AND DETAILS. 14. ALL SEWER CONNECTIONS AND CLEAN OUT CONSTRUCTION SHALL CONFORM TO CITY OF ALBUQUERQUE PUBLIC WORKS SPECIFICATIONS AND DETAILS. EXISTING SEWER TAPS ARE

13. BEDDING AND BACK FILL FOR SANITARY SEWER LATERALS SHALL CONFORM TO CITY OF

15. THRUST BLOCKS FOR WATER LINES SHALL BE IN ACCORDANCE WITH CITY OF ALBUQUERQUE PUBLIC WORKS DETAIL 2320.

16. NEW STORM SEWER PIPES, JOINTS, SPECIALS, AND MANHOLES SHALL BE INSTALLED IN ACCORDANCE WITH CITY OF ALBUQUERQUE PUBLIC WORKS SPECIFICATIONS SECTIONS 910 AND 915 AND ALL ASSOCIATED DETAILS.

17. FIRE HYDRANTS SHALL BE INSTALLED IN ACCORDANCE WITH CITY OF ALBUQUERQUE PUBLIC WORKS SPECIFICATION AND ALL ASSOCIATED DETAILS.

18. SANITARY AND STORM SEWER MANHOLES SHALL CONFORM TO CITY OF ALBUQUERQUE PUBLIC WORKS SPECIFICATION SECTION 920 AND ALL ASSOCIATED DETAILS. 19. NEW RGRCP STORM SEWER PIPE SHALL CONFORM WITH ASTM C-76 FOR CLASS III STRENGTH AND SHALL COMPLY WITH PROJECT SPEC. SECTION 02500 AND BE ACCORDANCE WITH CITY OF ALBUQUERQUE PUBLIC WORKS SPECIFICATION SECTIONS 123, 910, AND 915 AND ALL ASSOCIATED DETAILS.

20. PORTLAND CEMENT CONCRETE SHALL BE 3,000 PSI TYPE II CEMENT CONCRETE AS PER PROJECT SPEC. 03300 AND CITY OF ALBUQUERQUE PUBLIC WORKS SPECIFICATION

DEMOLITION NOTES

1. DEMOLITION TO CONFORM TO CITY OF ALBUQUERQUE PUBLIC CODES. 2. VISIT SITE AND DETERMINE EXTENT OF DEMOLITION REQUIRED.

3. COORDINATE DEMOLITION WORK WITH WORK ALREADY UNDER CONTRACT AND SCHEDULE ACTIVITIES WITH CONTRACTOR. COORDINATE DEMOLITION TO ACCOMMODATE OWNER'S OPERATIONS AND MAINTAIN SITE SECURITY/SAFETY.

4. DISPOSE OF UNSALVAGED DEMOLISHED MATERIALS OFF SITE IN A LEGAL MANNER. 5. STOCKPILE SALVAGED DEMOLISHED MATERIALS ON SITE AS DIRECTED BY CONTRACTOR.

6. LOCATE AND MARK ALL EXISTING UTILITY LINES TO BE ABANDONED AND OBTAIN CONTRACTOR APPROVAL PRIOR TO DEMOLITION.

7. PLUG OPEN ENDS OF ABANDONED GRAVITY UTILITY LINES WITH CONCRETE. USE SUITABLE PLUG WITH CONCRETE THRUST BLOCKING (NFPA 24) FOR PRESSURE PIPE. 8. DEMOLISH EXISTING UNDERGROUND UTILITIES INDICATED TO BE ABANDONED AS REQUIRED TO FACILITATE PROPOSED CONSTRUCTION.

9. DO NOT DISTURB EXISTING UTILITIES TO REMAIN IN SERVICE. DO NOT REMOVE EXISTING UTILITIES TO BE DEMOLISHED UNTIL PROPOSED UTILITY CONSTRUCTION IS COMPLETED AND IN SERVICE. DEMOLISH OR ABANDON EXISTING UTILITIES AS INDICATED AFTER PROPOSED INSTALLATION IS TESTED AND ACCEPTED BY

10. SAW CUT EXISTING PAVEMENT AT LIMITS OF DEMOLITION OR REMOVE TO THE NEXT NEAREST JOINT BEYOND LIMITS OF DEMOLITION, IF CONCRETE. REPLACE PAVEMENT WHEN REMOVAL EXTENDS BEYOND LIMITS OF DEMOLITION.

11. REPAIR OR REPLACE DAMAGED ITEMS NOT DESIGNATED TO BE DEMOLISHED. RESTORE TO ORIGINAL CONDITION AS DIRECTED BY CONTRACTOR AT NO ADDITIONAL COST

12. POLLUTION CONTROLS: USE WATER SPRINKLING AND OTHER SUITABLE METHODS AS NECESSARY TO LIMIT THE AMOUNT OF DUST AND DIRT RISING AND SCATTERING IN THE AIR, TO THE LOWEST LEVEL OF AIR POLLUTION PRACTICAL FOR THE CONDITION OF WORK.

13. WORK TO BE DEMOLISHED BY CONTRACTOR IS SHOWN ON THE GRADING AND DRAINAGE PLAN AS GREY AND DASHED LINETYPE.

GRADING AND DRAINAGE NOTES

WILL ALSO REQUIRE A GRADING AND DRAINAGE PERMIT.

HAUL PERMITS, WHEN REQUIRED, MUST BE OBTAINED PRIOR TO OR CONCURRENTLY WITH THE GRADING AND DRAINAGE PERMIT. 2. EXCAVATION CONTRACTOR MUST GIVE LOCATION FOR WASTING EXCESS EXCAVATION AND A LETTER FROM THE OWNER GIVING PERMISSION FOR DUMPING PRIOR TO STARTING ONSITE CONSTRUCTION. IF EXCESS EXCAVATION EXCEEDS 100 CUBIC YARDS, THE DISPOSAL SITE

3. CONTACT MR. JIM HINDE WITH THE CITY OF ALBUQUERQUE SUNPORT AUTHORITY 48 HRS BEFORE ANY ON-SITE AND/OR OFF-SITE CONSTRUCTION BEGINS, TELEPHONE (505)

4. AN APPROVED GRADING AND DRAINAGE PLAN SHALL BE KEPT ON THE JOBSITE AT ALL TIMES. DEVIATION FROM THE PLAN MUST BE PRECEDED BY AN APPROVED PLAN REVISION. 5. GRADING AND DRAINAGE PLAN APPROVAL INCLUDES THE CONSTRUCTION OF ALL SURFACE IMPROVEMENTS SHOWN ON THE APPROVED PLAN, INCLUDING, BUT NOT LIMITED TO, RETENTION AREAS, SEDIMENTATION BASINS, AND/OR OTHER DRAINAGE FACILITIES, DRAINAGE PATTERNS, WALLS, CURBS, ASPHALT PAVEMENT, AND BUILDING FLOOR

6. ALL DRAINAGE PROTECTIVE DEVICES SUCH AS SWALES, INTERCEPTOR DITCHES, PIPES, PROTECTIVE BERMS, BARRIER WALLS, CONCRETE CHANNELS, OR OTHER MEASURES DESIGNED TO PROTECT ADJACENT BUILDINGS OR PROPERTY FROM STORM RUNOFF MUST BE COMPLETED PRIOR TO BUILDING CONSTRUCTION.

7. DAMAGED AND/OR DISPLACED CONCRETE CURB, GUTTER, SIDEWALK, OR DRIVEWAY SLAB THAT IS WITHIN THE RIGHT-OF-WAY SHALL BE REPAIRED OR REPLACED, AS NOTED BY CITY INSPECTORS, BEFORE FINAL ACCEPTANCE OF THE WORK.

8. CONSTRUCTION WITHIN THE RIGHT-OF-WAY SHALL CONFORM TO THE LATEST APPLICABLE CITY OF ALBUQUERQUE STANDARD SPECIFICATIONS FOR PUBLIC WORKS CONSTRUCTION. 9. COMPACTION SHALL COMPLY WITH CITY OF ALBUQUERQUE STANDARD SPECIFICATIONS

10. OBSTRUCTIONS TO PROPOSED IMPROVEMENTS IN THE RIGHT-OF-WAY SHALL BE REMOVED OR RELOCATED BEFORE BEGINNING CONSTRUCTION OF THE PROPOSED

11. CONTRACTOR SHALL MAKE ADJUSTMENTS TO PAVING AND GRADING ELEVATIONS AS NECESSARY TO INSURE A SITE FREE OF DRAINAGE PROBLEMS. 12. CONTRACTOR SHALL SAWCUT EXISTING PAVEMENT FOR NEW WORK. NEW PAVEMENT SHALL GRADE TO DRAIN AND MATCH EXISTING PAVEMENT ELEVATIONS WHERE NEW MEETS

PROPOSED BUILDING ASPHALT PAVEMENT ASPHALT OVERLAY CONCRETE ____xx-___xx-___ FENCE ----STORM DRAIN 9891 T. T. 1000 T. T. 1008 T. T. 11 T. 1008 TRENCH DRAIN SANITARY SEWER FIRE PROTECTION WATER PIPE NATURAL GAS UNDERGROUND ELECTRIAL UNDERGROUND TELEPHONE WATER METER \bigcirc MANHOLE GRATE INLET CURB AND GUTTER FIRE HYDRANT WATER VALVE 1109.1 SPOT ELEVATIONS x 1108.2 INVERT ELEVATION DUCTILE IRON PIPE RUBBER GASKET REINFORCED CONCRETE PIPE **ELEVATION** FINISH FLOOR FINISH GRADE


EDGE OF PAVEMENT

HIGH POINT

CLEAN OUT

GRATE

CITY LEGEND

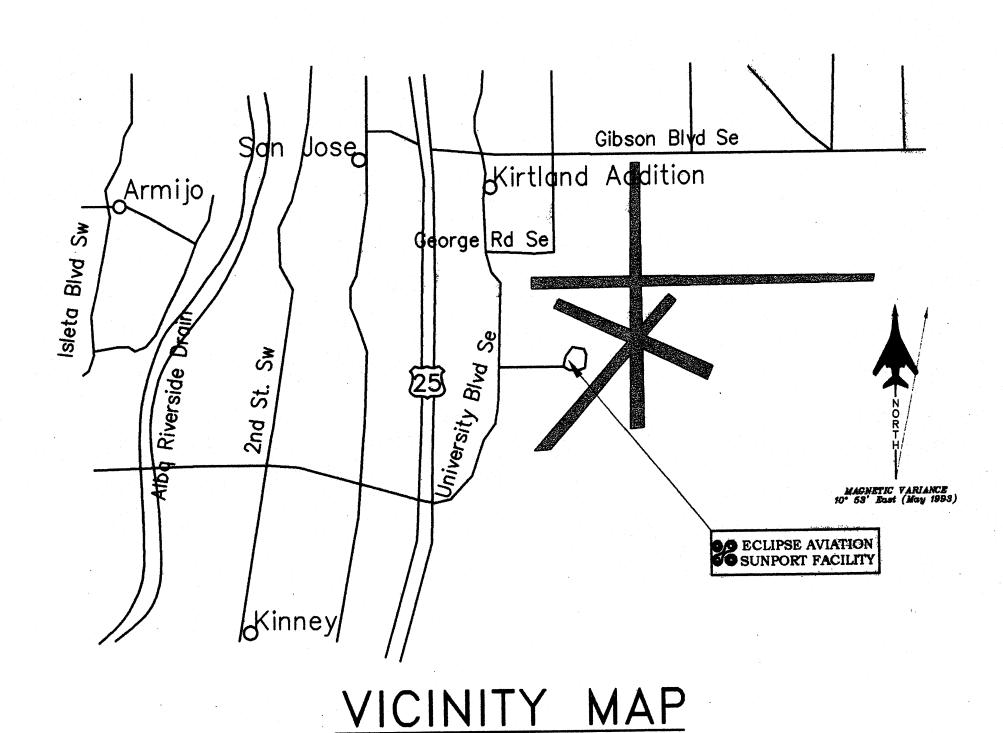


DRAINAGE SCOPE:

THE SCOPE OF WORK INCLUDED IN THE DESIGN IS THE RELOCATION OF A CATCH BASIN, THE ADDITION OF A 17 FOOT LENGTH OF 12" RGRCP, THE ADDITION OF A 20 FOOT LENGTH OF 18" RGRCP. INSTALLING A NEW STORM DRAIN MANHOLE, AND INSTALLING A NEW CLEANOUT WHERE THE NEW STORM DRAIN TIES INTO THE EXISTING STORM DRAIN

DUE TO THE NEW SCOPE OF WORK NOT IMPACTING OR AFFECTING THE EXISTING SITE DRAINAGE, NO HYDRAULIC CALCULATIUONS ARE REQUIRED.

SHEET TITLE

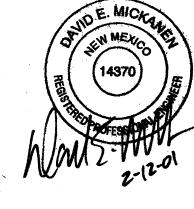

0 |12-FEB-2001|INITIAL ISSUE NO DATE REVISION BY CK. APPR.



AVIATION

2503 CLARK-CAPR LOOP SE, ALBUQUERGUE, NM 87106 (505) 245 - 7555

DRAWN BY M. BALCIUS DEPT. CK. D. MICKANEN DEPT. APPR. D. MICKANEN COORD. CK. D. MICKANEN P.M. APPR. J. ATWOOD CLIENT APPR. N/A


LOCKWOOD GREENE Consulting • Design • Construction 1620 W. Fountainhead Parkway Suite 350 Tempe, Arizona 85282

(480) 829-9000 * (480) 894-8656 Fax

LEGEND, SYMBOLS, AND NOTES

ECLIPSE AVIATION AT SUNPORT ALBUQUERQUE INTERNATIONAL SUNPORT ALBUQUERQUE, NM. 87106

DATE 12-FEB-20001 AS NOTED

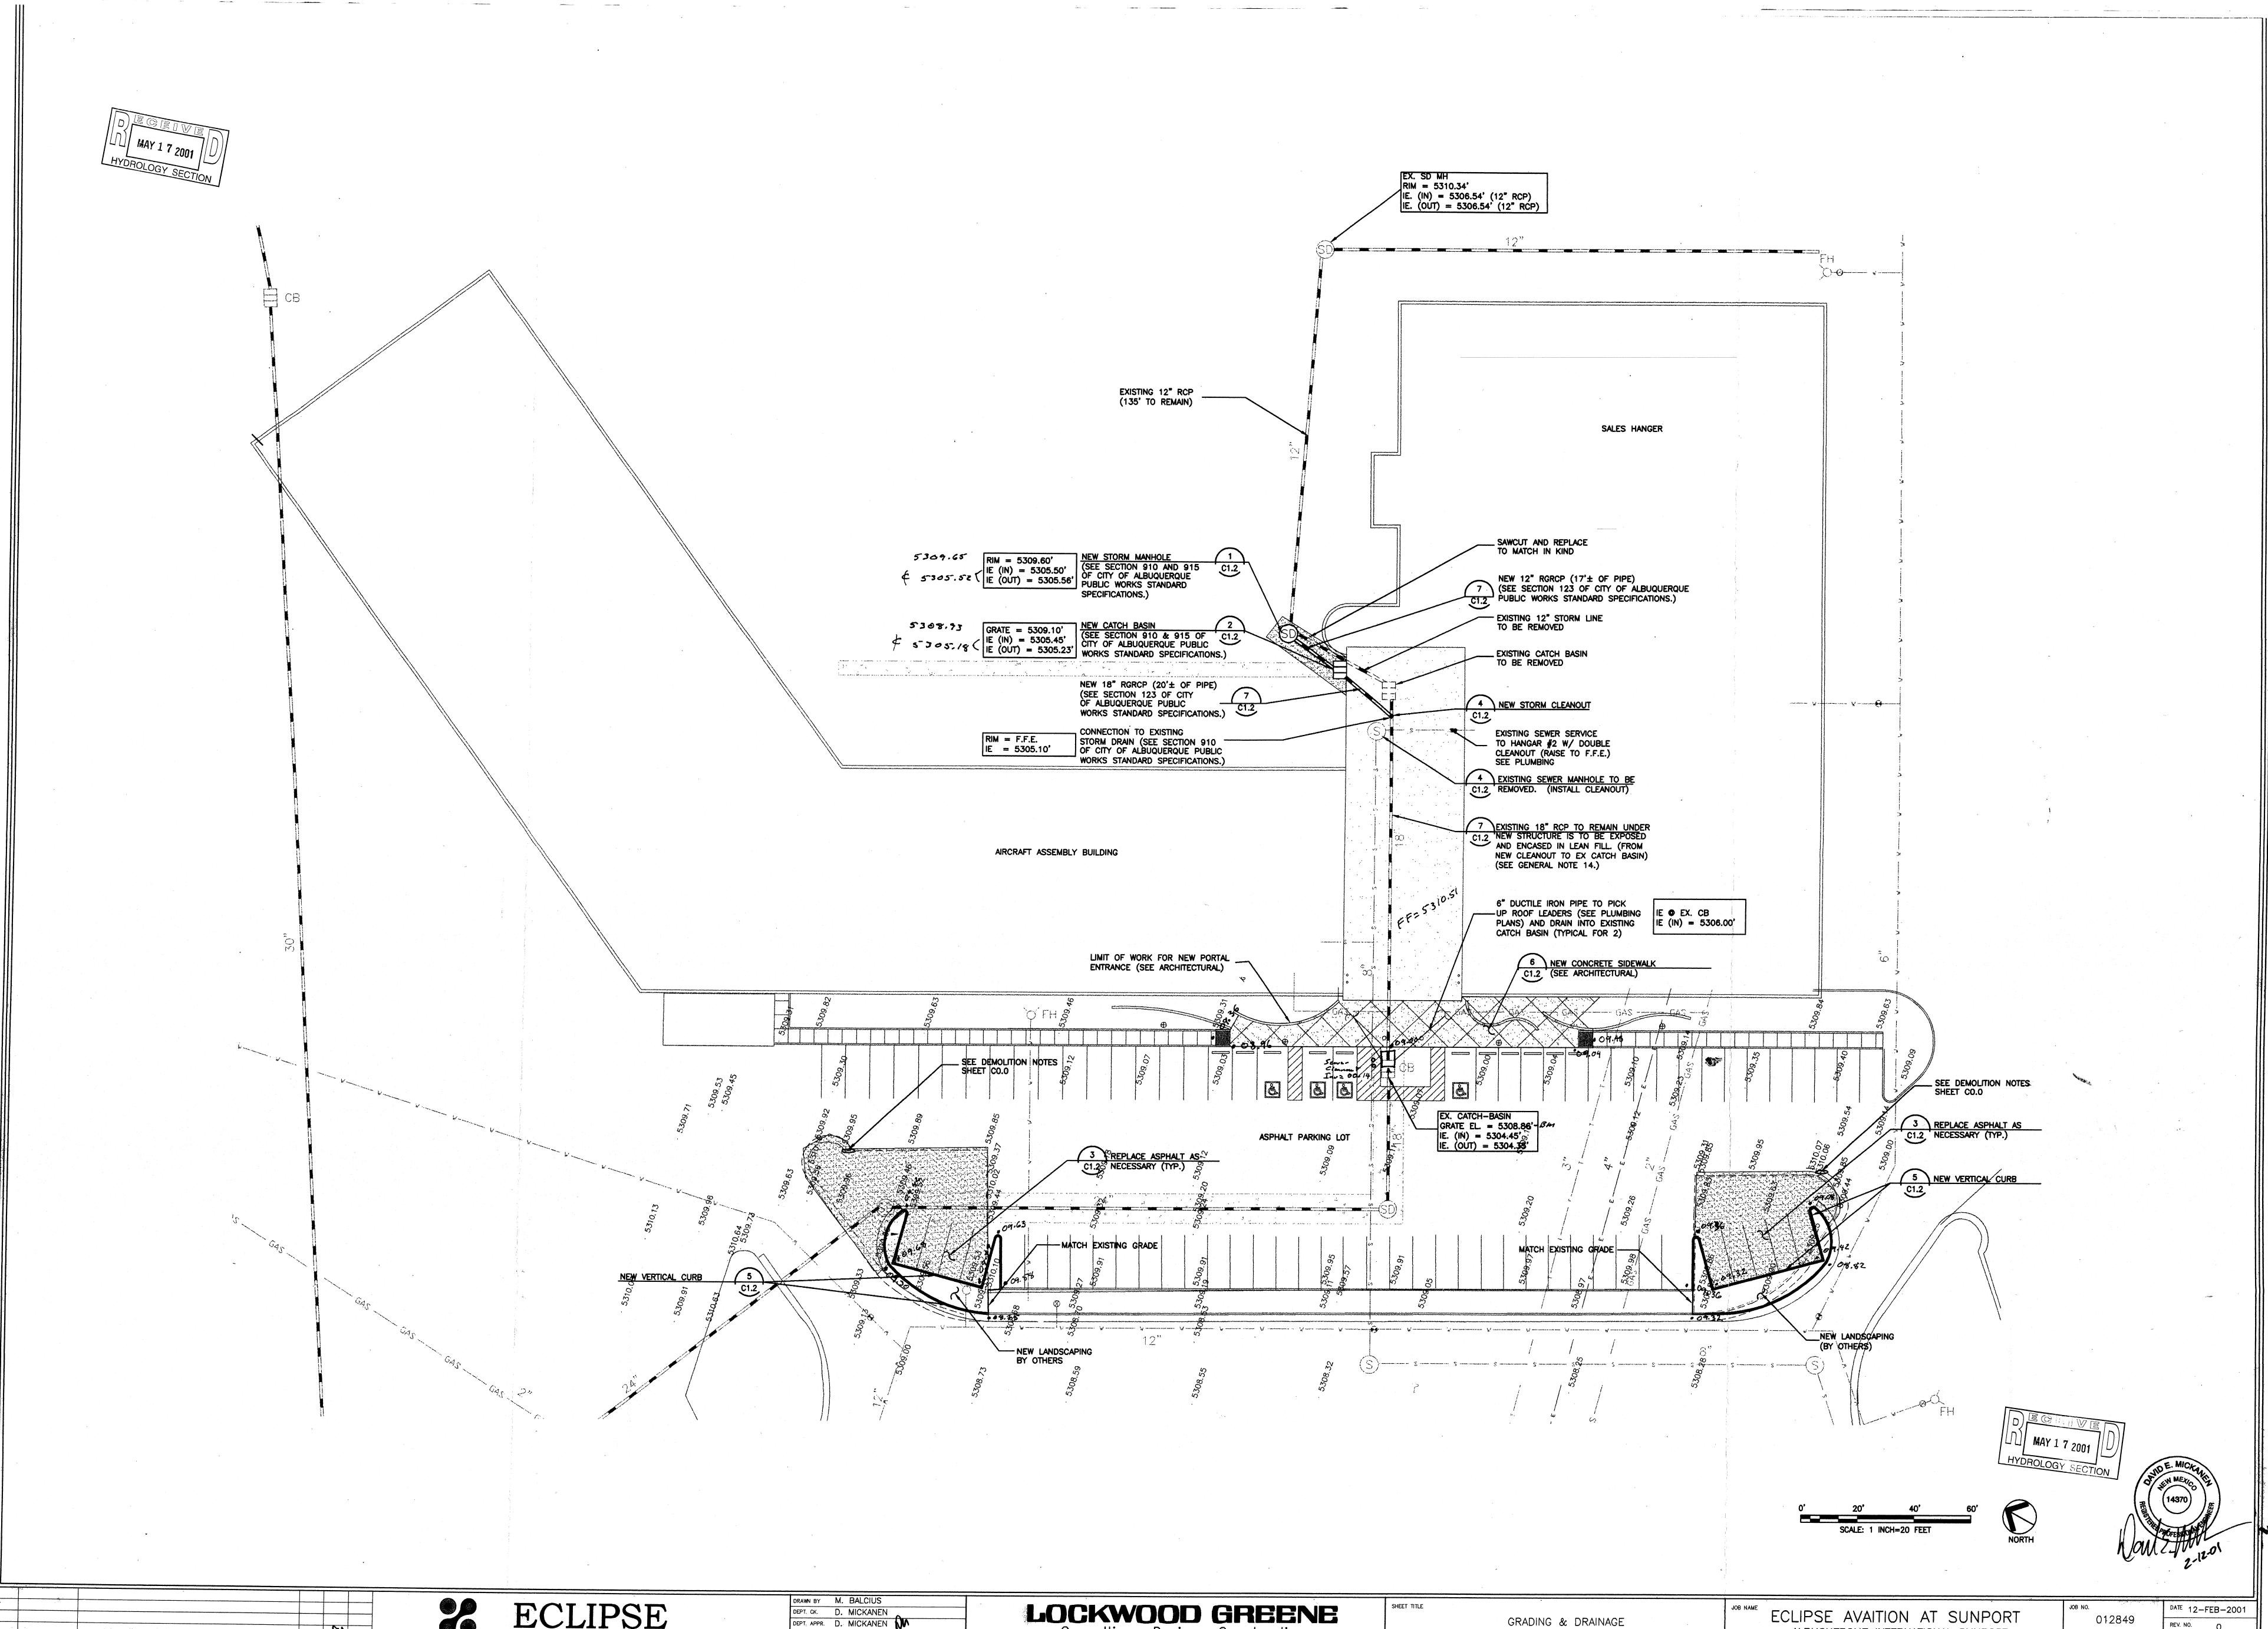

MRB DEM JLA
BY CK. APPR.

0 12-FEB-2001 INITIAL ISSUE

AVIATION
2503 CLARK CARR LOOP SE, ALBUQUERQUE, NM 87106 (505) 245 - 7555

DEPT. CK. D. MICKANEN

DEPT. APPR. D. MICKANEN COORD, CK. D. MICKANEN P.M. APPR. J. ATWOOD
CLIENT APPR. N/A

LOCKWOOD GREENE
Consulting · Design · Construction 1620 W. Fountainhead Parkway Suite 350 Tempe, Arizona 85282 (480) 829—9000 * (480) 894—8656 Fax

ECLIPSE AVAITION AT SUNPORT ALBUQUERQUE INTERNATIONAL SUNPORT ALBUQUERQUE, NM. 87106

1"=20'

EX. SD MH RIM = 5310.34' IE. (IN) = 5306.54' (12" RCP) IE. (OUT) = 5306.54' (12" RCP) RIM = 5309.60'
IE (IN) = 5305.50'
IE (OUT) = 5305.56'

NEW STORM MANHOLE

(SEE SECTION 910 AND 915
OF CITY OF ALBUQUERQUE
PUBLIC WORKS STANDARD
SPECIFICATIONS.) -- EXISTING 12" STORM LINE TO BE REMOVED GRATE = 5309.10'
| IE (IN) = 5305.45'
| IE (OUT) = 5305.23' | NEW CATCH BASIN (SEE SECTION 910 & 915 OF C1.2 CITY OF ALBUQUERQUE PUBLIC WORKS STANDARD SPECIFICATIONS.) _ EXISTING CATCH BASIN TO BE REMOVED NEW 18" RGRCP (20'± OF PIPE) (SEE SECTION 123 OF CITY OF ALBUQUERQUE PUBLIC 4 NEW STORM CLEANOUT WORKS STANDARD SPECIFICATIONS.) C1.2 CONNECTION TO EXISTING EXISTING SEWER SERVICE RIM = F.F.E. IE = 5305.10' STORM DRAIN (SEE SECTION 910 TO SEE SECTION 910 TO TO HANGAR #2 W/ DOUBLE CLEANOUT (RAISE TO F.F.E.) WORKS STANDARD SPECIFICATIONS.) SEE PLUMBING 4 EXISTING SEWER MANHOLE TO BE C1.2 REMOVED. (INSTALL CLEANOUT) 7 EXISTING 18" RCP TO REMAIN UNDER
C1.2 NEW STRUCTURE IS TO BE EXPOSED
AND ENCASED IN LEAN FILL. (FROM
NEW CLEANOUT TO EX CATCH BASIN)
(SEE GENERAL NOTE 14.) AIRCRAFT ASSEMBLY BUILDING 6" DUCTILE IRON PIPE TO PICK

UP ROOF LEADERS (SEE PLUMBING PLANS) AND DRAIN INTO EXISTING (IN) = 5306.00' CATCH BASIN (TYPICAL FOR 2) LIMIT OF WORK FOR NEW PORTAL ENTRANCE (SEE ARCHITECTURAL) 6 NEW CONCRETE SIDEWALK
C1.2 (SEE ARCHITECTURAL) SEE DEMOLITION NOTES SEE DEMOLITION NOTES EX. CATCH-BASIN 3 REPLACE ASPHALT AS C1.2 NECESSARY (TYP.) GRATE EL. = 5308.86' IE. (IN) = 5304.45'0; IE. (OUT) = 5304.38' ASPHALT PARKING LOT 5 NEW VERTICAL CURB - MATCH EXISTING GRADE MATCH EXISTING GRADE -NEW LANDSCAPING BY OTHERS DRAWN BY M. BALCIUS
DEPT. CK. D. MICKANEN LOCKWOOD GREENE
Consulting · Design · Construction SHEET TITLE DATE 12-FEB-2001 ECLIPSE AVAITION AT SUNPORT 012849 GRADING & DRAINAGE DEPT. APPR. D. MICKANEN ALBUQUERQUE INTERNATIONAL SUNPORT ALBUQUERQUE, NM. 87106 AVIATION
2503 CLARK CARR LOOP SE, ALBUQUERQUE, NM 87106 (505) 245 - 7555 COORD. CK. D. MICKANEN O 12-FEB-2001 INITIAL ISSUE
NO DATE P.M. APPR. J. ATWOOD

CLIENT APPR. N/A 1620 W. Fountainhead Parkway Suite 350 Tempe, Arizona 85282 (480) 829-9000 * (480) 894-8656 Fax

1"=20'