

DISPOSAL OR BORROW SITE AND HAUL TO OR FROM SHALL BE CONSIDERED INCIDENTAL TO THE PROJECT AND NO SEPARATE MEASUREMENT OR PAYMENT SHALL BE MADE.

7. VERIFY ALL ELEVATIONS SHOWN ON PLAN FROM BASIS OF ELEVATION CONTROL


8. ALL CURB IS 6" MEDIAN CURB UNLESS OTHERWISE NOTED. ALL ELEVATIONS ARE

9. ALL ELEVATIONS SHOWN ALONG MEDIAN CURB ARE AT FLOWLINE UNLESS OTHERWISE

TAKEN AT THE FLOWLINE OF THE CURB UNLESS OTHERWISE NOTED.

STATION PRIOR TO BEGINNING CONSTRUCTION.

INDICATED.

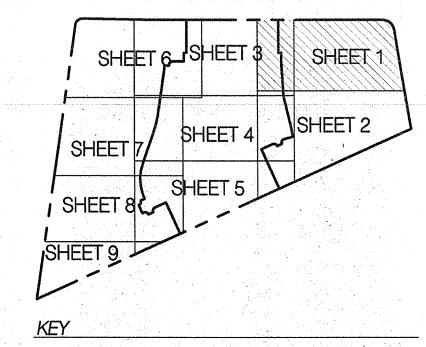

## GENERAL NOTES

1. ALL WORK DETAILED ON THESE PLANS AND PERFORMED UNDER THIS CONTRACT SHALL BE CONSTRUCTED IN ACCORDANCE WITH THE PROJECT SPECIFICATIONS AND THE PROJECT GEOTECHNICAL REPORT. WHERE APPLICABLE, CITY OF ALBUQUERQUE PUBLIC WORKS STANDARD

2. THE CONTRACTOR SHALL ABIDE BY ALL LOCAL, STATE, AND FEDERAL LAWS, RULES AND REGULATIONS WHICH APPLY TO THE CONSTRUCTION OF THESE IMPROVEMENTS, INCLUDING EPA REQUIREMENTS WITH RESPECT TO STORM WATER DISCHARGE.

QUIREMENTS WITH RESPECT TO STORM WATER DISCHARGE.

PRIOR TO CONSTRUCTION, THE CONTRACTOR SHALL FIELD VERIFY THE HORIZONTAL AND

SHOULD A CONFLICT EXIST, THE CONTRACTOR SHALL NOTIFY THE CONSTRUCTION OBSERVER OF

4. TWO (2) WORKING DAYS PRIOR TO ANY EXCAVATION, THE CONTRACTOR SHALL CONTACT LINE LOCATING SERVICE FOR LOCATION OF EXISTING UTILITIES.

5. ALL ELECTRICAL, TELEPHONE, CABLE TV, GAS AND OTHER UTILITY LINES, CABLES, AND APPURTENANCES ENCOUNTERED DURING CONSTRUCTION THAT REQUIRE RELOCATION, SHALL BE COORDINATED WITH THAT UTILITY. THE CONTRACTOR SHALL BE RESPONSIBLE FOR COORDINATION OF ALL NECESSARY UTILITY ADJUSTMENTS. NO ADDITIONAL COMPENSATION WILL BE ALLOWED FOR DELAYS OR INCONVENIENCES CAUSED BY UTILITY COMPANY WORK CREWS. THE CONTRACTOR MAY BE REQUIRED TO RESCHEDULE HIS ACTIVITIES TO ALLOW UTILITY CREWS TO PERFORM THEIR REQUIRED WORK.

6. THE CONTRACTOR IS RESPONSIBLE FOR VERIFYING LOCATION & ELEVATION OF ALL EXISTING UTILITIES PRIOR TO CONSTRUCTION. THE CONTRACTOR IS ALSO RESPONSIBLE FOR PROTECTING ALL EXISTING UTILITY LINES WITHIN THE CONSTRUCTION AREA. ANY DAMAGE TO EXISTING FACILITIES CAUSED BY CONSTRUCTION ACTIVITY SHALL BE REPAIRED OR REPLACED AT THE CONTRACTOR'S EXPENSE AND APPROVED BY THE CONSTRUCTION OBSERVED.

7. CONSTRUCTION ACTIVITY SHALL BE LIMITED TO THE PROPERTY AND/OR PROJECT LIMITS.

ANY DAMAGE TO ADJACENT PROPERTIES RESULTING FROM THE CONSTRUCTION PROCESS SHALL

BE PERAIPED OR PEDIACED AT THE CONTRACTOR'S EXPENSE.

8. OVERNIGHT PARKING OF CONSTRUCTION EQUIPMENT SHALL NOT OBSTRUCT DRIVEWAYS OR DESIGNATED TRAFFIC LANES. THE CONTRACTOR SHALL NOT STORE ANY EQUIPMENT OR MATERIAL WITHIN THE PUBLIC RIGHT-OF-WAY.

9. THE CONTRACTOR SHALL OBTAIN ALL THE NECESSARY PERMITS FOR THE PROJECT PRIOR TO COMMENCING CONSTRUCTION (I.E., BARRICADING, TOPSOIL DISTURBANCE, EXCAVATION PERMITS, EPA STORM WATER PERMITS, ETC.).

10. ALL PROPERTY CORNERS DESTROYED DURING CONSTRUCTION SHALL BE REPLACED AT THE CONTRACTOR'S EXPENSE. ALL PROPERTY CORNERS MUST BE RESET BY A REGISTERED LAND SURVEYOR.

11. ALL BARRICADES AND CONSTRUCTION SIGNING SHALL CONFORM TO APPLICABLE SECTIONS OF THE "MANUAL ON UNIFORM TRAFFIC CONTROL DEVICES" (MUTCD), US DEPARTMENT OF TRANSPORTATION, LATEST EDITION.

12. THE CONTRACTOR SHALL MAINTAIN ALL CONSTRUCTION BARRICADES AND SIGNING AT ALL TIMES. THE CONTRACTOR SHALL VERIFY THE PROPER LOCATION OF ALL BARRICADING AT THE END AND BEGINNING OF EACH DAY.

13. THE CONTRACTOR SHALL TAKE ALL STEPS NECESSARY TO CONFORM WITH EPA REQUIREMENTS, INCLUDING COMPLIANCE WITH NPDES PHASE 2 REQUIREMENTS.

14. THE CONTRACTOR IS RESPONSIBLE FOR SWPPP PREPARATION AND IMPLEMENTATION.

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\* A. INSTALL 4' DIA. TYPE "E" MANHOLE PER COA STD. DWG.

B. RETAINING WALL BY OTHERS. SEE SHEET C2.11 FOR TYPICAL RETAINING WALL NOMENCLATURE.

\* C. INSTALL TYPE "D" SINGLE GRATE INLET, PER COA STD DWG

★ D. INSTALL PVC MEDIAN CULVERT. SEE PLAN FOR SIZE AND ELEVATIONS. SEE DETAIL SHEET C2.11.

\* E. 2' CURB CUT PER DETAIL SHEET C2.11.

\* F. MODIFIED 4' DIA. TYPE "C" MANHOLE/INLET. SEE DETAIL

\* G. MODIFIED 6' DIA. TYPE "C" MANHOLE/INLET. SEE DETAIL SHEET C2.11.

\* H. 1' RIBBON CHANNEL. SEE DETAIL SHEET C2.10.

\* I. SINGLE GRATE TYPE "A" INLET, PER COA STD DWGS

2201 & 2202.

\* J. DEBRIS TREATMENT MANHOLE SYSTEM PER DETAILS SHEET C2.11

\* K. INSTALL 6' DIA TYPE "E" MANHOLE PER COA STD DWG

L. INSTALL 4" DIA PVC SIDEWALK CULVERT.

\* M. BUILD 10' WIDE 2" AC TRAIL PER COA STD DWG 2415B

\* N. INSTALL 6" DIA PVC SIDEWALK CULVERT.

\* Not used this sheet.

MATERIALS:
SD LINE: CLASS III RCP OR HDPE (UNLESS OTHERWISE NOTED ON PLANS)

LE	GEND
	PROPERTY LINE
5301	EXISTING CONTOURS
X 5301.15	EXISTING GROUND SPOT ELEVATION
95.53	PROPOSED SPOT ELEVATION
S=2.0%	PROPOSED DIRECTION OF FLOW
	PROPOSED CURB & GUTTER
<u> </u>	PROPOSED STORM DRAIN INLET
	PROPOSED STORM DRAIN MANHOLE
	PROPOSED RETAINING WALL
- DHL	EXISTING OVERHEAD POWER LINES AND POWER POLES
	PERIMETER WALL TYPE 'A' - 3' VIEW FENCE ON TOP OF BLOCK WALL

Bohannan A Huston

No. Date Issue / Description

IT IS THE CLIENTS RESPONSIBILITY PRIOR TO OR DURING CONSTRUCTION TO NOTIFY THE ARCHITES IN WRITING OF ANY PERCEIVED ERRORS OR OMISSIONS IN THE PLANS AND SPECIFICATIONS OF WHI A CONTRACTOR THOROUGHLY KNOWLEDGEABLE WITH THE BUILDING CODES AND METHODS OF CONSTRUCTION SHOULD REASONABLY BE AWARE. WRITTEN INSTRUCTIONS ADDRESSING SUPERIOR OF OMISSIONS SHALL BE RECEIVED FROM THE ARCHITECT PRIOR TO THE CLIENT OR CLIENTS SUBCONTRACTORS PROCEEDING WITH THE WORK. THE CLIENT WILL I

Project :

DIAMOND MESA

ALBUQUERQUE, N.M.

**3** - z

1" = 20'

ACS BRASS TABLET STAMPED "TRANS" Geographic Position (NAD 1927)

N.M. State Plane Coordinates (Central Zone)

X= 354,899.45 Y= 1,471,822.67

Ground-to-Grid Factor = 0.99967921  $\Delta \alpha = -00^{\circ}16'42''$ 

SLD 1929 Elevation = 5118.43

License Stamp:



Project Contact:
Phone #:
Fax #:

Principal in Charge : Project Director : Project Designer:

Sheet Title :

Project Manager:

E-Mail:

GRADING & DRAINAGE PLAN

Sheet No. :

C2.01

Tue, 19-Jun-2012 - 2:04:pm



APPROVED FOR CONSTRUCTION WITHIN THE AMAMFCA RIGHT-OF-WAY:

P:\20120144\CDP\Plans\General\GRADING\_PLAN.dwg Tue, 19-Jun-2012 - 2:16:pm

6-21-12

. 10' WIDE AC TRAIL SHALL BE CONSTRUCTED IN ACCORDANCE WITH

WORKS CONSTRUCTION, 1986 EDITION AS REVISED THROUGH UPDATE #8.

THE CITY OF ALBUQUERQUE STANDARD SPECIFICATIONS FOR PUBLIC

Bohannan A Huston

13. THE CONTRACTOR SHALL TAKE ALL STEPS NECESSARY TO CONFORM WITH EPA


14. THE CONTRACTOR IS RESPONSIBLE FOR SWPPP PREPARATION AND IMPLEMENTATION.

REQUIREMENTS, INCLUDING COMPLIANCE WITH NPDES PHASE 2 REQUIREMENTS.


EXISTING BARBED WIRE FENCE

Sheet No.

C2.02

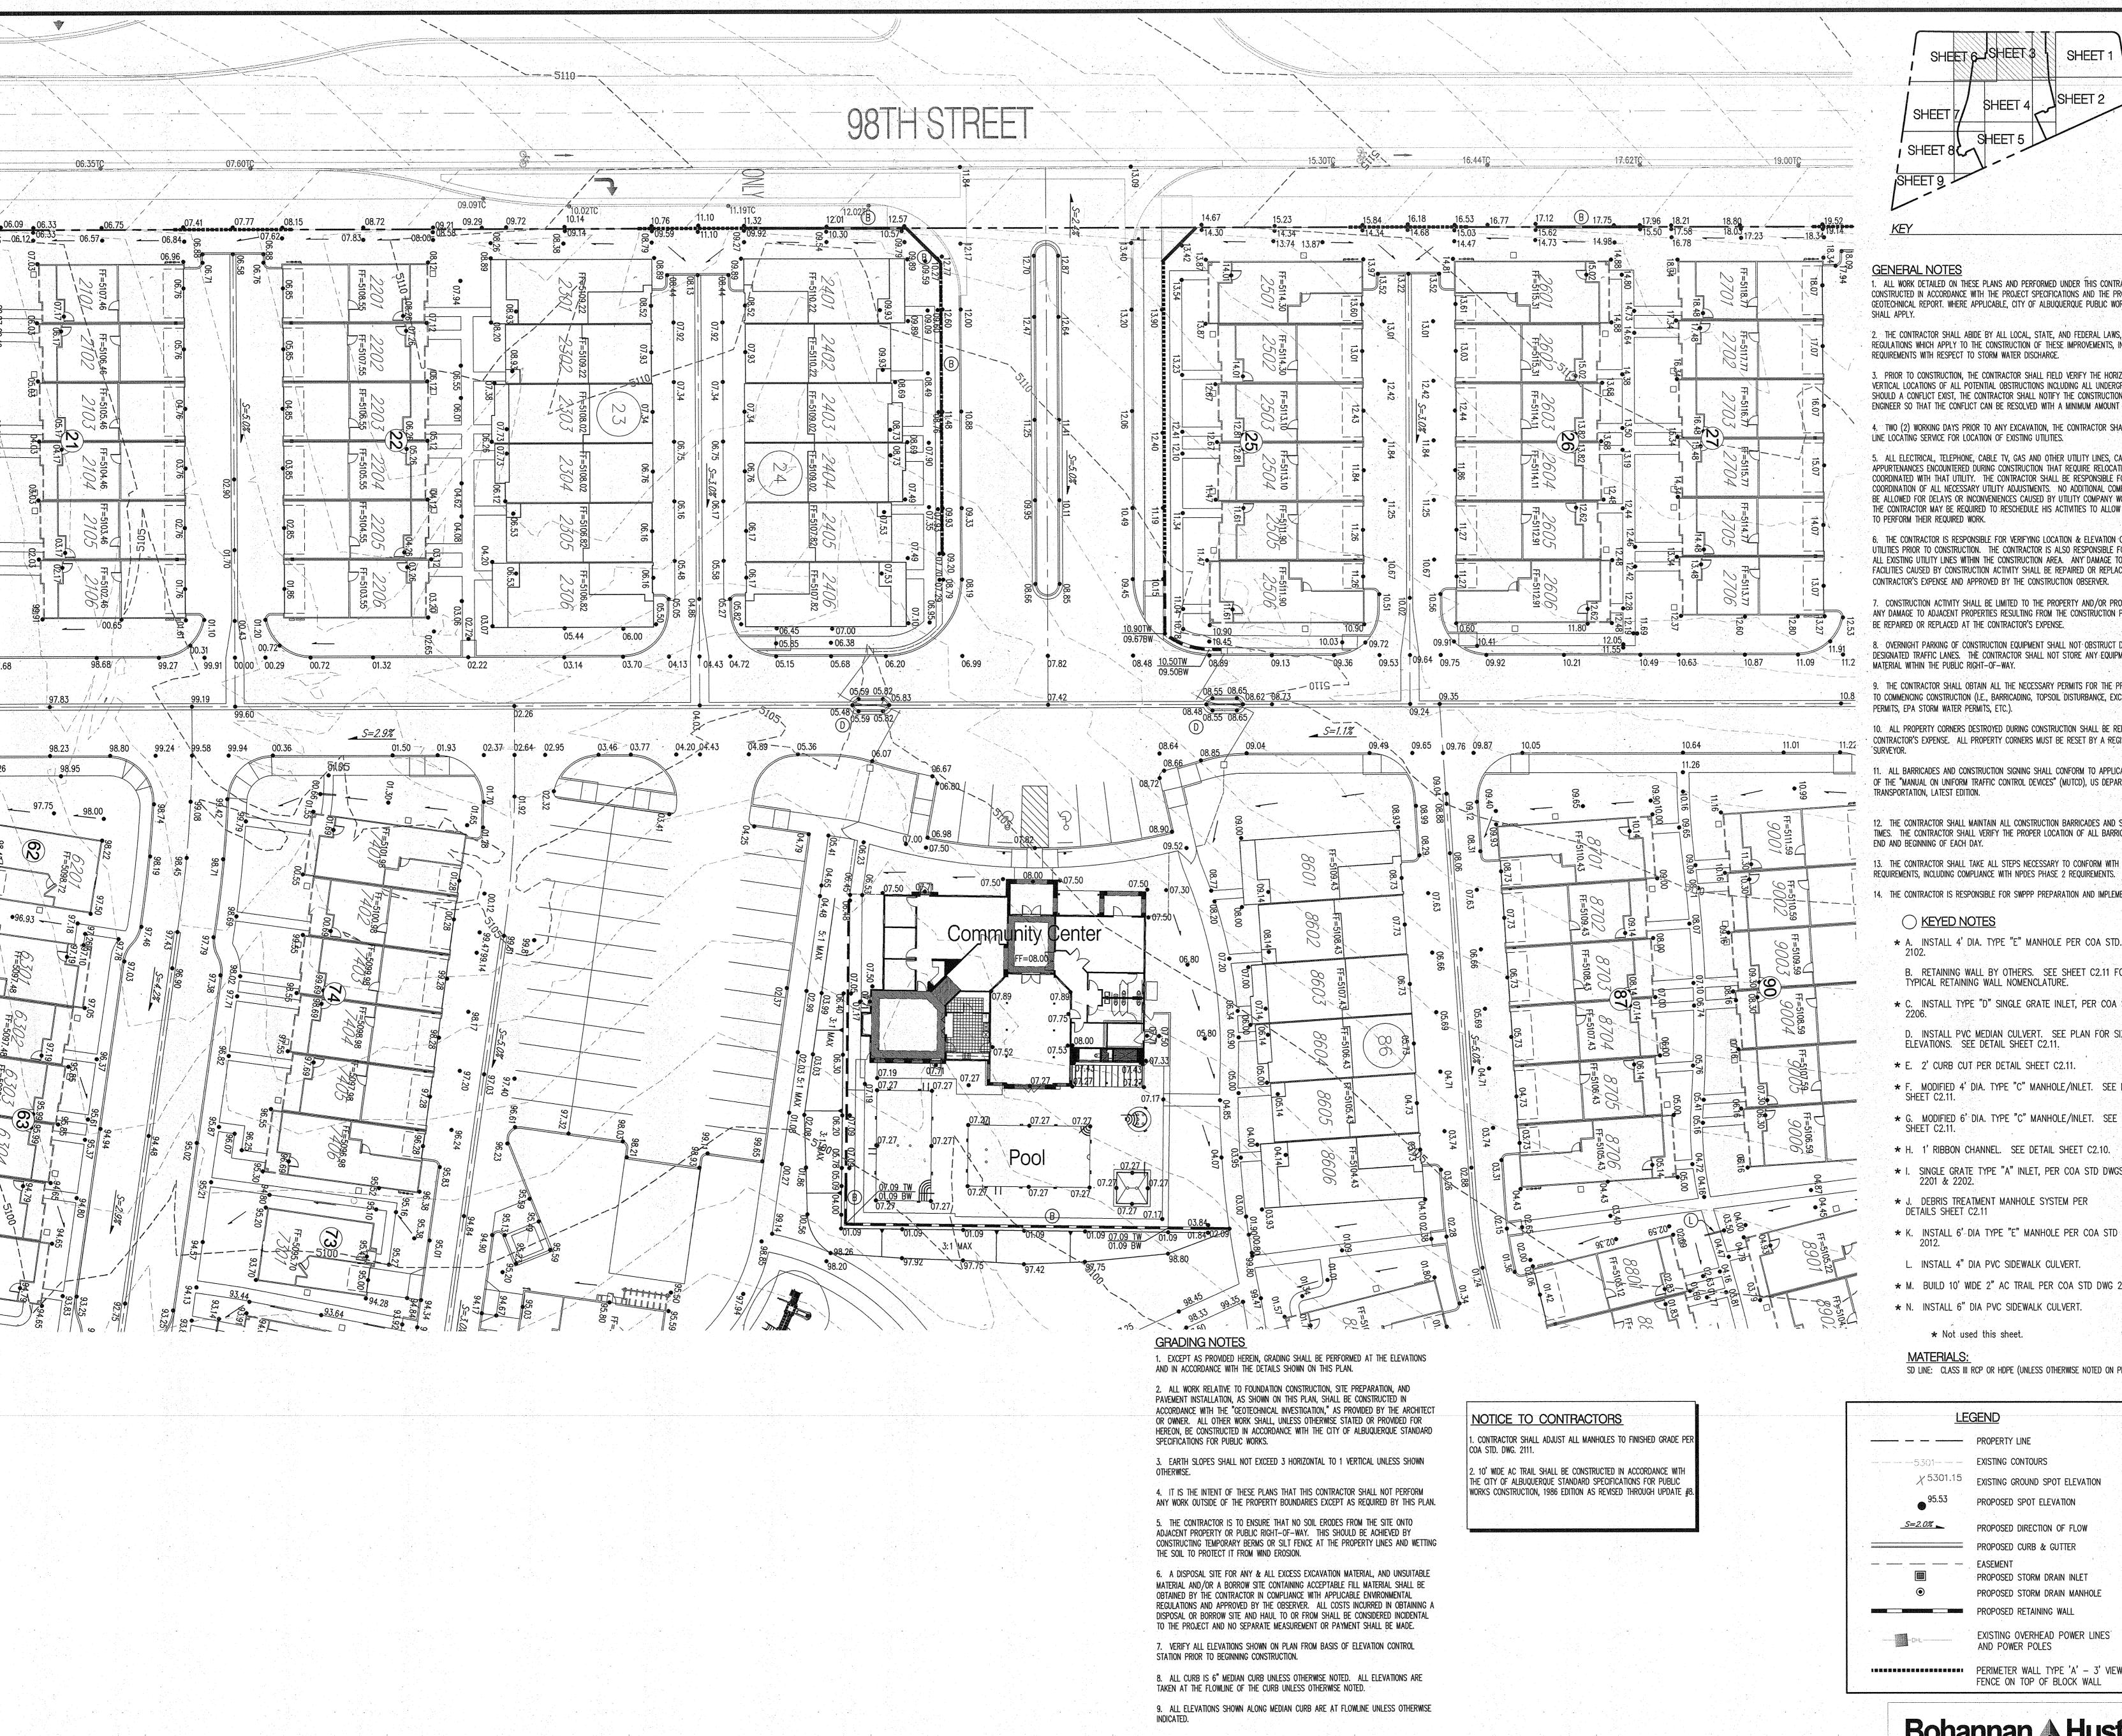

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Tue, 19-Jun-2012 - 2:17:pm

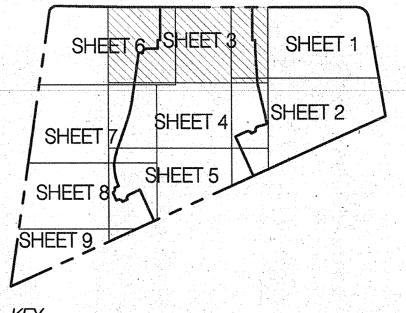

1. ALL WORK DETAILED ON THESE PLANS AND PERFORMED UNDER THIS CONTRACT SHALL CONSTRUCTED IN ACCORDANCE WITH THE PROJECT SPECIFICATIONS AND THE PROJECT

REGULATIONS WHICH APPLY TO THE CONSTRUCTION OF THESE IMPROVEMENTS, INCLUDING EPA REQUIREMENTS WITH RESPECT TO STORM WATER DISCHARGE.

VERTICAL LOCATIONS OF ALL POTENTIAL OBSTRUCTIONS INCLUDING ALL UNDERGROUND UTILITIE SHOULD A CONFLICT EXIST, THE CONTRACTOR SHALL NOTIFY THE CONSTRUCTION OBSERVER OF ENGINEER SO THAT THE CONFLICT CAN BE RESOLVED WITH A MINIMUM AMOUNT OF DELAY.

4. TWO (2) WORKING DAYS PRIOR TO ANY EXCAVATION, THE CONTRACTOR SHALL CONTACT LINE LOCATING SERVICE FOR LOCATION OF EXISTING UTILITIES.

THE CONTRACTOR MAY BE REQUIRED TO RESCHEDULE HIS ACTIVITIES TO ALLOW UTILITY CREW

FACILITIES CAUSED BY CONSTRUCTION ACTIVITY SHALL BE REPAIRED OR REPLACED AT THE CONTRACTOR'S EXPENSE AND APPROVED BY THE CONSTRUCTION OBSERVER

BE REPAIRED OR REPLACED AT THE CONTRACTOR'S EXPENSE.

DESIGNATED TRAFFIC LANES. THE CONTRACTOR SHALL NOT STORE ANY EQUIPMENT OR MATERIAL WITHIN THE PUBLIC RIGHT-OF-WAY.

9. THE CONTRACTOR SHALL OBTAIN ALL THE NECESSARY PERMITS FOR THE PROJECT PRIOR TO COMMENCING CONSTRUCTION (I.E., BARRICADING, TOPSOIL DISTURBANCE, EXCAVATION PERMITS, EPA STORM WATER PERMITS, ETC.).

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THE CONTRACTOR SHALL MAINTAIN ALL CONSTRUCTION BARRICADES AND SIGNING AT ALL TIMES. THE CONTRACTOR SHALL VERIFY THE PROPER LOCATION OF ALL BARRICADING AT THE

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\* A. INSTALL 4' DIA. TYPE "E" MANHOLE PER COA STD. DWG.

B. RETAINING WALL BY OTHERS. SEE SHEET C2.11 FOR TYPICAL RETAINING WALL NOMENCLATURE.

\* C. INSTALL TYPE "D" SINGLE GRATE INLET, PER COA STD DWG

D. INSTALL PVC MEDIAN CULVERT. SEE PLAN FOR SIZE AND

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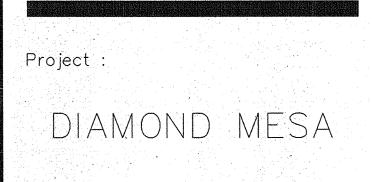
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SD LINE: CLASS III RCP OR HDPE (UNLESS OTHERWISE NOTED ON PLANS)


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X 5301.15	EXISTING GROUND SPOT ELEVATION	ON
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<ul><li>●</li></ul>	EASEMENT PROPOSED STORM DRAIN INLET PROPOSED STORM DRAIN MANHO PROPOSED RETAINING WALL	LE
	EXISTING OVERHEAD POWER L AND POWER POLES	INES
	PERIMETER WALL TYPE 'A' — FENCE ON TOP OF BLOCK WA	1

Bohannan A Huston




No. Date Issue / Description

ALBUQUERQUE, N.M.

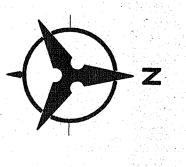

ACS BRASS TABLET STAMPED "TRANS" Geographic Position (NAD 1927) N.M. State Plane Coordinates (Central Zone) X= 354,899.45 Y= 1,471,822.67 Ground-to-Grid Factor = 0.99967921 $\Delta \alpha = -00.16'42''$ SLD 1929 Elevation = 5118.43

License Stamp:

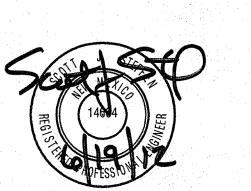

Project Contact: Phone #: Fax #:

E-Mail:


Principal in Charge Project Director Project Designer: Project Manager:

Sheet Title:

**GRADING & DRAINAGE** PLAN

Sheet No.

C2.03

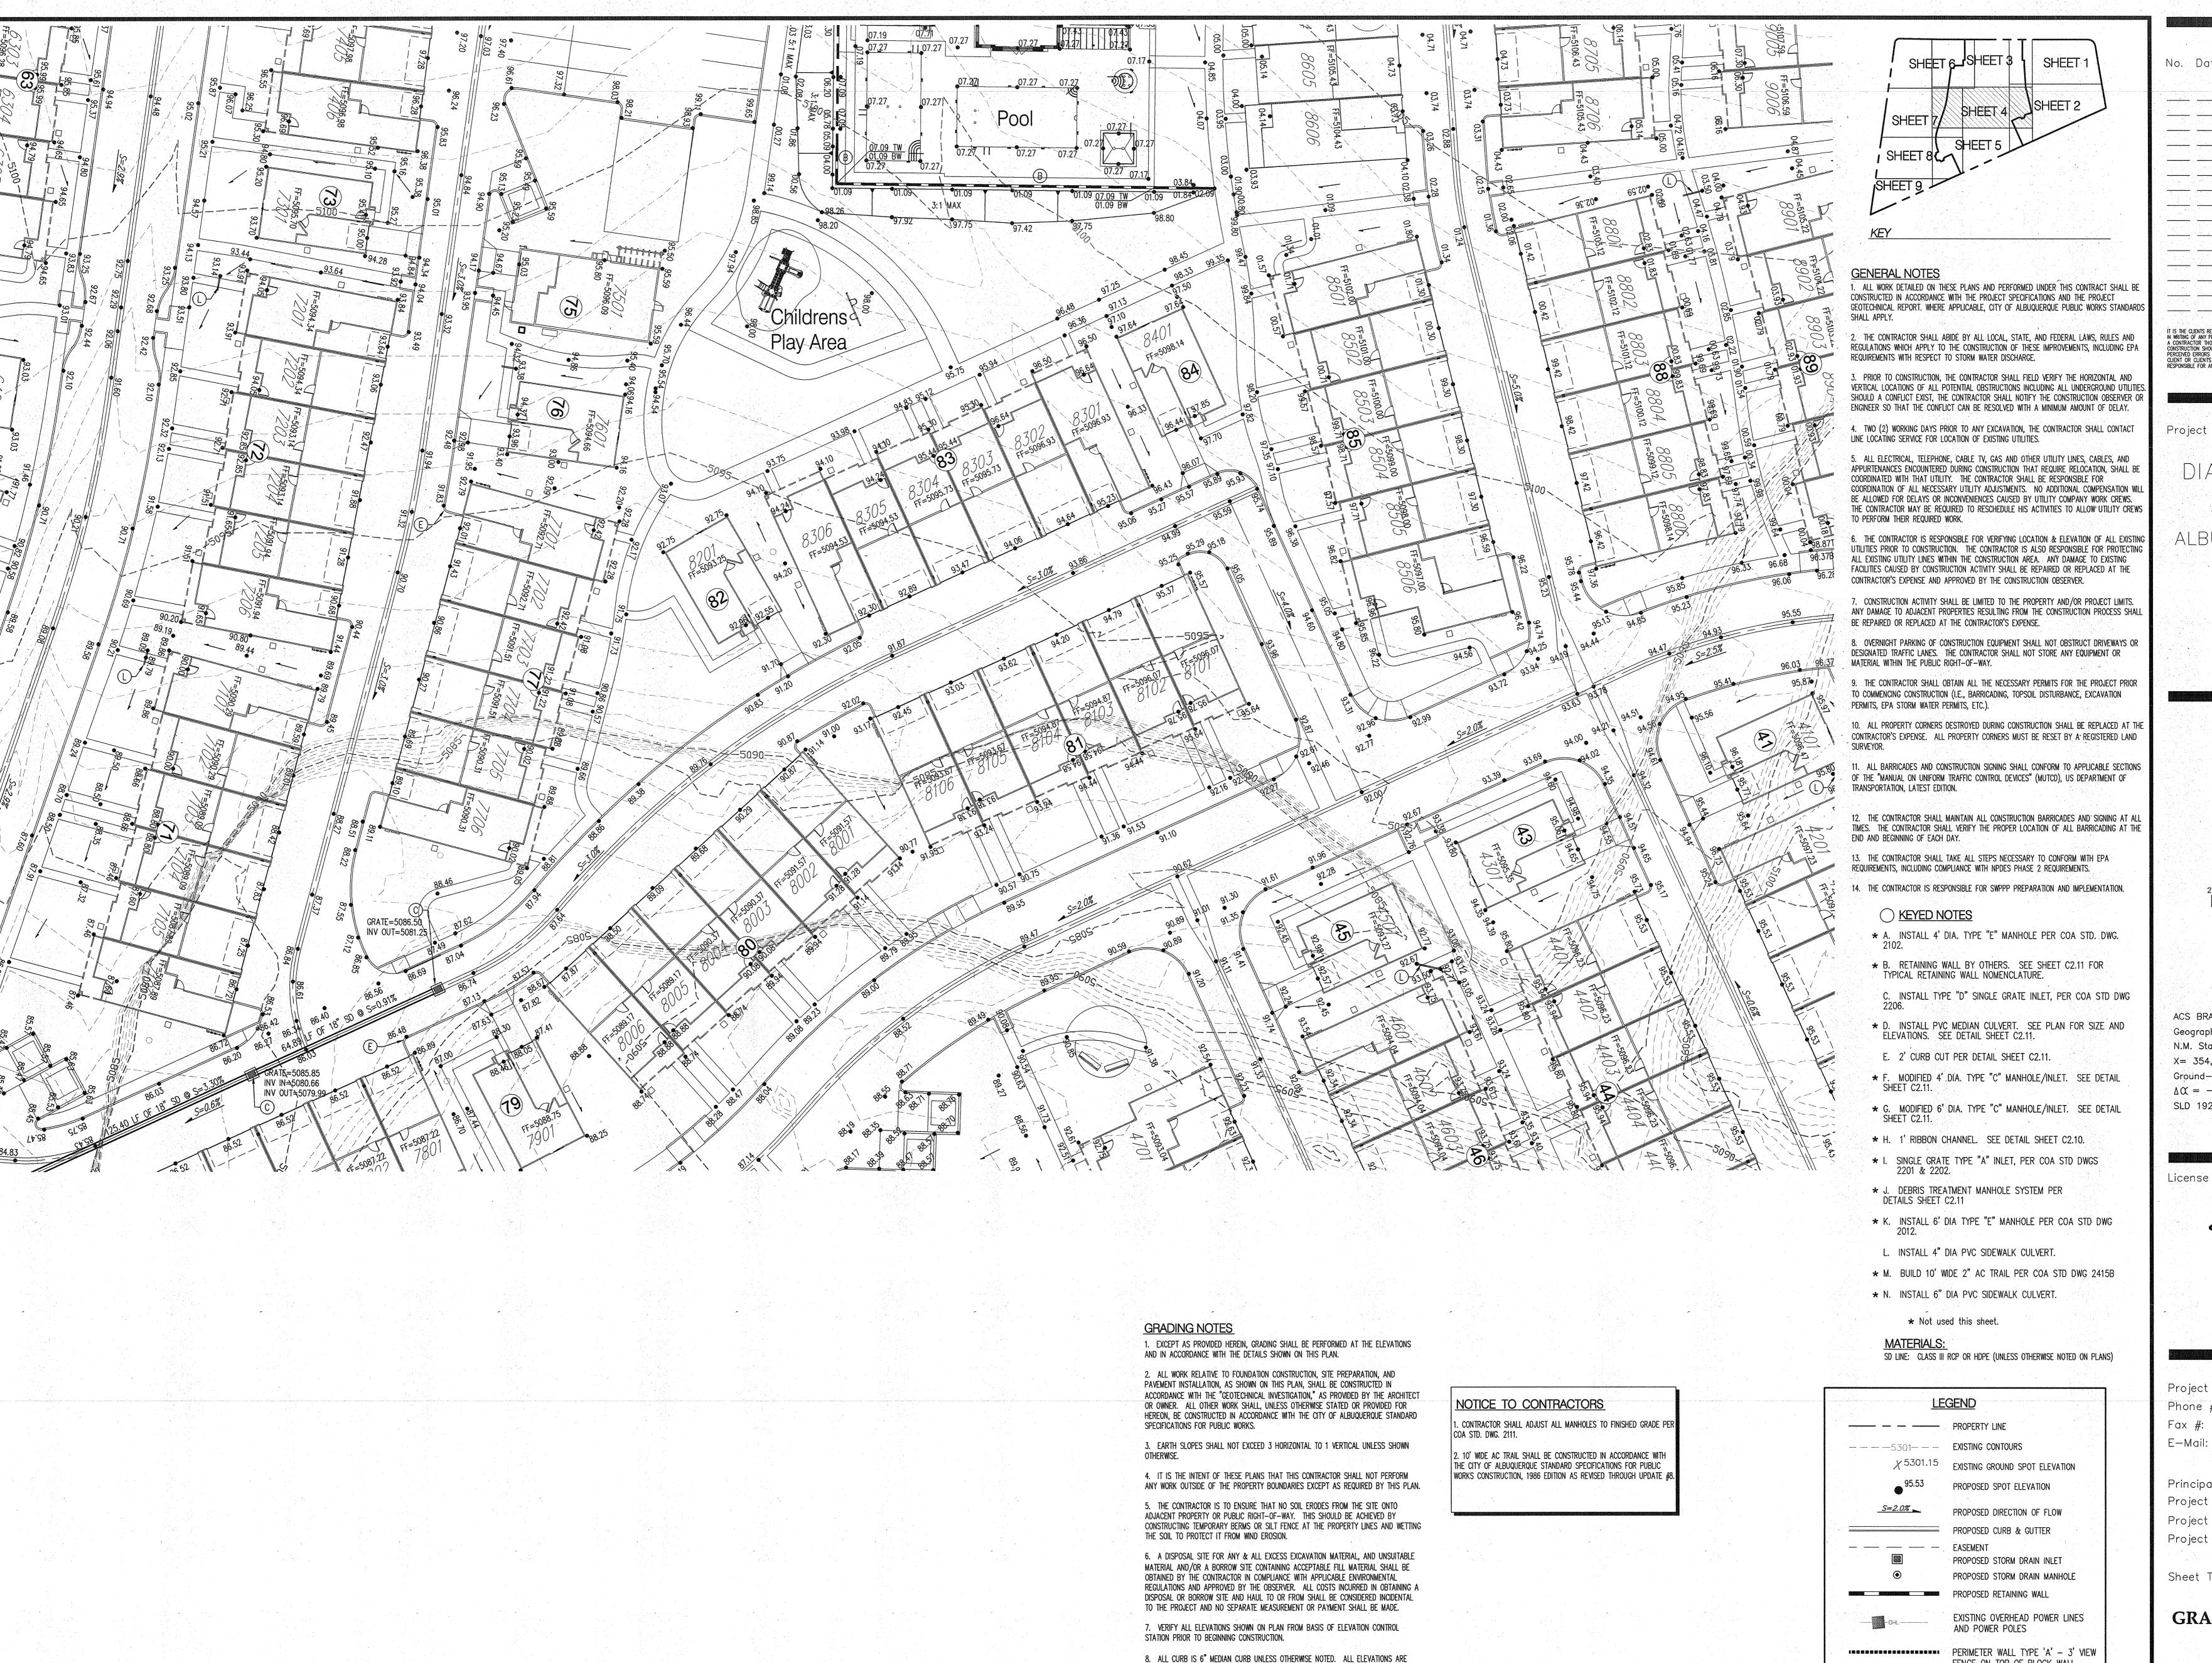

TAKEN AT THE FLOWLINE OF THE CURB UNLESS OTHERWISE NOTED.

INDICATED.

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Tue, 19-Jun-2012 - 2:18:pm

9. ALL ELEVATIONS SHOWN ALONG MEDIAN CURB ARE AT FLOWLINE UNLESS OTHERWISE

No. Date | Issue / Description

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DIAMOND MESA

ALBUQUERQUE, N.M.

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License Stamp:



Project Contact: Phone #: Fax #:

Principal in Charge: Project Director: Project Designer: Project Manager:

Sheet Title :

**GRADING & DRAINAGE** PLAN

Sheet No. :

FENCE ON TOP OF BLOCK WALL

Bohannan A Huston

C2.04