CITY OF ALBUQUERQUE

Planning Department David Campbell, Director



Mayor Timothy M. Keller

March 26, 2019

David Soule, P.E. Rio Grande Engineering P.O. Box 93924 Albuquerque, NM, 87199

RE: 1701 Soplo Rd SE Grading and Drainage Plan Engineer's Stamp Date: 03/14/19 Hydrology File: N23D001

Dear Mr. Soule:

PO Box 1293 Based upon the information provided in your submittal received 03/15/19, the Grading and Drainage Plan is approved for Building Permit.

Albuquerque Once the grading is complete, a pad certification will be required prior to release of Building Permit. Please attach a copy of this approved plan in the construction sets for Building Permit processing along with a copy of this letter and the pad certification approval letter.

NM 87103 Prior to approval in support of Permanent Release of Occupancy by Hydrology, Engineer Certification per the DPM checklist will be required and a formal Elevation Certificate needs to be submitted to Hydrology.

^{www.cabq.gov} If you have any questions, please contact me at 924-3995 or <u>rbrissette@cabq.gov</u>.

Sincerely,

Renée C. Brissette

Renée C. Brissette, P.E. CFM Senior Engineer, Hydrology Planning Department

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City of Albuquerque

Planning Department Development & Building Services Division

DRAINAGE AND TRANSPORTATION INFORMATION SHEET (REV 6/2018)

Project Title: 1701 SOPLO	Building Permit	; # :	Hydro	logy File #:
DRB#:	EPC#:		Work	Order#:
Legal Description: _lot 13 block	49A FOUR HI	LLS - 19TH	EDITION	
City Address: 1701 SOPLO				
			Contact:	
Address:				
Phone#:	_ Fax#:		E-mail:	
Other Contact: RIO GRANDE ENGIN	EERING		Contact:	DAVID SOULE
Address: PO BOX 93924 ALB NM	87199			
Phone#: 505.321.9099		.0999	E-mail: ^C	lavid@riograndeengineering.com
TYPE OF DEVELOPMENT: PLAT				
Check all that Apply:				
DEPARTMENT: X HYDROLOGY/ DRAINAGE TRAFFIC/ TRANSPORTATION TYPE OF SUBMITTAL: ENGINEER/ARCHITECT CERTIFICATIO PAD CERTIFICATION CONCEPTUAL G & D PLAN X GRADING PLAN DBADIAGE DEPORT	'n	BUILDING I CERTIFICA PRELIMINA SITE PLAN	PERMIT APPI TE OF OCCU RY PLAT AF FOR SUB'D FOR BLDG. 1	PANCY PPROVAL APPROVAL PERMIT APPROVAL
DRAINAGE REPORT DRAINAGE MASTER PLAN FLOODPLAIN DEVELOPMENT PERMIT ELEVATION CERTIFICATE CLOMR/LOMR TRAFFIC CIRCULATION LAYOUT (TCI TRAFFIC IMPACT STUDY (TIS) STREET LIGHT LAYOUT OTHER (SPECIFY) PRE-DESIGN MEETING? IS THIS A RESUBMITTAL?: YesX_N	.)	FOUNDATIO GRADING I SO-19 APPR PAVING PE GRADING/ I WORK ORDI	ON PERMIT A PERMIT APPR ROVAL RMIT APPRO PAD CERTIF ER APPROVA MR IN DEVELOP	ROVAL DVAL ICATION L MENT PERMIT
DATE SUBMITTED:	By:	-		
COA STAFF:	ELECTRONIC SUE	MITTAL RECEIVED:_		_

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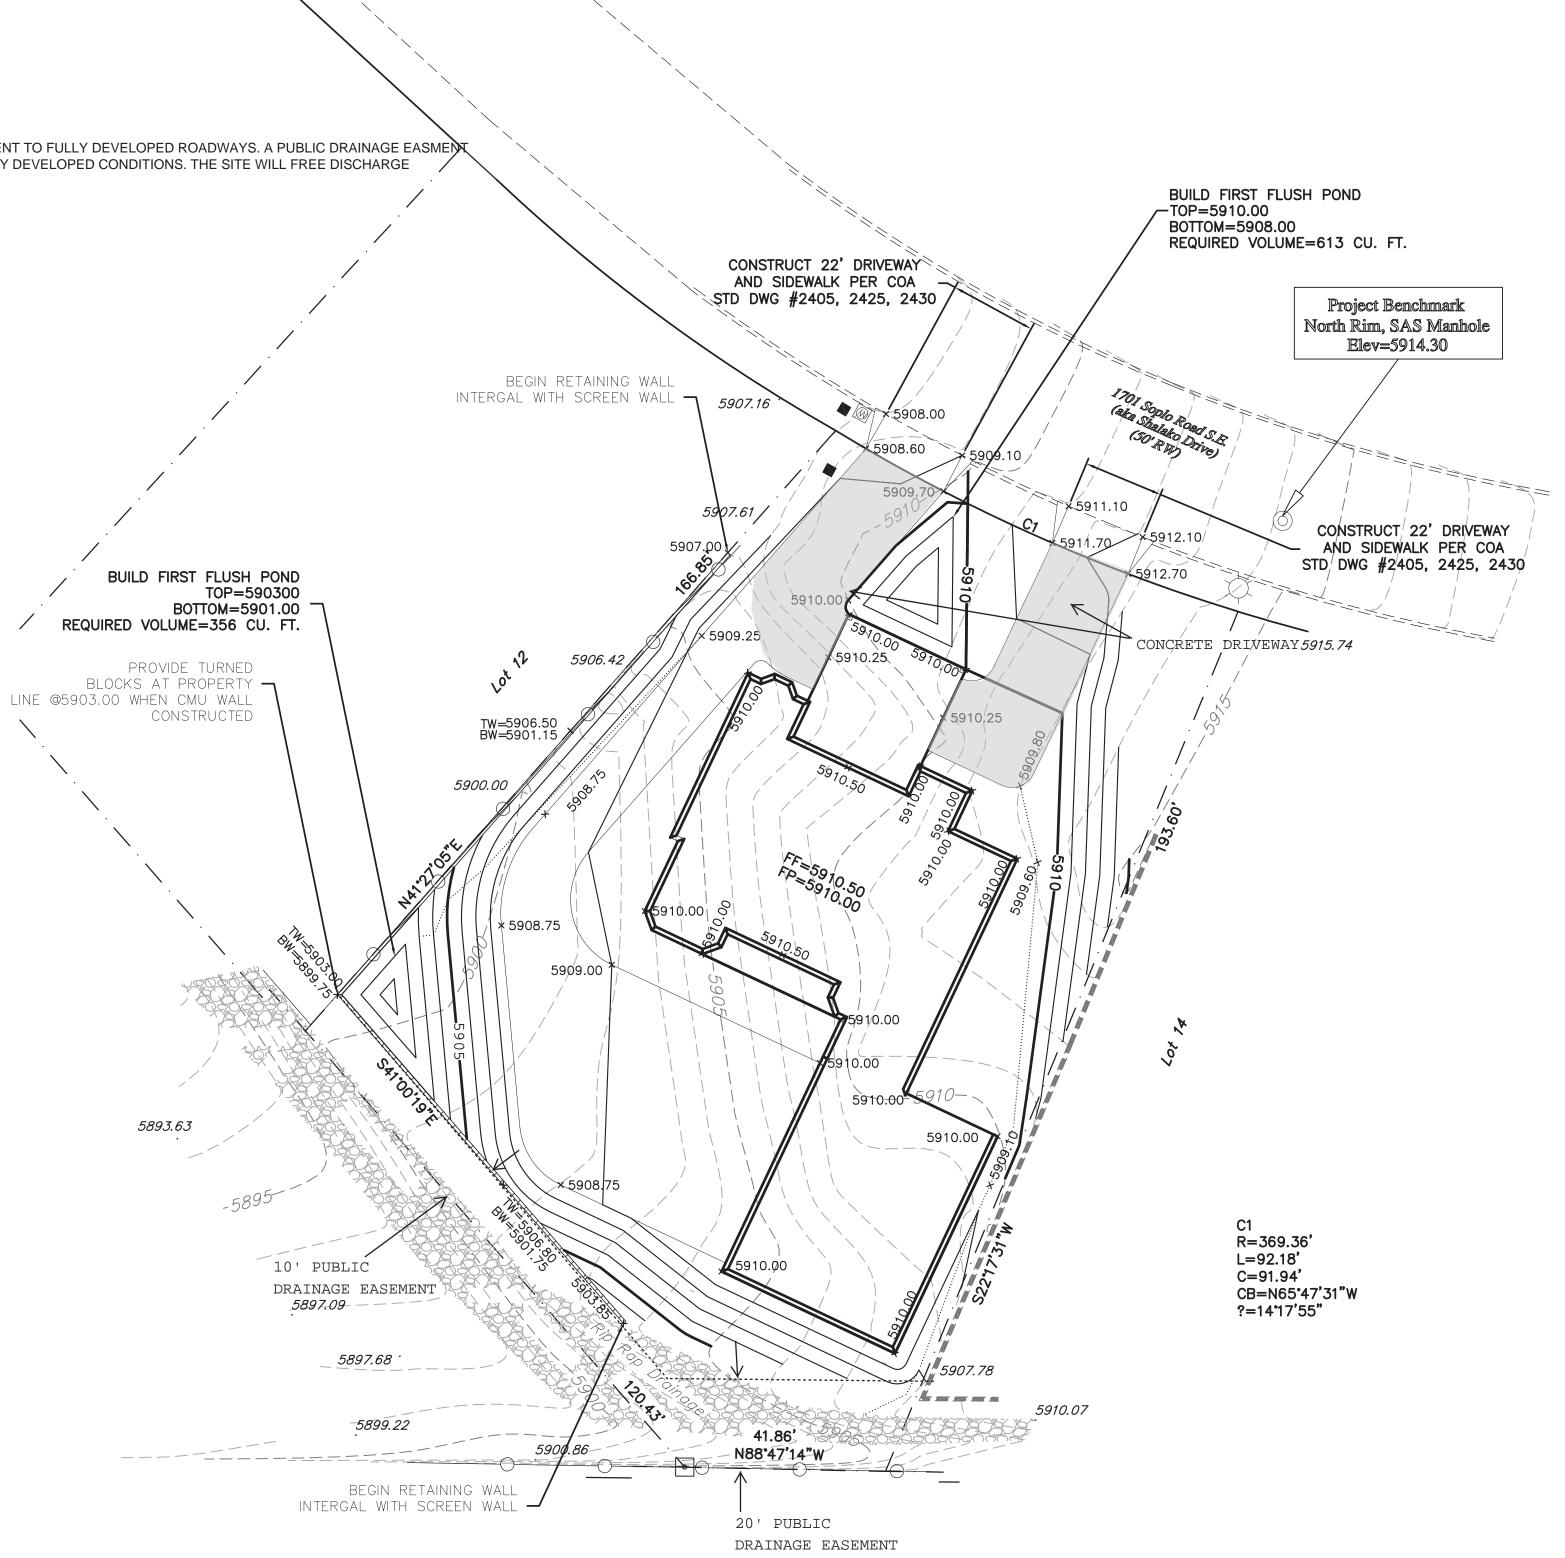
Weighted E Method

Existing Developed Basins

											100-Year, 6-ł	hr.		10-day
Basin	Area	Area	Treatment	A	Treatme	nt B	Treatm	ent C	Treatme	nt D	Weighted E	Volume	Flow	Volume
	(sf)	(acres)	%	(acres)	%	(acres)	%	(acres)	%	(acres)	(ac-ft)	(ac-ft)	cfs	(ac-ft)
EXISTING	23820	0.547	50%	0.27342	40.0%	0.219	0.0%	0	5%	0.027	0.964	0.044	1.38	0.048
PROPOSED	23820	0.547	0%	0	34.0%	0.186	27.0%	0.14764	39%	0.213	1.791	0.082	2,21	0.110
Equations:										Ň			~	
Weighted E = Ea*Aa + Eb*Ab +	Ec*Ac + Ed*	Ad / (Total A	rea)											
Volume = Weighted D * Total A	rea													
Flow = Qa * Aa + Qb * Ab + Qc	* Ac + Qd * A	d												
Where for 100-year, 6-hour stor	m (zone 4)													
•	Éa=	: 0.8		Qa=	2.2							l l l l l l l l l l l l l l l l l l l	\mathbf{X}	
	Eb=	: 1.08		Qb=	2.92									
		: 1.46			3.73								Ì\	
	Ed=	: 2.64		Qd=	5.25									
FIRST FLUSH VOLUME													\backslash	
REQUIRED				263.21	CF									\sim
PROVIDED				356										\mathbf{N}

DRAINAGE NARRATIVE

THIS SITE IS A LOT WITHIN A FULLY DEVELOPED RESIDENTIAL SUBDIVISION. THE SITE IS ADJACENT TO FULLY DEVELOPED ROADWAYS. A PUBLIC DRAINAGE EASMENT ABUTS THIS SITE. THE DENSITY OF THIS DEVELOPMENT IS SIMILAR TO THE SURROUNDING FULLY DEVELOPED CONDITIONS. THE SITE WILL FREE DISCHARGE AFTER THE FIRST FLUSH VOLUMES ARE RETAINED ON SITE



CAUTION:

EXISTING UTILITIES ARE NOT SHOWN. IT SHALL BE THE SOLE RESPONSIBILITY OF THE CONTRACTOR TO CONDUCT ALL NECESSARY FIELD INVESTIGATIONS PRIOR TO ANY EXCAVATION TO DETERMINE THE ACTUAL LOCATION OF UTILITIES & OTHER IMPROVEMENTS.

EROSION CONTROL NOTES:


1. CONTRACTOR IS RESPONSIBLE FOR OBTAINING A TOPSOIL DISTURBANCE PERMIT PRIOR TO BEGINNING WORK.

2. CONTRACTOR IS RESPONSIBLE FOR MAINTAINING RUN-OFF ON SITE DURING CONSTRUCTION.

3. CONTRACTOR IS RESPONSIBLE FOR CLEANING ALL SEDIMENT THAT GETS INTO EXISTING RIGHT-OF-WAY.

4. REPAIR OF DAMAGED FACILITIES AND CLEANUP OF SEDIMENT ACCUMULATIONS ON ADJACENT PROPERTIES AND IN PUBLIC FACILITIES IS THE RESPONSIBILITY OF THE CONTRACTOR.

5. ALL EXPOSED EARTH SURFACES MUST BE PROTECTED FROM WIND AND WATER EROSION PRIOR TO FINAL ACCEPTANCE OF ANY PROJECT.

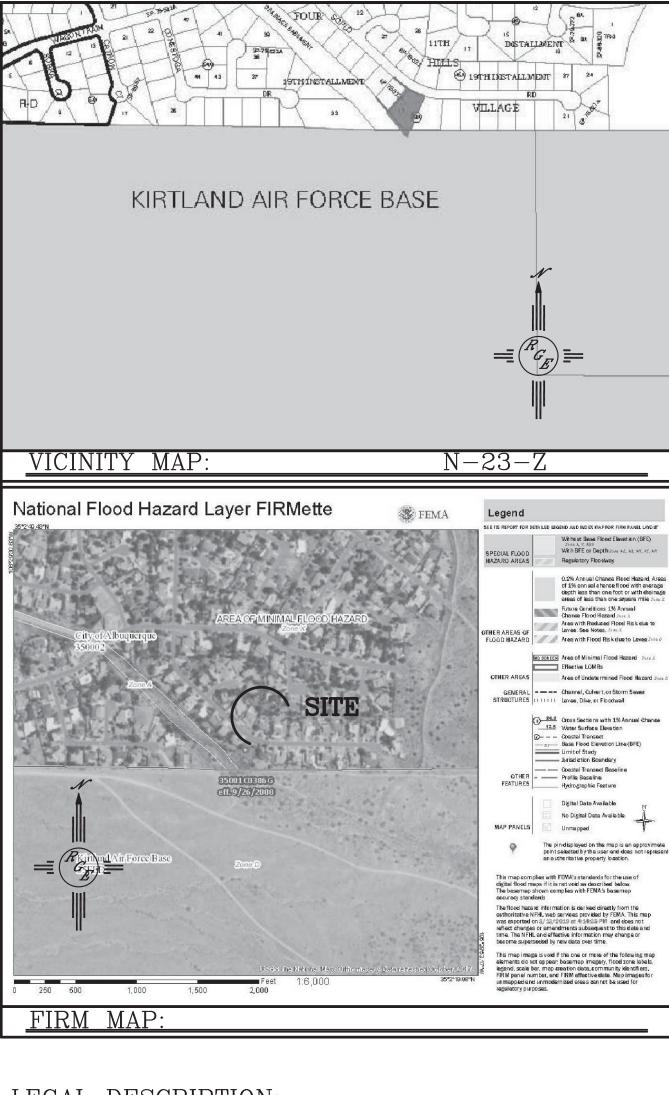

LEGAL DESCRIPTION: Lot 13, Block 49A, Four Hills Subdivision

NOTES:

1. ALL SPOT ELEVATIONS REPRESENT FLOWLINE ELEVATION UNLESS OTHERWISE NOTED.

2. ALL SLOPES SHALL BE 3:1 MAX. AND GRAVEL OR NATIVE SEEDING PRIOR TO CO.

LEGEND

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DAVID SOULE P.E. #14522

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SCALE: 1"=20'

XXX	- EXISTING CONTOUR	
	- EXISTING INDEX CONTOUR	
XXXX	PROPOSED CONTOUR	
	- PROPOSED INDEX CONTOUR	
▶_	SLOPE TIE	
× XXXX	EXISTING SPOT ELEVATION	
× XXXX	PROPOSED SPOT ELEVATION	
	BOUNDARY	
	CENTERLINE	
==========	$\Xi \equiv$ EXISTING CURB AND GUTTER	
	🚥 PROPOSED CMU SCREEN WALL (12" MAX.	
	The osed one sereer when (12 max.	
ENGINEER'S	1701 Sonlo Road S.E.	DRAWN
ENGINEER'S SEAL	1701 Soplo Road S.E.	DRAWN BY WCWJ
	1701 Soplo Road S.E.	BY _{WCWJ} DATE
SEAL		BY WCWJ
SEAL	1701 Soplo Road S.E. GRADING AND DRAINAGE PLAN	BY _{WCWJ} DATE 3-14-19
SEAL	GRADING AND DRAINAGE PLAN	BY _{WCWJ} DATE 3-14-19 219019-LAYOUT-3-14-1
SEAL	GRADING AND	BY _{WCWJ} DATE 3-14-19
SEAL	GRADING AND DRAINAGE PLAN	BY _{WCWJ} DATE 3-14-19 219019-LAYOUT-3-14-1

SUITE 201

ALBUQUERQUE, NM 87106 (505) 872–0999

JOB #

219019