
CITY OF ALBUQUERQUE

Planning Department
Alan Varela, Interim Director

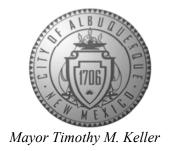

December 21, 2020

David Thompson Thompson Engineering Consultants, Inc. P.O. Box 65760 Albuquerque, NM 87190

RE: Hawking Drive SE ROW

Grading and Drainage Plan Stamp Date: 4/28/21

Drainage File: Q16DA006A

Dear Mr. Thompson:

Based on the submittal received on 5/4/21, the Grading and Drainage Plan is approved for Grading Permit and Work Order.

PO Box 1293

Please note, at DRC a note must be added to the pond grading sheet stating that pond slopes are to be stabilized with "Native Grass Seed with Aggregate Mulch or equal (Must satisfy the "Final Stabilization criteria" CGP 2.2.14.b.).

Albuquerque

If you have any questions, please contact me at 924-3986 or earmijo@cabq.gov.

NM 87103

Sincerely,

www.cabq.gov

Ernest Armijo, P.E.

Principal Engineer, Planning Dept. Development Review Services



City of Albuquerque


Planning Department Development & Building Services Division

DRAINAGE AND TRANSPORTATION INFORMATION SHEET (REV 11/2018)

Project Title:	Building P	Permit #:	Hydrology File #:		
DRB#:	RB#:EPC#:		Work Order#:		
Legal Description:					
City Address:					
Applicant:			Contact:		
Address:					
			E-mail:		
Owner:			Contact:		
Address:					
			E-mail:		
TYPE OF SUBMITTAL:PLA	Γ (# OF LOTS)	RESIDENCE	_ DRB SITE ADMIN SITE		
IS THIS A RESUBMITTAL?:	Yes	No			
DEPARTMENT: TRAFFIC/ T	RANSPORTATION _	HYDROLOG	Y/ DRAINAGE		
Check all that Apply: TYPE OF SUBMITTAL: ENGINEER/ARCHITECT CERTON CONCEPTUAL G & D PLAN GRADING PLAN DRAINAGE MASTER PLAN DRAINAGE REPORT FLOODPLAIN DEVELOPMENTON ELEVATION CERTIFICATE CLOMR/LOMR TRAFFIC CIRCULATION LAY TRAFFIC IMPACT STUDY (TIEST) OTHER (SPECIFY) PRE-DESIGN MEETING?	PERMIT APPLIC OUT (TCL)	TYPE OF APPROVAL/ACCEPTANCE SOUGHT: BUILDING PERMIT APPROVAL CERTIFICATE OF OCCUPANCY PRELIMINARY PLAT APPROVAL SITE PLAN FOR SUB'D APPROVAL SITE PLAN FOR BLDG. PERMIT APPROVAL FINAL PLAT APPROVAL SIA/ RELEASE OF FINANCIAL GUARANTEE FOUNDATION PERMIT APPROVAL GRADING PERMIT APPROVAL SO-19 APPROVAL PAVING PERMIT APPROVAL GRADING/ PAD CERTIFICATION WORK ORDER APPROVAL CLOMR/LOMR FLOODPLAIN DEVELOPMENT PERMIT OTHER (SPECIFY)			
DATE SUBMITTED:	By:				

COA STAFF: ELECTRONIC SUBMITTAL RECEIVED:____

FEE PAID:

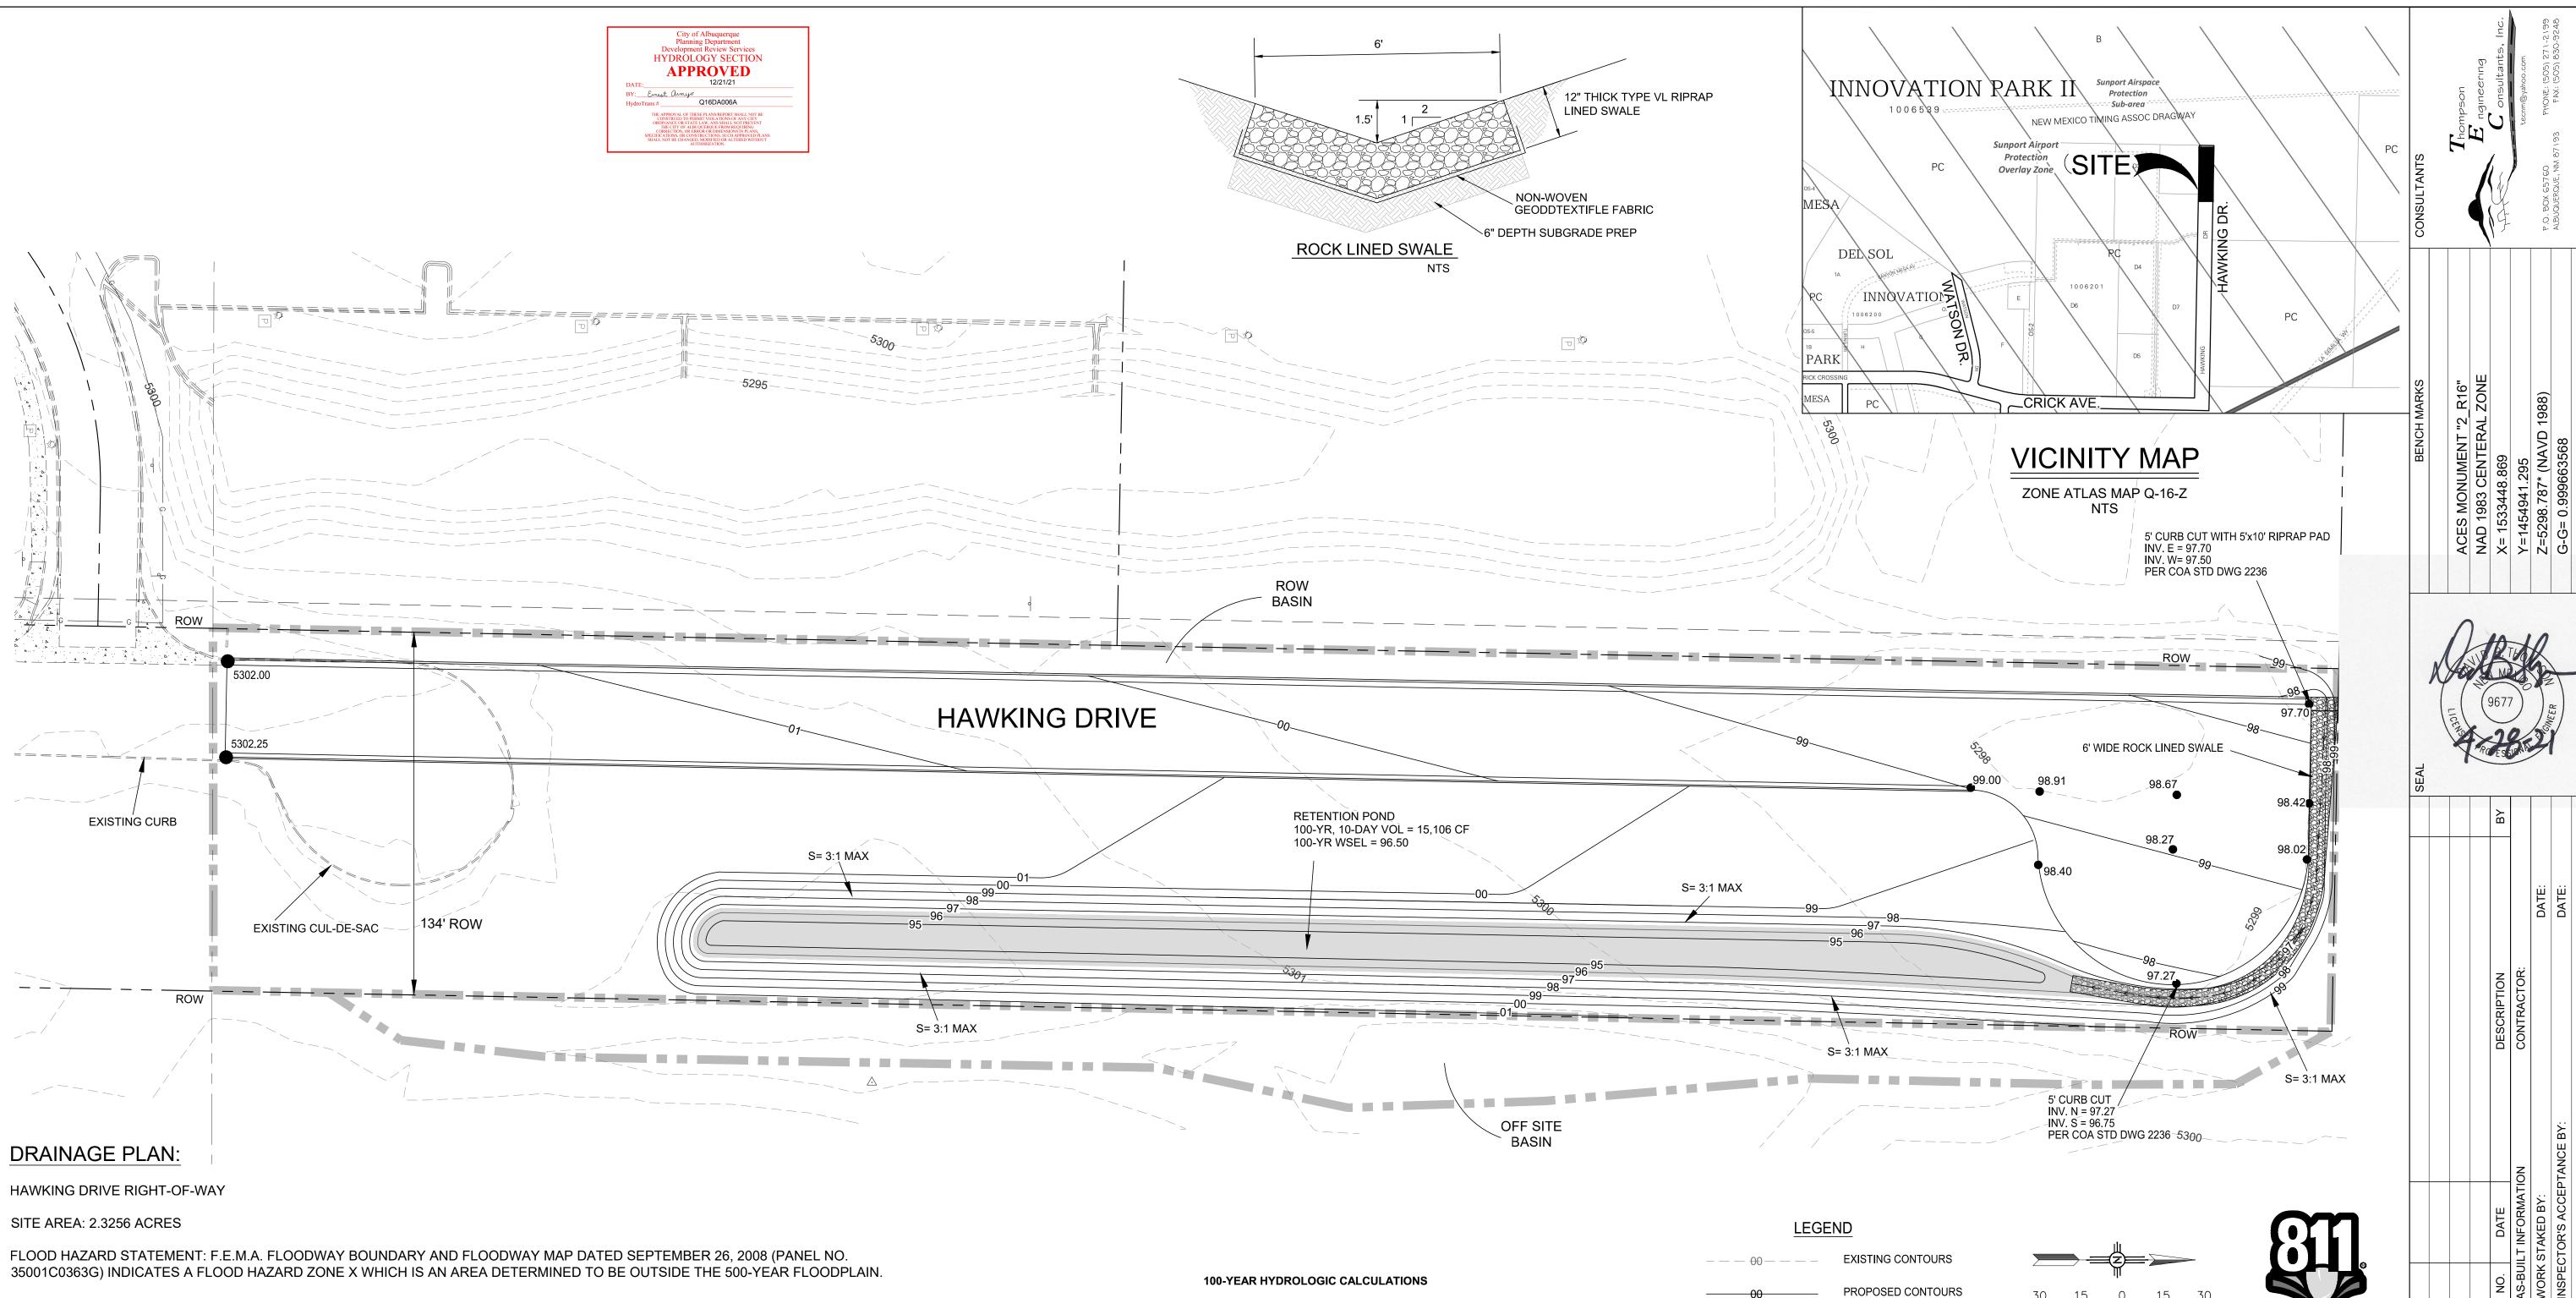

EXISTING DRAINAGE CONDITIONS:

THE DRAINAGE ANALYSIS FOR THIS SITE IS IN ACCORDANCE WITH CHAPTER 6 OF THE CITY OF ALBUQUERQUE DPM; EFFECTIVE JUNE 8, 2020, ENTITLED "DRAINAGE, FLOOD CONTROL, AND EROSION CONTROL". HAWKING DRIVE IS LOCATED IN ZONE 2. THE DESIGN STORM TO DETERMINE THE PEAK FLOWS FOR THE SITE IS THE 100-YEAR, 6-HOUR STORM, WHICH IS 2.29 INCHES IN ZONE 2. WHEREAS, THE DESIGN STORM TO DETERMINE THE RUNOFF VOLUME FOR THE SITE IS THE 100-YEAR, 10-DAY STORM, WHICH IS 3.62 INCHES IN ZONE 2.

EXISTING CONDITIONS INCLUDE A TEMPORARY CUL-DE-SAC BULB AND AN UNDEVELOPED AREA. THERE IS A SMALL OFFSITE BASIN THAT DRAINS TO THE HAWKING DRIVE RIGHT-OF-WAY FROM THE SOUTH.

DEVELOPED DRAINAGE CONDITIONS:

THIS PROJECT INVOLVES THE CONSTRUCTION OF THE NORTHERN HALF STREET SECTION OF HAWKING DRIVE. THE STREET SECTION DRAINS TO THE NORTH FROM THE EXISTING STREET SECTION. THE RUNOFF FROM THE STRETT SECTION AND THE UNDEVELOPED PORTION OF THE RIGHT-OF-WAY WILL DRAIN TO A RETENTION POND WITHIN THE HAWKING DRIVE RIGHT-OF-WAY ALONG THE SOUTH RIGHT-OF-WAY LINE. THE STREET WILL DRAIN TO THE NORTHWEST TO A FIVE-FOOT WIDE CURB OPENING TO A ROCK-LINED SWALE. AT THE NORTH END OF THE STREET IS A TEMPORARY CUL-DE-SAC THAT DRAINS FROM WEST TO EAST TO ANORTHER CURB OPENING THAT WILL DRAIN THE ROCK-LINED SWALE. THE ROCK-LINED SWALE WILL CONVEY THE RUNOFF FROM THE STREET AND CUL-DE-SAC TO A RETENTION POND LOCATED ALONG THE SOUTH RIGHT-OF-WAY LINE JUST SOUTH OF THE CUL-DE-SAC. THE RETENTION POND HAS A 100-YEAR, 10-DAY VOLUME OF 15,106 CUBIC-FEET. THE DEPTH OF THE POND WILL BE A MAXAMUM OF 1.5 FEET. THE TOP OF THE POND WATER SURFACE WILL BE TEN FEET FROM THE PROPOSED PUBLIC SANITARY SEWER LINE. THE FIRST FLUSH FROM THE INPERVIOUS AREA OF THE STREET WILL BE RETAINED IN THE RETENTION POND.

		L	AND TR	EATMEN	IT	WEIGHTED	D 100-YEAR PRECIPITATION				
BASIN	AREA	Α	В	С	D] E	V (6-hr)	V (6-hr)	V(10-day)	V(10-day)	
#	(acre)	(%)	(%)	(%)	(%)	(in)	(acre-ft)	(cu-ft)	(acre-ft)	(cu-ft)	(с
				E	XISTING	CONDITIONS	S				
ROW	2.3256	94.50	0.00	0.00	5.50	0.71	0.14	6,028	0.15	6,645	4.
Offsite	0.3535	100.00	0.00	0.00	0.00	0.62	0.02	796	0.02	796	0.
TOTAL RUNOFF	2.68						0.16	6,824	0.17	7,441	4.
				FULL DI	EVELOP	MENT COND	ITIONS				
ROW	2.3256	0.00	68.70	0.00	31.30	1.28	0.25	10,796	0.33	14,311	6.
Offsite	0.3535	100.00	0.00	0.00	0.00	0.62	0.02	796	0.02	796	0.
TOTAL RUNOFF	0.35						0.27	11,592	0.35	15,106	7.
EXCESS PRECIP.		0.62	0.8	1.03	2.33	Ei (in)					
PEAK DISCHARGE		1.71	2.36	3.05	4.34	Q _{Pi} (cfs)					
WEIGHTED E (in) =		. , .		%C) + (E	□)(%D)				ZONE = P _{6-HR} (in.) =	2.29	
V _{6-HR} (acre-ft) = (WEIGHTED E)(AREA)/12					P_{24-HR} (in.) = 2.59						

 P_{10DAY} (in.) = 3.62


V_{6-HR} (acre-ft) = (WEIGHTED E)(AREA)/12 V_{10DAY} (acre-ft) = V_{6-HR} + (AD)(P_{10DAY} - P_{6-HR})/12 $Q(cfs) = (Q_{PA})(A_A) + (Q_{PB})(A_B) + (Q_{PC})(A_C) + (Q_{PD})(A_D)$

PROPOSED SPOT ELEVATION PROPOSED CURB AND GUTTER BASIN BOUNDARY

PROPOSED PONDING


GENERAL NOTES:

- 1. CONTRACTOR TO FIELD VERIFY ALL UTILITIES PRIOR TO CONSTRUCTION.
- 2. CONTRACTOR TO USE COA STD DWGS AND ABCWUA STD DWGS UNLESS OTHERWISE NOTED.

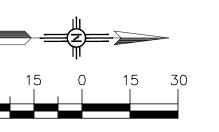

CALL NM ONE-CALL SYSTEM SEVEN (7) DAYS PRIOR TO ANY EXCAVATION

DESIGNED BY: DBT DRAWN BY: DEM CHECKED BY: DBT 1/2021

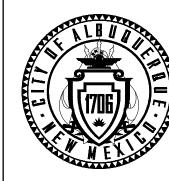

SCALE: 1"=30'

CITY OF ALBUQUERQUE DEPARTMENT OF MUNICIPAL DEVELOPMENT ENGINEERING DIVISION

MESA DEL SOL, INNOVATION PARK II HAWKING DRIVE POND GRADING AND DRAINAGE

DESIGN REVIEW COMMITTEE		CITY ENGINEER APPROVAL	ZONE MAP NO.				
				Q-	16-Z		
			CITY PROJECT NO. 393583				
			SHEET NO.		OF		
				1		1	