## CITY OF ALBUQUERQUE

*Planning Department* Brennon Williams, Director



Mayor Timothy M. Keller

July 9, 2021

Matthew Staches Bohannan Huston, Inc. 7500 Jefferson St. NE Albuquerque, NM 87109

RE: Kairos Power 5201 Hawking Dr. SE Permanent Certificate of Occupancy – Approved Grading and Drainage Plan Stamp Date: 9/9/20 Certification Date: 5/26/21 Hydrology File: Q16DA5000A

Dear Mr. Satches:

PO Box 1293 Based on the submittal received on 7/6/21 and site visit on 7/9/21, this submittal is approved for Permanent Certificate of Occupancy by Hydrology.

Albuquerque

If you have any questions, please contact me at 924-3986 or earmijo@cabq.gov.

NM 87103

Sincerely,

www.cabq.gov

Ernest Armijo, P.E. Principal Engineer, Planning Dept. Development Review Services



### City of Albuquerque


Planning Department Development & Building Services Division DRAINAGE AND TRANSPORTATION INFORMATION SHEET (REV 11/2018)

Project Title:	Building	g Permit #: Hydrology File #:
DRB#:	EPC#:	Work Order#:
Legal Description:		
City Address:		
Applicant:		Contact:
Address:		
		E-mail:
Owner:		Contact:
Address:		
Phone#:	Fax#:	E-mail:
TYPE OF SUBMITTAL: PLAT (	# OF LOTS)	RESIDENCE DRB SITE ADMIN SITE
IS THIS A RESUBMITTAL?:	Yes	No
DEPARTMENT: TRAFFIC/ TRA	ANSPORTATION	HYDROLOGY/ DRAINAGE
Check all that Apply:		TYPE OF APPROVAL/ACCEPTANCE SOUGHT:
TYPE OF SUBMITTAL:		BUILDING PERMIT APPROVAL
ENGINEER/ARCHITECT CERTIF	ICATION	CERTIFICATE OF OCCUPANCY
CONCEPTUAL G & D PLAN		PRELIMINARY PLAT APPROVAL
GRADING PLAN		SITE PLAN FOR SUB'D APPROVAL
DRAINAGE MASTER PLAN		SITE PLAN FOR BLDG. PERMIT APPROVAL
DRAINAGE REPORT		FINAL PLAT APPROVAL SIA/ RELEASE OF FINANCIAL GUARANTEE
FLOODPLAIN DEVELOPMENT PI	ERMIT APPLIC	FOUNDATION PERMIT APPROVAL
ELEVATION CERTIFICATE		GRADING PERMIT APPROVAL
CLOMR/LOMR		OKADINO PERMIT APPROVAL
TRAFFIC CIRCULATION LAYOU	JT (TCL)	PAVING PERMIT APPROVAL
TRAFFIC IMPACT STUDY (TIS)		GRADING/ PAD CERTIFICATION
OTHER (SPECIFY)		WORK ORDER APPROVAL
PRE-DESIGN MEETING?		CLOMR/LOMR
		FLOODPLAIN DEVELOPMENT PERMIT
		OTHER (SPECIFY)
DATE SUBMITTED:	Bv	

COA STAFF:

ELECTRONIC SUBMITTAL RECEIVED:

FEE PAID:

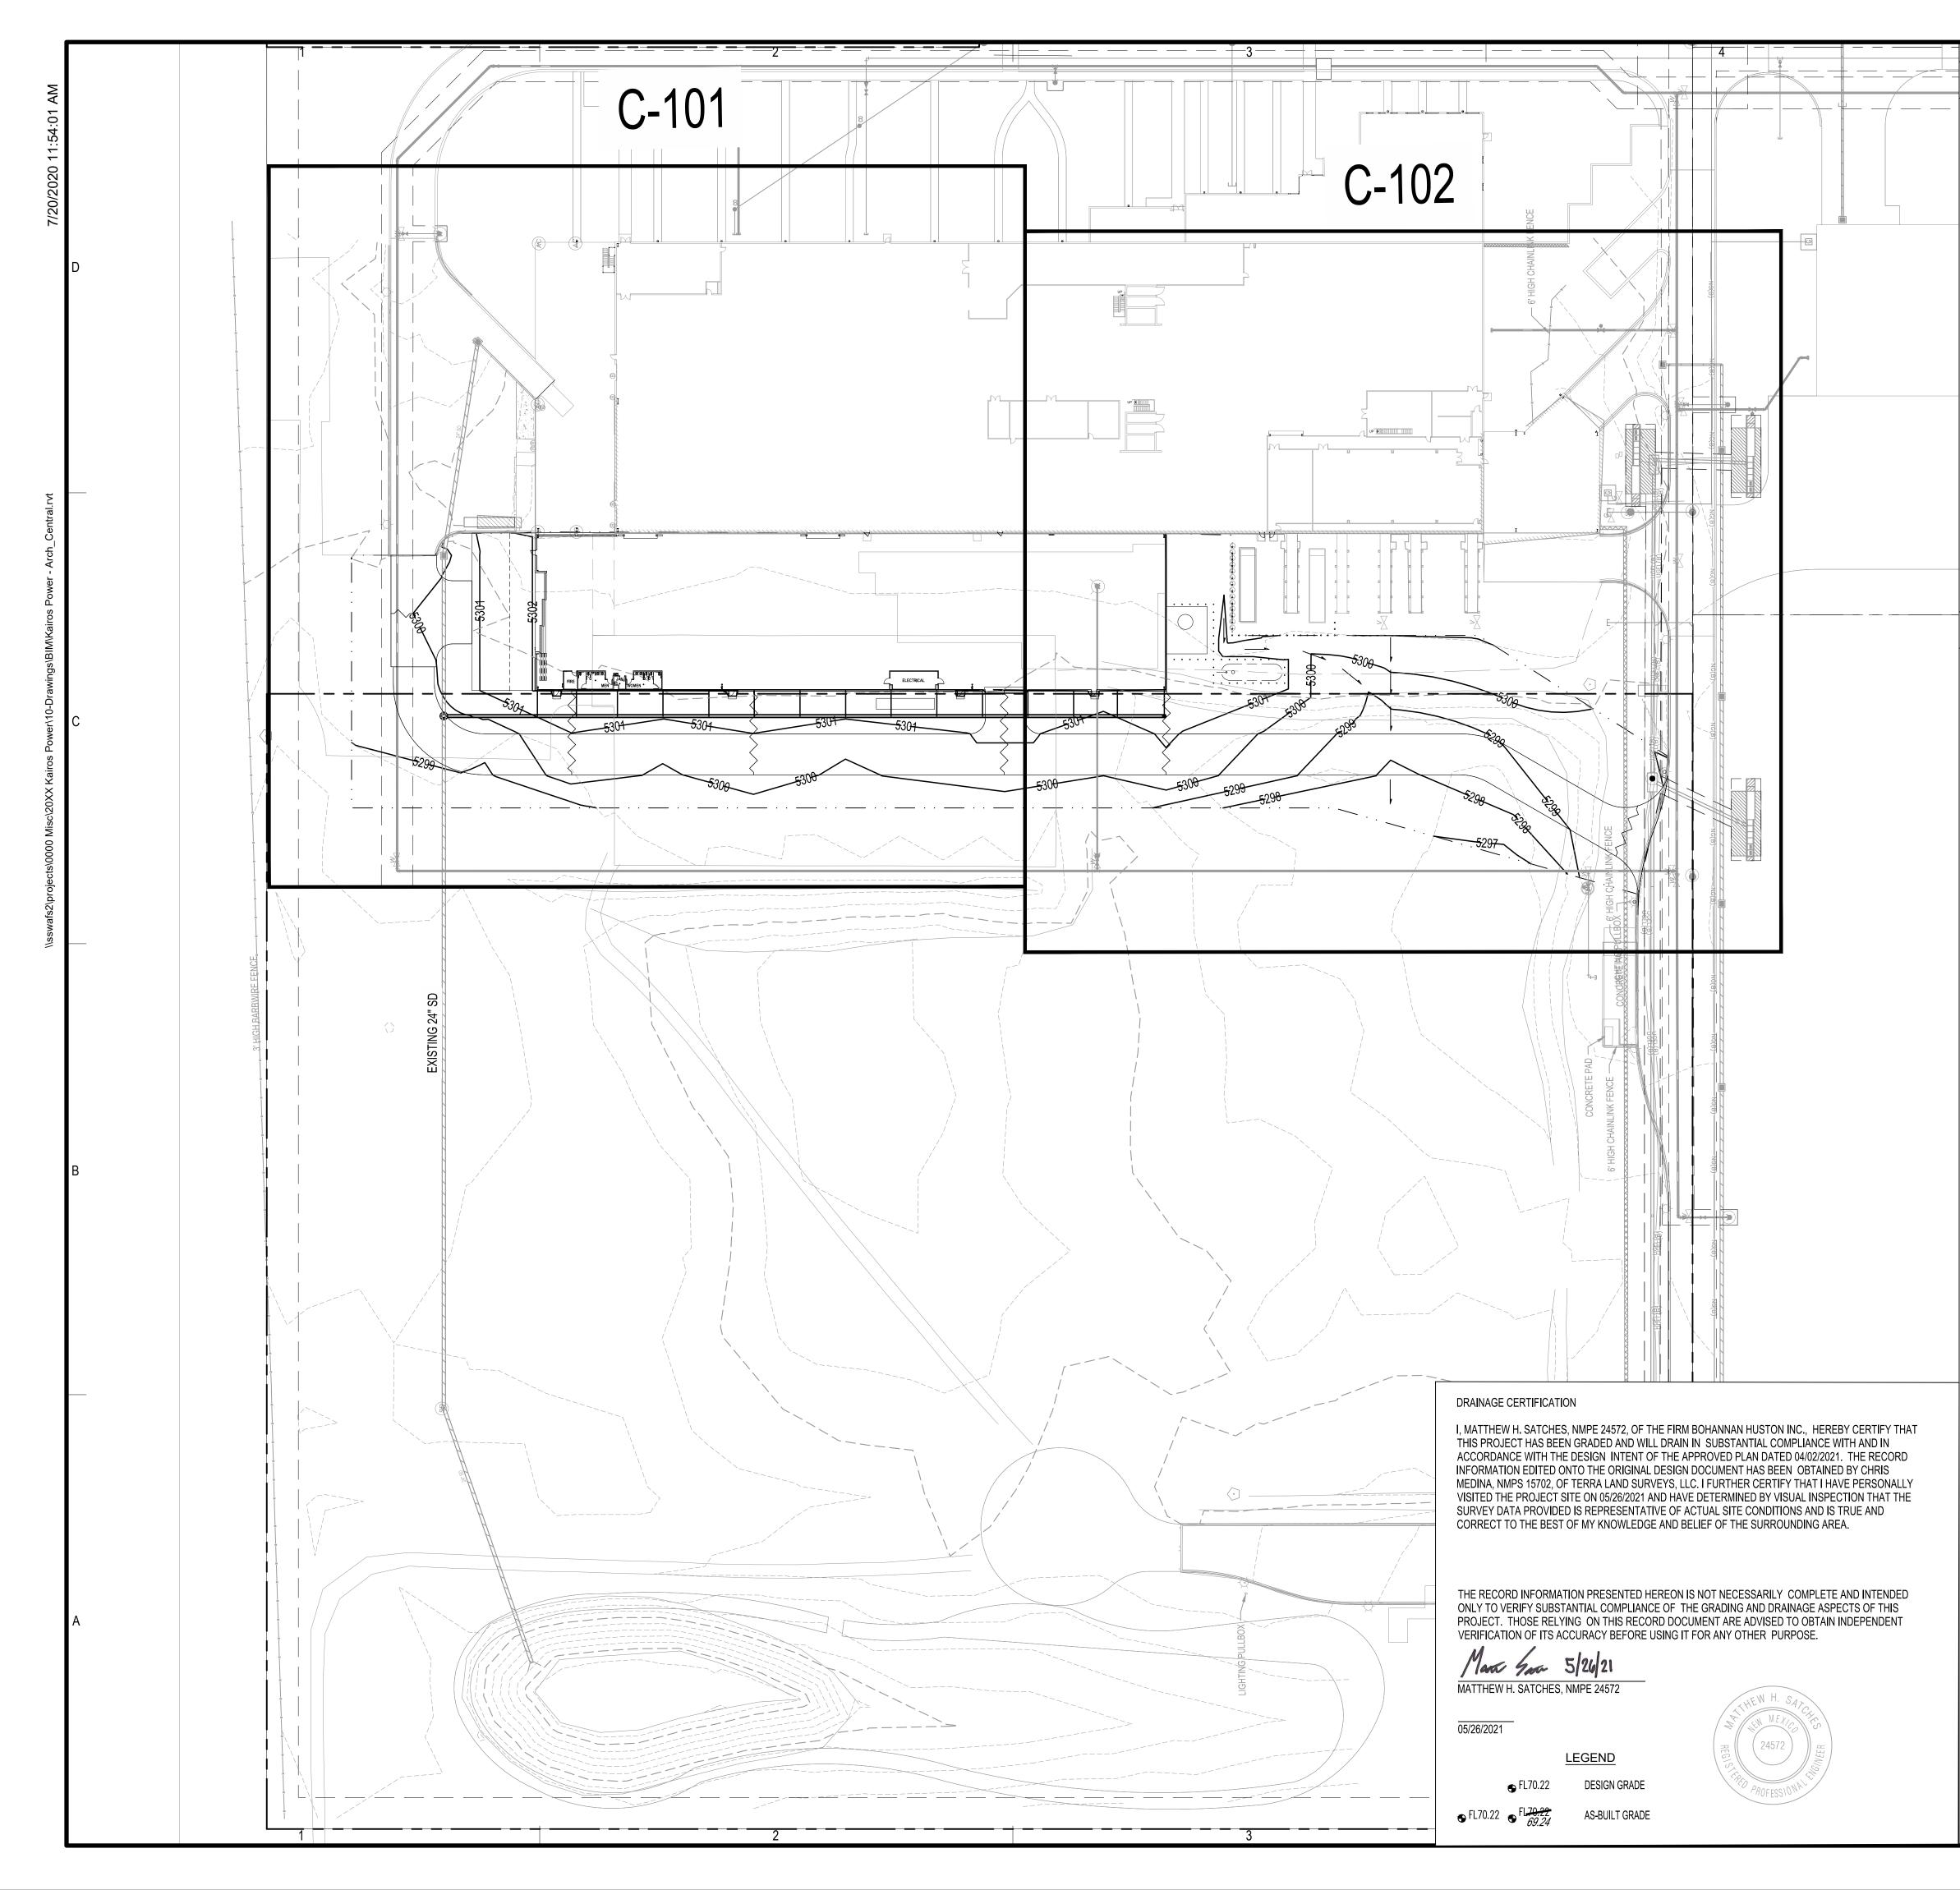


#### **GRADING NOTES**

- A. EXCEPT AS PROVIDED HEREIN, GRADING SHALL BE PERFORMED AT THE ELEVATIONS AND IN ACCORDANCE WITH THE DETAILS SHOWN ON THIS PLAN.
- B. THE COST FOR REQUIRED CONSTRUCTION DUST AND EROSION CONTROL MEASURES SHALL BE INCIDENTAL TO THE PROJECT COST, AND INCLUDED IN THE GMP.
- C. EARTH SLOPES SHALL NOT EXCEED 3 HORIZONTAL TO 1 VERTICAL UNLESS SHOWN OTHERWISED. IT IS THE INTENT OF THESE PLANS THAT THIS CONTRACTOR SHALL NOT PERFORM ANY WORK
- OUTSIDE OF THE PROPERTY BOUNDARIES EXCEPT AS REQUIRED BY THIS PLAN.
- E. THE CONTRACTOR SHALL ENSURE THAT NO SOIL ERODES FROM THE SITE ONTO ADJACENT PROPERTY OR PUBLIC RIGHT-OF-WAY.
- F. A DISPOSAL SITE FOR ANY & ALL EXCESS EXCAVATION MATERIAL, AND UNSUITABLE MATERIAL AND/OR A BORROW SITE CONTAINING ACCEPTABLE FILL MATERIAL SHALL BE OBTAINED BY THE CONTRACTOR IN COMPLIANCE WITH APPLICABLE ENVIRONMENTAL REGULATIONS AND APPROVED BY THE INSPECTOR. ALL COSTS INCURRED IN OBTAINING A DISPOSAL OR BORROW SITE AND HAUL TO OR FROM SHALL BE CONSIDERED INCIDENTAL TO THE PROJECT AND NO SEPARATE MEASUREMENT OR PAYMENT SHALL BE MADE.
- G. PAVING AND ROADWAY GRADES SHALL BE +/-0.1' FROM PLAN ELEVATIONS. PAD ELEVATION SHALL BE +/-0.05' FROM BUILDING PLAN ELEVATION.
- H. ALL PROPOSED CONTOURS REFLECT TOP OF PAVEMENT ELEVATIONS IN THE PARKING AREA AND MUST BE ADJUSTED FOR MEDIANS AND ISLANDS.
- I. VERIFY ALL ELEVATIONS SHOWN ON PLAN FROM BASIS OF ELEVATION CONTROL STATION PRIOR TO BEGINNING CONSTRUCTION.
- J. THE CONTRACTOR SHALL PROVIDE AS-BUILTS SURVEY DATA TO ENSURE COMPLIANCE WITH THE CONSTRUCTION DOCUMENTS. THE SURVEY SHALL BE PERFORMED BY A PROFESSIONAL SURVEYOR LICENSED IN THE THE STATE OF ARIZONA. THE AS-BUILT DRAWING SHALL BE CERTIFIED BY THE SURVEYOR OF RECORD.

#### **GENERAL NOTES**

- A. ALL WORK DETAILED ON THESE PLANS AND PERFORMED UNDER THIS CONTRACT SHALL BE CONSTRUCTED IN ACCORDANCE WITH THE PROJECT SPECIFICATIONS AND THE PROJECT GEOTECHNICAL REPORT. WHERE APPLICABLE, CITY OF ALBUQUERQUE STANDARD SPECIFICATIONS SHALL APPLY.
- B. THE CONTRACTOR SHALL ABIDE BY ALL LOCAL, STATE, AND FEDERAL LAWS, RULES AND REGULATIONS WHICH APPLY TO THE CONSTRUCTION OF THESE IMPROVEMENTS, INCLUDING EPA REQUIREMENTS WITH RESPECT TO STORM WATER DISCHARGE.
- C. PRIOR TO CONSTRUCTION, THE CONTRACTOR SHALL FIELD VERIFY THE HORIZONTAL AND VERTICAL LOCATIONS OF ALL POTENTIAL OBSTRUCTIONS INCLUDING ALL UNDERGROUND UTILITIES. SHOULD A CONFLICT EXIST, THE CONTRACTOR SHALL NOTIFY THE CONSTRUCTION OBSERVER OR ENGINEER SO THAT THE CONFLICT CAN BE RESOLVED WITH A MINIMUM AMOUNT OF DELAY.
- D. TWO (2) WORKING DAYS PRIOR TO ANY EXCAVATION, THE CONTRACTOR SHALL CONTACT LINE LOCATING SERVICE FOR LOCATION OF EXISTING UTILITIES.
- E. ALL ELECTRICAL, TELEPHONE, CABLE TV, GAS AND OTHER UTILITY LINES, CABLES, AND APPURTENANCES ENCOUNTERED DURING CONSTRUCTION THAT REQUIRE RELOCATION, SHALL BE COORDINATED WITH THAT UTILITY. THE CONTRACTOR SHALL BE RESPONSIBLE FOR COORDINATION OF ALL NECESSARY UTILITY ADJUSTMENTS. NO ADDITIONAL COMPENSATION WILL BE ALLOWED FOR DELAYS OR INCONVENIENCES CAUSED BY UTILITY COMPANY WORK CREWS. THE CONTRACTOR MAY BE REQUIRED TO RESCHEDULE HIS ACTIVITIES TO ALLOW UTILITY CREWS TO PERFORM THEIR REQUIRED WORK.
- F. THE CONTRACTOR IS RESPONSIBLE FOR PROTECTING ALL EXISTING UTILITY LINES WITHIN THE CONSTRUCTION AREA. ANY DAMAGE TO EXISTING FACILITIES CAUSED BY CONSTRUCTION ACTIVITY SHALL BE REPAIRED OR REPLACED AT THE CONTRACTOR'S EXPENSE AND APPROVED BY THE CONSTRUCTION OBSERVER.
- G. CONSTRUCTION ACTIVITY SHALL BE LIMITED TO THE PROPERTY AND/OR PROJECT LIMITS. ANY DAMAGE TO ADJACENT PROPERTIES RESULTING FROM THE CONSTRUCTION PROCESS SHALL BE REPAIRED OR REPLACED AT THE CONTRACTOR'S EXPENSE.
- H. OVERNIGHT PARKING OF CONSTRUCTION EQUIPMENT SHALL NOT OBSTRUCT DRIVEWAYS OR DESIGNATED TRAFFIC LANES. THE CONTRACTOR SHALL NOT STORE ANY EQUIPMENT OR MATERIAL WITHIN THE PUBLIC RIGHT-OF-WAY.
- I. THE CONTRACTOR SHALL OBTAIN ALL THE NECESSARY PERMITS FOR THE PROJECT PRIOR TO COMMENCING CONSTRUCTION (I.E., BARRICADING, TOPSOIL DISTURBANCE, EXCAVATION PERMITS, EPA STORM WATER PERMITS, ETC.).
- J. ALL PROPERTY CORNERS DESTROYED DURING CONSTRUCTION SHALL BE REPLACED AT THE CONTRACTOR'S EXPENSE. ALL PROPERTY CORNERS MUST BE RESET BY A REGISTERED LAND SURVEYOR.
- K. THE CONTRACTOR SHALL PREPARE A CONSTRUCTION TRAFFIC CONTROL AND SIGNING PLAN AND OBTAIN APPROVAL OF SUCH PLAN FROM THE CITY OF ALBUQUERQUE, TRAFFIC ENGINEERING DEPARTMENT, PRIOR TO BEGINNING ANY CONSTRUCTION WORK ON OR ADJACENT TO EXISTING STREETS.
- L. ALL BARRICADES AND CONSTRUCTION SIGNING SHALL CONFORM TO APPLICABLE SECTIONS OF THE "MANUAL ON UNIFORM TRAFFIC CONTROL DEVICES" (MUTCD), US DEPARTMENT OF TRANSPORTATION, LATEST EDITION.
- M. THE CONTRACTOR SHALL MAINTAIN ALL CONSTRUCTION BARRICADES AND SIGNING AT ALL TIMES. THE CONTRACTOR SHALL VERIFY THE PROPER LOCATION OF ALL BARRICADING AT THE END AND BEGINNING OF EACH DAY.
- N. THE CONTRACTOR SHALL TAKE ALL STEPS NECESSARY TO CONFORM WITH EPA REQUIREMENTS, INCLUDING COMPLIANCE WITH NPDES PHASE 2 REQUIREMENTS.
- O. THE CONTRACTOR SHALL PROVIDE 1 HARD COPY AND 1 ELECTRONIC COPY OF THE EPA STORM WATER POLLUTION PREVENTION PLAN ALONG WITH THE APPROPRIATE SUBMITTAL FEE TO CITY OF ALBUQUERQUE TWO WEEKS PRIOR TO THE START OF SITE DISTURBANCE.

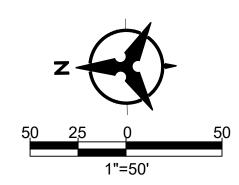

Bohannan 🛦 Huston

www.bhinc.com

800.877.5332



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CONSULTANTS

Architect

Engineer




# **C** Kairos Power T-FACILITY MODIFICATIONS AND ADDITION

5201 HAWKING DRIVE SE ALBUQUERQUE, NM 87105

Key Plan NTS /6\ASI006 | 05/06/2021 | HYDROLOGY APPROVAL Date No Description **Revision Schedule** ISSUE: BUILDING PERMIT PROJECT NUMBER: 20210099 FILE: DRAWN BY: BF CHECKED BY: MS 4/02/2021 DATE: SHEET TITLE OVERALL **GRADING PLAN** 



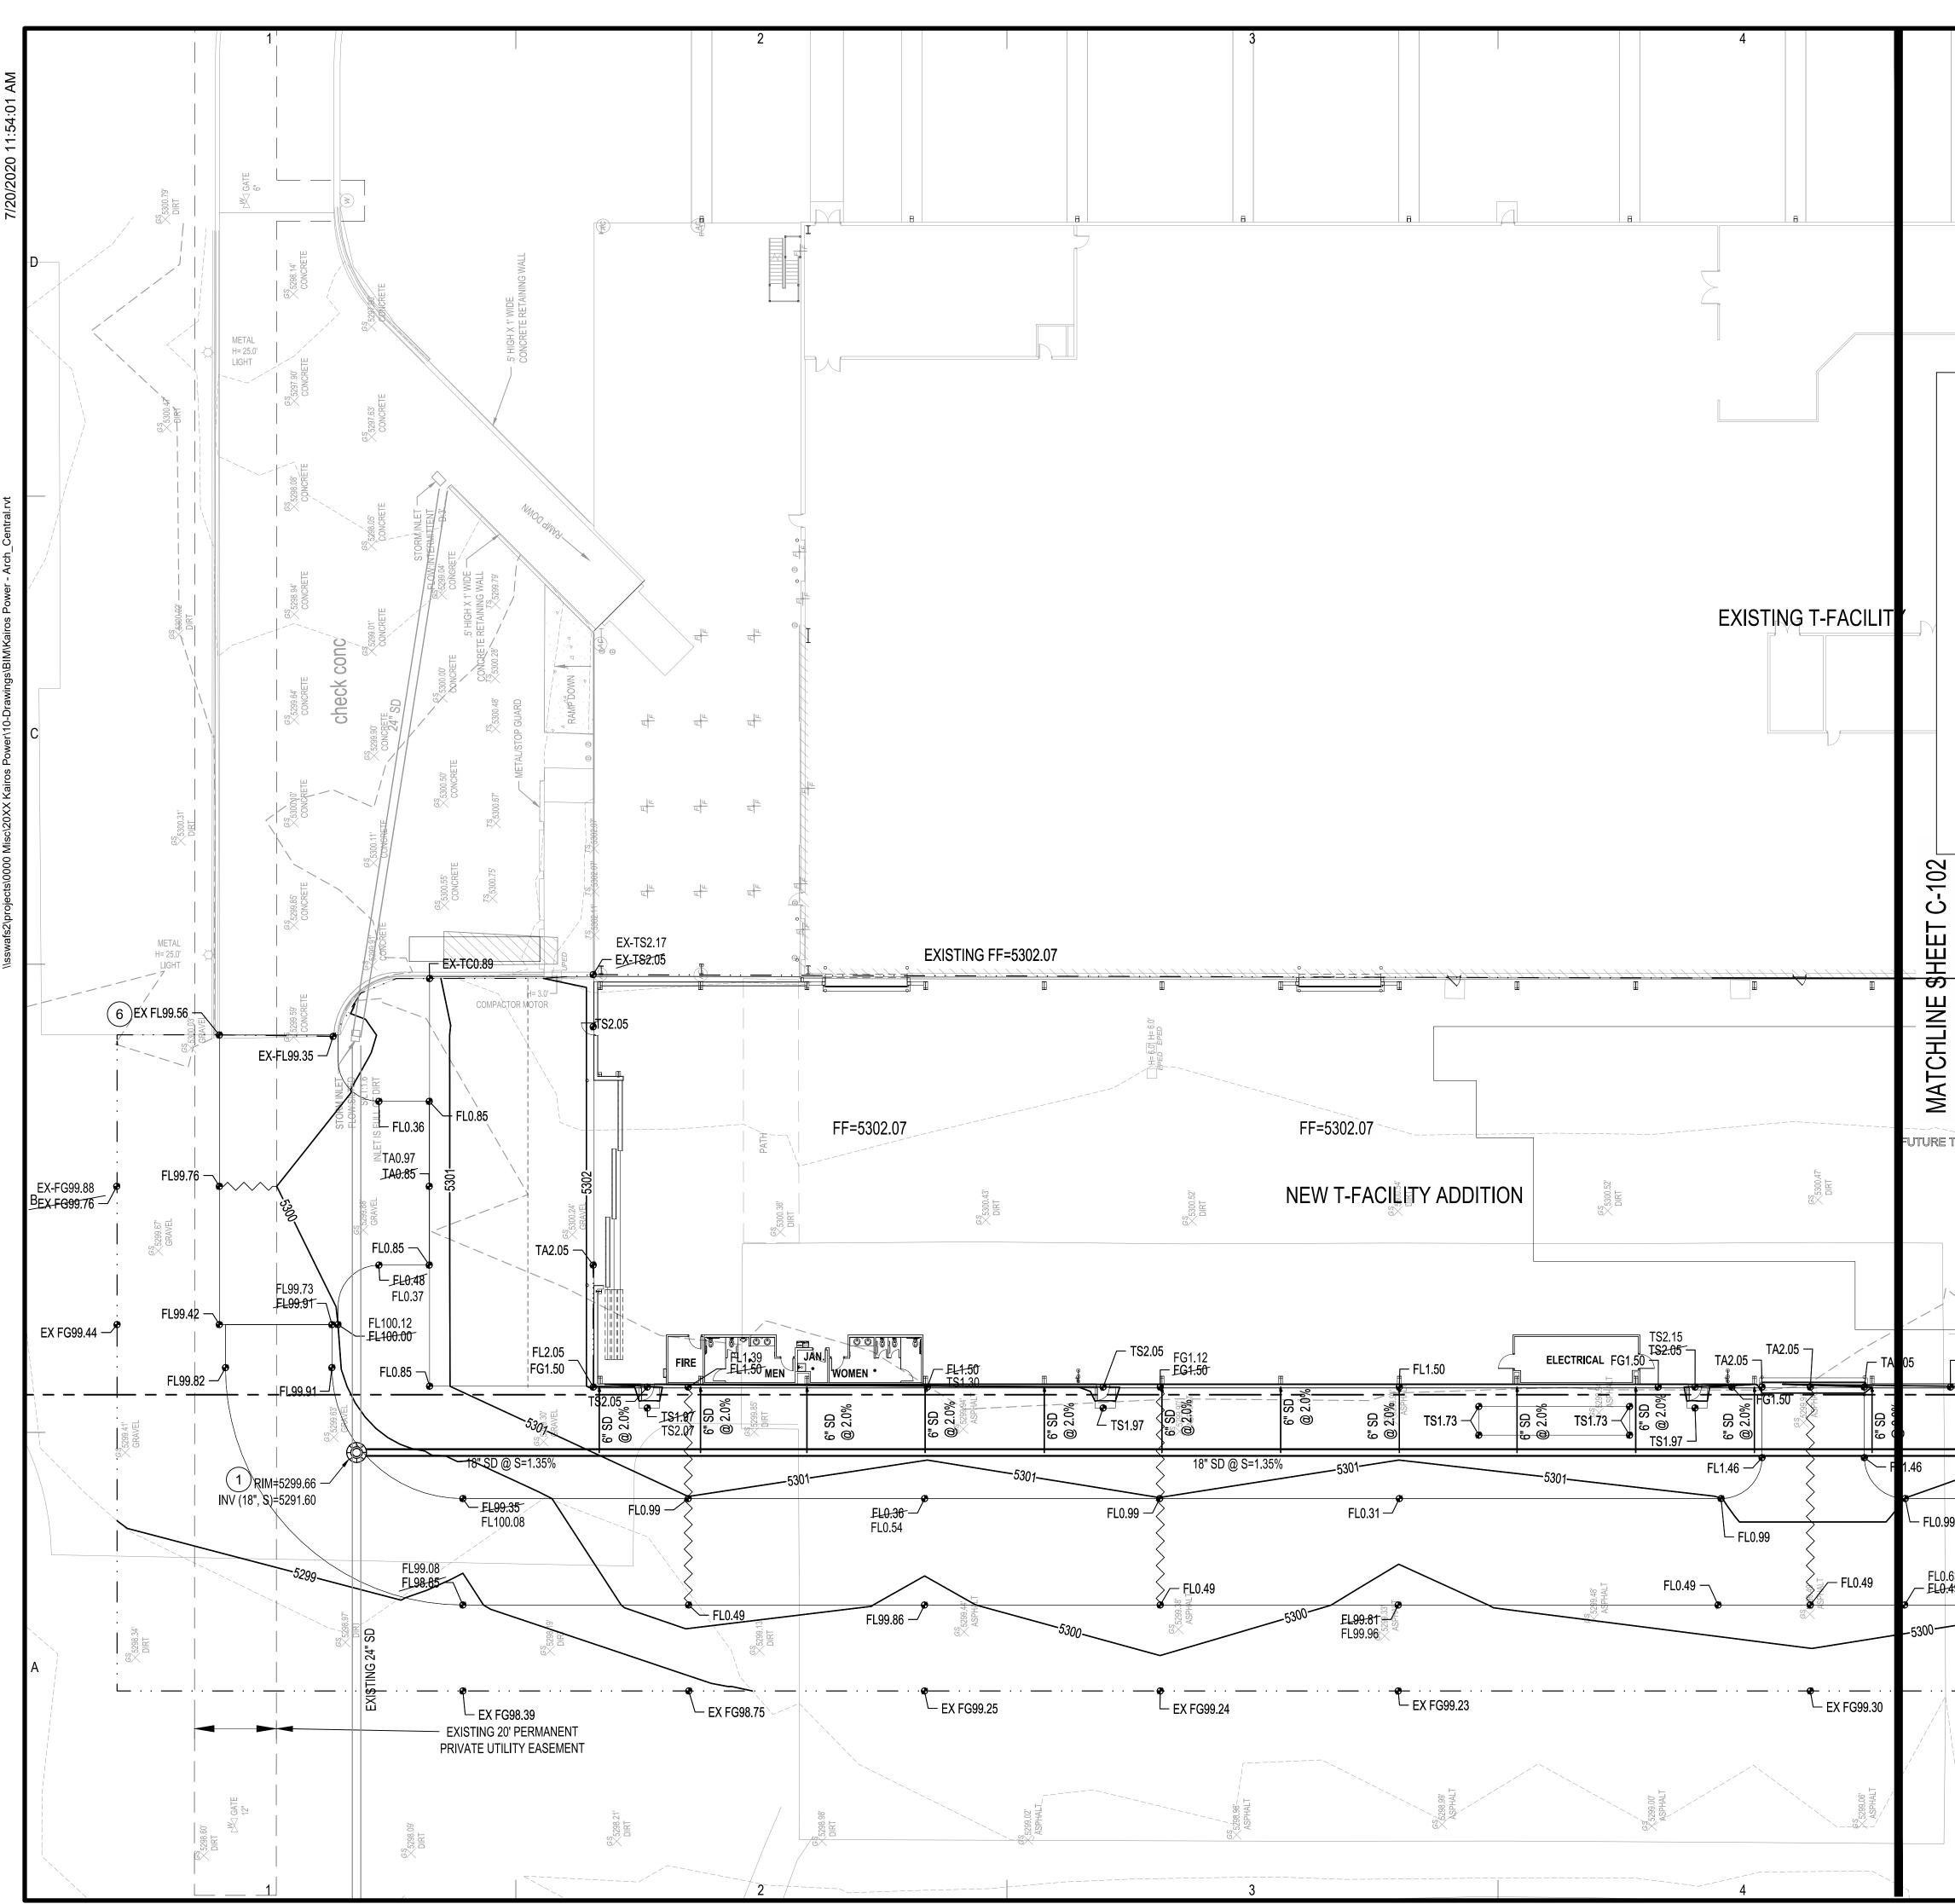

	$\bigcirc$ <b>GRADING KEYED</b> <sup>5</sup> NOTES	
		ARCHITECTS
	<ol> <li>CONNECT TO EXISTING STORM DRAIN. CONSTRUCT 4' DIA TYPE "E" STORM DRAIN MANHOLE PER NMAPWA STD DWG 2102.</li> <li>INSTALL HDPE (N12WT, OR APPROVED EQUAL) STORM DRAIN PIPE. SEE PLAN FOR SIZE &amp;</li> </ol>	2101 Mountain Road NW Suite B   Albuquerque NM 87104 505-843-9639   www.studioswarch.com
	<ul><li>SLOPE.</li><li>3. INSTALL STORM DRAIN PIPE TO WITHIN 5' OF BUILDING. SEE PLUMBING PLANS FOR</li></ul>	
8	<ul><li>CONTINUATION. INVERT OF ROOF DRAIN TO BE 3' BELOW FINISHED FLOOR MINIMUM.</li><li>4. EXISTING INLET TO REMAIN.</li></ul>	© 2019 Studio Southwest Architects, Inc. Duplication or reproduction by any
	<ol> <li>INSTALL PREFABRICATED STORM DRAIN FITTING. SEE PLAN FOR SIZE.</li> </ol>	means without the express written consent of Studio Southwest Architects, Inc. is a violation of federal and international law. The information contained in
	6. MATCH EXISTING ELEVATION.	and all rights thereto are reserved.
	7. BEGIN TRANSITION FROM STANDARD CURB & GUTTER TO FLUSH CURB.	CONSULTANTS
	8. END TRANSITION FROM STANDARD CURB & GUTTER TO FLUSH CURB.	
I, MATT This P Accof Infori Medin, Visite Surve	AGE CERTIFICATION THEW H. SATCHES, NMPE 24572, OF THE FIRM BOHANNAN HUSTON INC., HEREBY CERTIFY THAT ROJECT HAS BEEN GRADED AND WILL DRAIN IN SUBSTANTIAL COMPLIANCE WITH AND IN RDANCE WITH THE DESIGN INTENT OF THE APPROVED PLAN DATED 04/02/2021. THE RECORD MATION EDITED ONTO THE ORIGINAL DESIGN DOCUMENT HAS BEEN OBTAINED BY CHRIS A, NMPS 15702, OF TERRA LAND SURVEYS, LLC. I FURTHER CERTIFY THAT I HAVE PERSONALLY D THE PROJECT SITE ON 05/26/2021 AND HAVE DETERMINED BY VISUAL INSPECTION THAT THE Y DATA PROVIDED IS REPRESENTATIVE OF ACTUAL SITE CONDITIONS AND IS TRUE AND ECT TO THE BEST OF MY KNOWLEDGE AND BELIEF OF THE SURROUNDING AREA.	
	ECORD INFORMATION PRESENTED HEREON IS NOT NECESSARILY COMPLETE AND INTENDED TO VERIFY SUBSTANTIAL COMPLIANCE OF THE GRADING AND DRAINAGE ASPECTS OF THIS CCT. THOSE RELYING ON THIS RECORD DOCUMENT ARE ADVISED TO OBTAIN INDEPENDENT ICATION OF ITS ACCURACY BEFORE USING IT FOR ANY OTHER PURPOSE.	
05/26/2		Architect Engineer
	LEGEND	HEW H. SAN
⊕ FL70	<ul> <li>● FL70.22 DESIGN GRADE</li> <li>22 ● FL70.22 69.24</li> <li>AS-BUILT GRADE</li> </ul>	24572 PROFESSIONAL
<b>-</b> \		
EX	_	Kairos Power
		T-FACILITY MODIFICATIONS AND ADDITION
		5201 HAWKING DRIVE SE
TENÀN		ALBUQUERQUE, NM 87105
	E	
		Key Plan
\		NTS
- FG1.		
6" SD @ 2.0%		ASI006 05/06/2021 HYDROLOGY APPROVAL
@ o <sup>‡</sup>		No Date Description Revision Schedule
		ISSUE: BUILDING PERMIT
9		PROJECT NUMBER: 20210099 FILE:
63 <del>49</del>		DRAWN BY: BF CHECKED BY: MS
43		DATE: 4/02/2021
		SHEET TITLE
·	z C	GRADING PLAN
	20 10 0 20	DRAINAGE
	1"=20'	CERTIFICATION
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