CITY OF ALBUQUERQUE

Planning Department Alan Varela, Director



Mayor Timothy M. Keller

April 13, 2023

Christopher Whyman Dekker/ Perich/ Sabatini 7601 Jefferson St. Albuquerque, NM 87109

Re: Mesa del sol Tract A

Tract A University Blvd. SE

Conceptual Traffic Circulation Layout for DFT Approval

Engineer's Stamp 03-23-23 (R16-D097C)

Dear Mr. Whyman,

The conceptual TCL submittal received 03-24-2023 is approved for DHO and/or DFT submittal. When submitting this project through the building permit process, a full Traffic Circulation Layout will need to be submitted and approved prior to building permit.

PO Box 1293

When the site construction is completed and an inspection for Certificate of Occupancy (C.O.) is requested, use the original City stamped approved TCL for certification. Redline any minor changes and adjustments that were made in the field. A NM registered architect or engineer must stamp, sign, and date the certification TCL along with indicating that the development was built in "substantial compliance" with the TCL. Submit this certification, the TCL, and a completed <u>Drainage and Transportation Information Sheet</u> to front counter personnel for log in and evaluation by Transportation.

NM 87103

Albuquerque

Once verification of certification is completed and approved, notification will be made to Building Safety to issue Final C.O. To confirm that a final C.O. has been issued, call Building Safety at 924-3690.


www.cabq.gov


Sincerely,

Ernest Armijo, P.E.

Principal Engineer, Planning Dept. Development Review Services

C: CO Clerk, File

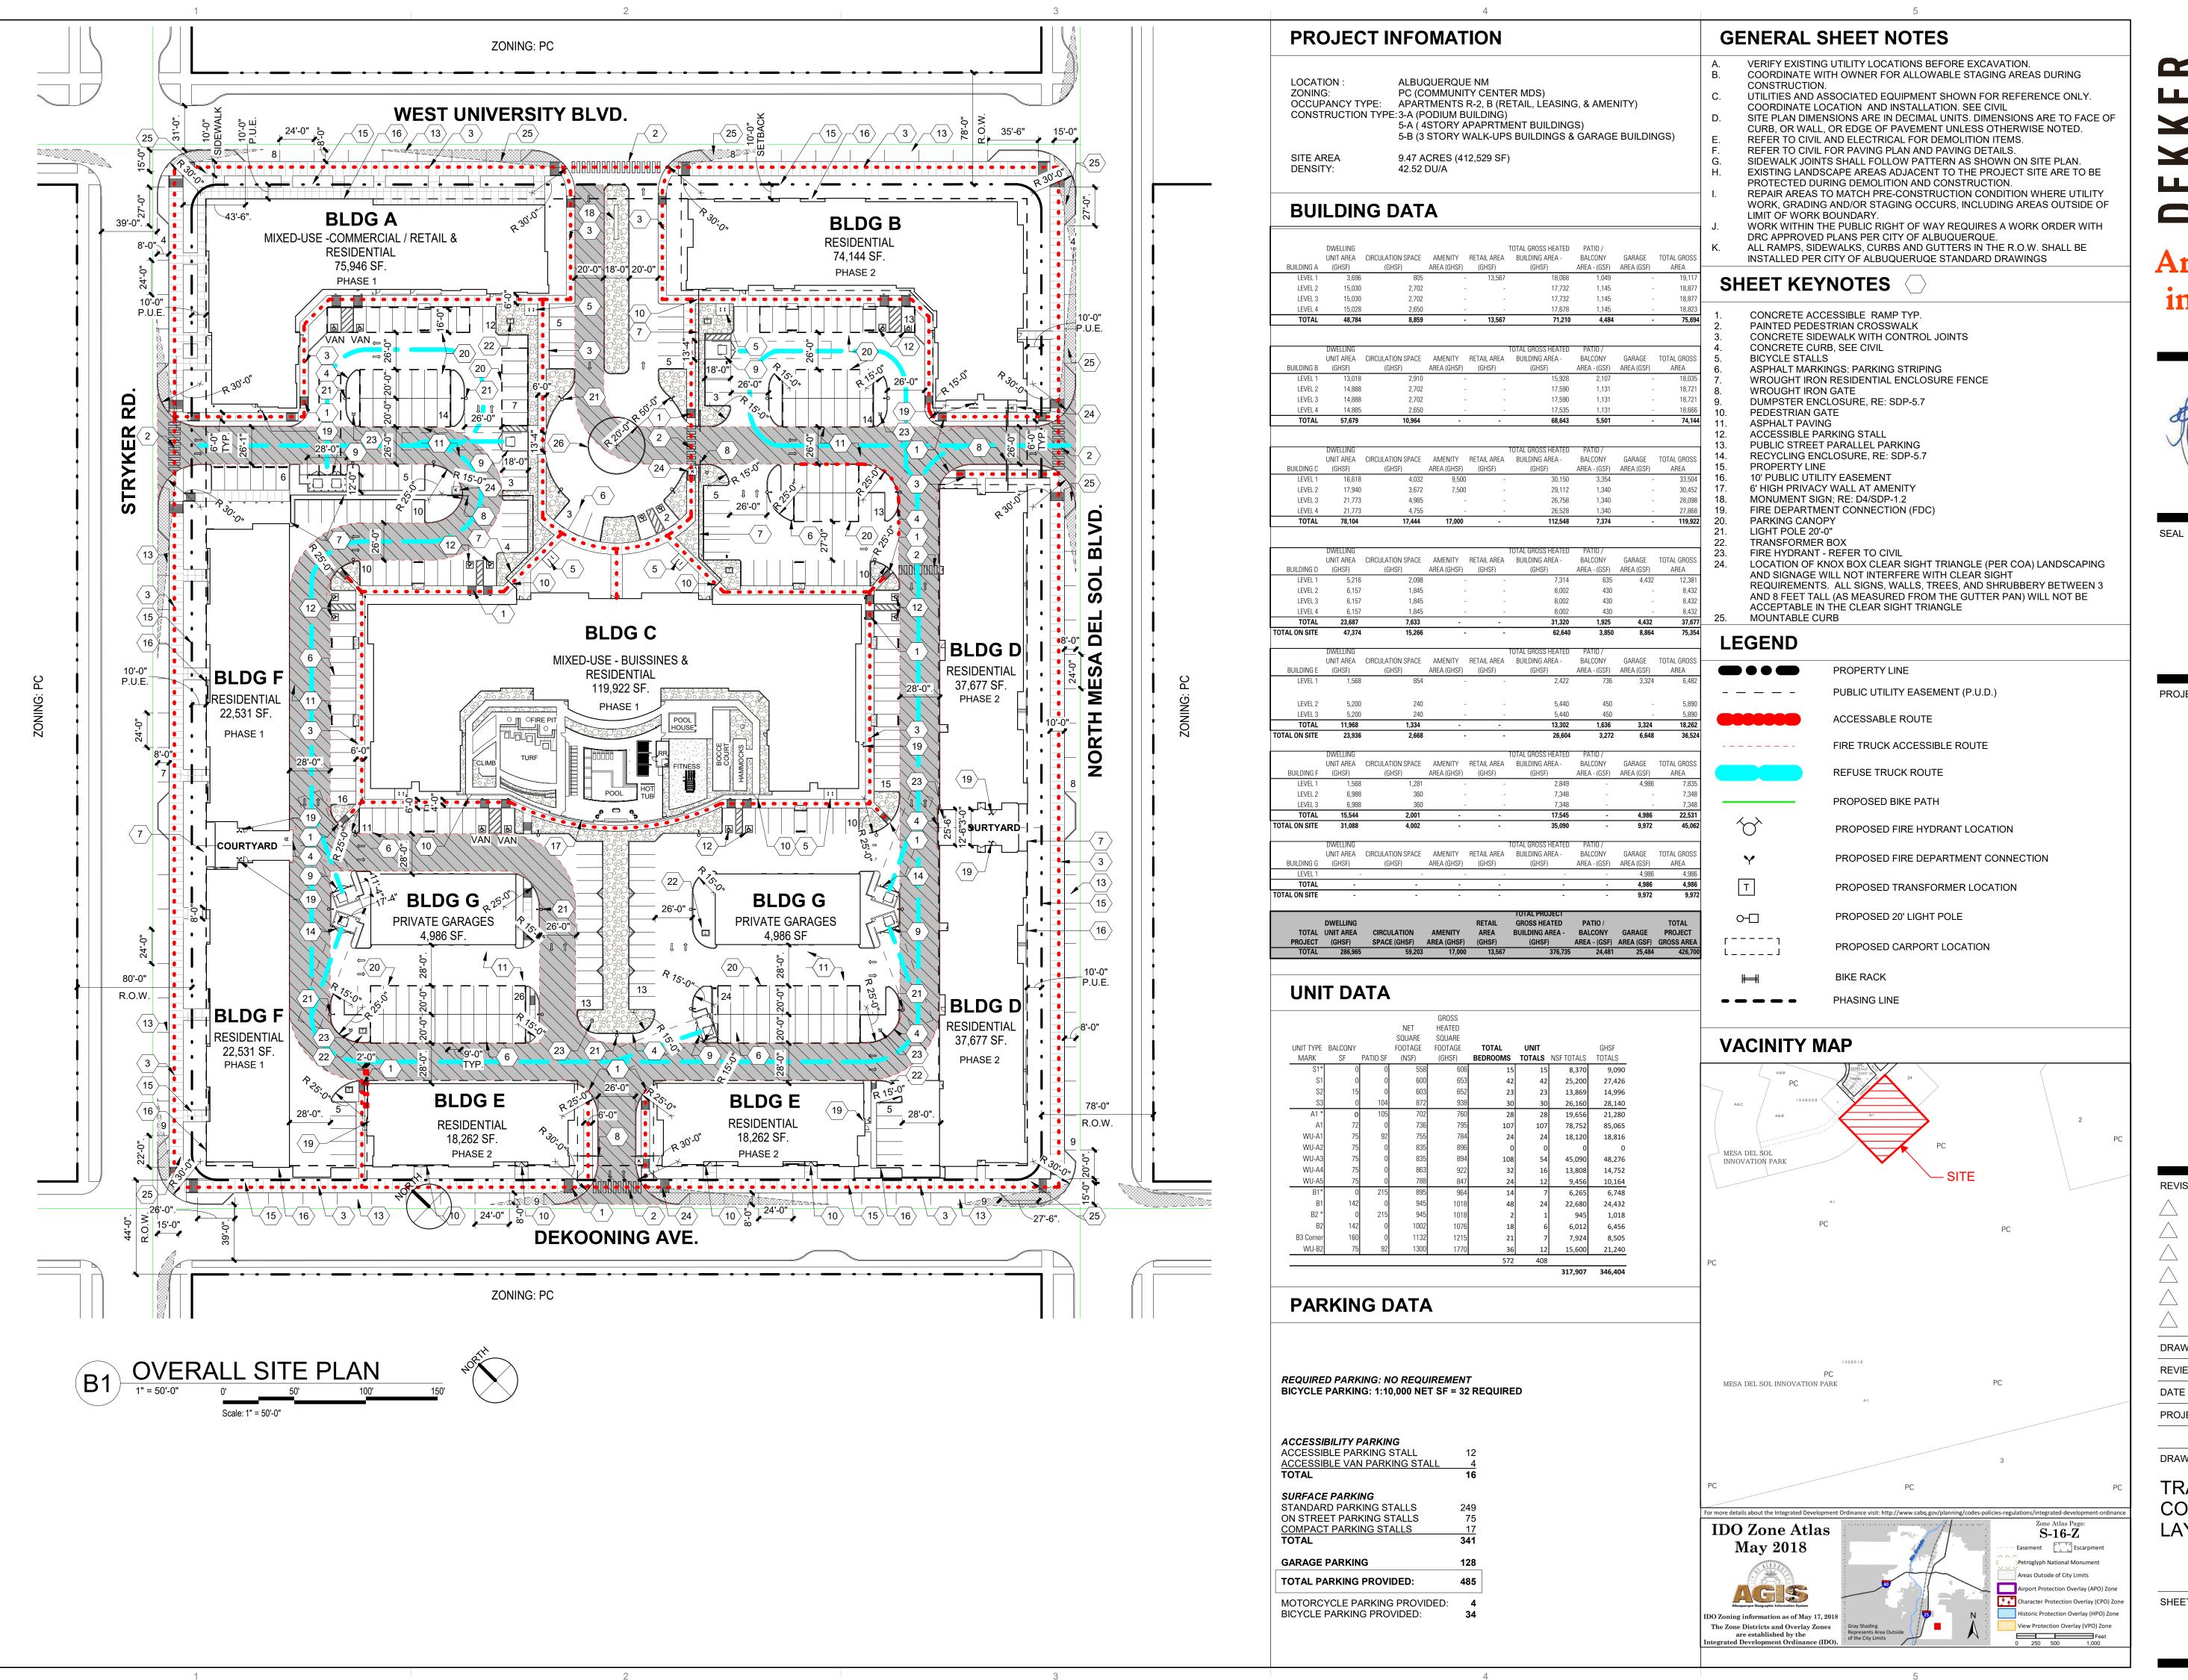

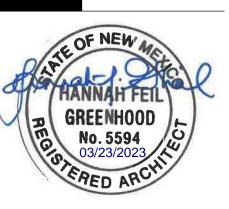

PROJECT

(Tract A) UNIVERSIT' SE ALBUQUERQUE, N DEL MESA

DRB


REVISIONS DRAWN BY TD - CWW CWW - HFG **REVIEWED BY** DATE 22/12/16 PROJECT NO: 22-0148

DRAWING NAME

TRAFFIC CONTROL LAYOUT

SHEET NO

TCL

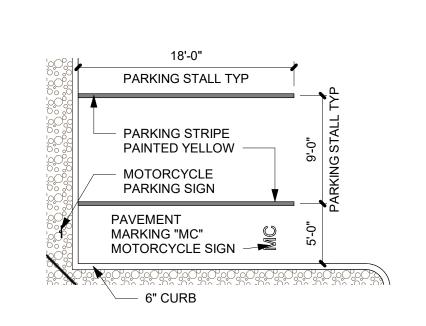

TYPICAL MOTORCYCLE PARKING STALL

METAL SIGNS PER STATE

TEXT: PLATE OR PLACARD

REQUIRED COLOR: GREEN

TEXT: RESERVED PARKING VIOLATORS ARE SUBJECT TO A

NMSA 1979. COLOR: RED

INDICATED ON PLAN

CONDITION VARIES

TYP ALL SIGNS

TYP, ALL SIGNS

A12 32ESIGNAGE01

6'-0"

1 3/4" x 1 3/4" SQ 14 GA

PERFORATED SIGN POST

2" SQUARE GROUND POST

COMPACTED SUBGRADE

8" □ CONCRETE FOOTING, TYP

WHEN CONDITION OCCURS IN

CONDITION VARIES, SEE SITE

— STOP BAR

CONDITION VARIES, SEE SITE

PLAN, ACCESSIBLE RAMP

 CURB AND GUTTER, SEE XX/XXXX

PLAN, ACCESSIBLE RAMP

SHOWN, SEE XX/XXXX

PAVING -

2'-0" WIDE

TRAFFIC PAINT, COLOR: WHITE

OF WAY USE REFLECTIVE PAINT.

FINE AND/OR TOWING 66-7-352.5

LOCAL CODES, COLOR: WHITE WITH GREEN FRAME

TEXT COLOR: GREEN SYMBOL COLOR: WHITE ON





TRAFFIC SIGNAGE

3. INSTALL PER MANUFACTURER'S DETAILS AND SPECIFICATIONS.

WIDTH VARIES. SEE SITE PLAN

DOMES @ 1.670" O/C

CAST-IN-PLACE CONCRETE, HEAVY

BROOM FINISH PERPENDICULAR TO

ASPHALT PAVING

8'-0"

SIDEWALK

FLUSH W/ CONCRETE

SIDEWALK

RAMP DOWN 1:12 SLOPE MAX.

SEE A1/SDP-1.2

HEADER CURB, SEE A4 / SDP-1.2

___ A3 ___

32PTACTILESURFACE01

SLOPE OF RAMP


1. MANUFACTURER: XXXX.

2. COLOR: XXXX.







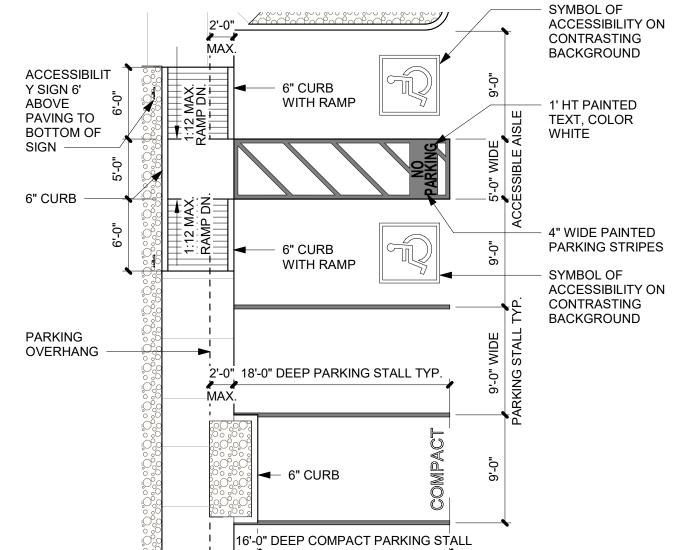

TYPICAL ACCESSIBLE PARKING STALL

9'-0" STANDARD 9'-0" WIDE


PARKING


OVERHANG


MAX. 2%


SLOPE,


RAMP DN

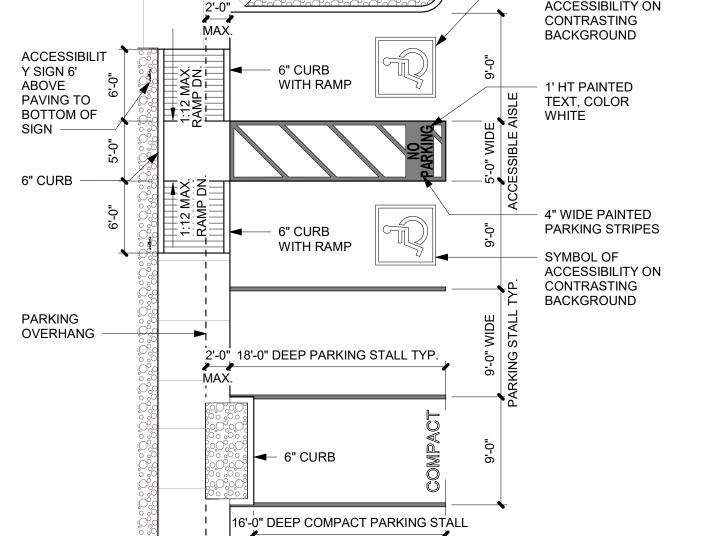


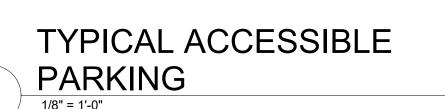


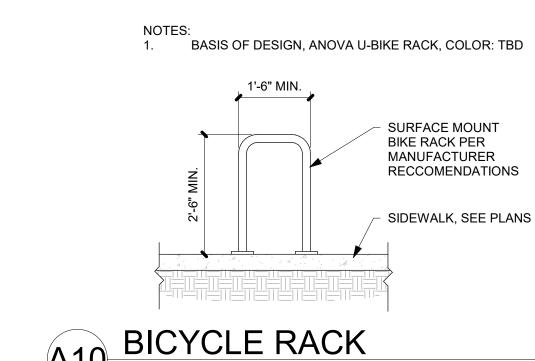

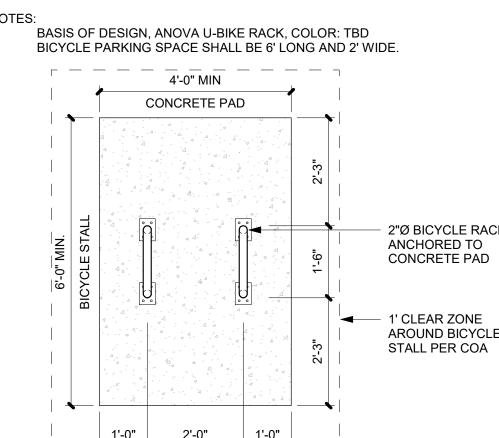


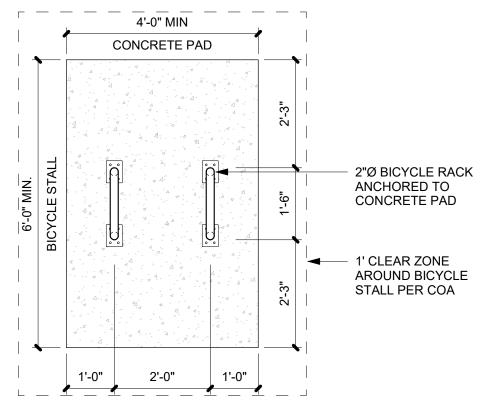

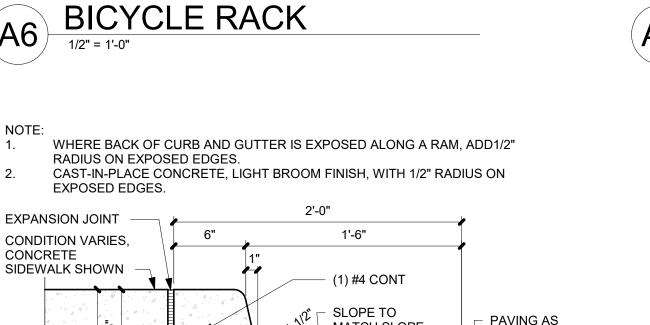


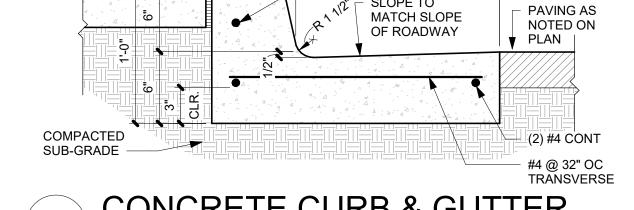


CONCRETE CURB & GUTTER

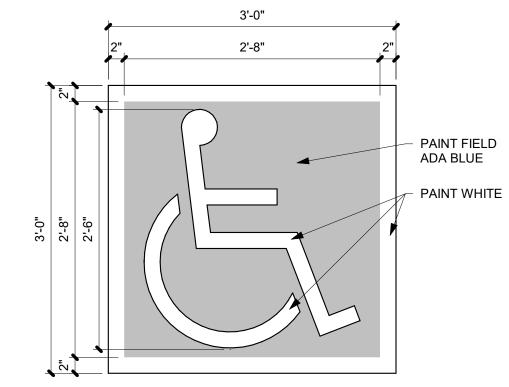




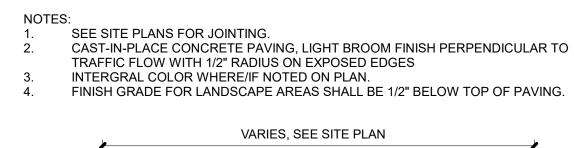


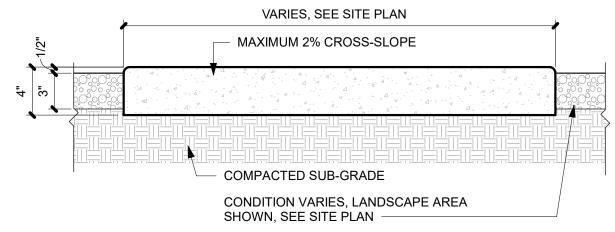



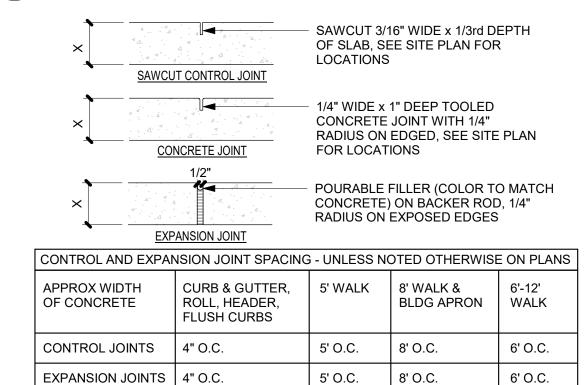

L					
	CONCRETE JOINTS & JOINT				
\ 	SPACING				
١,	1 1/2" = 1'-0"				

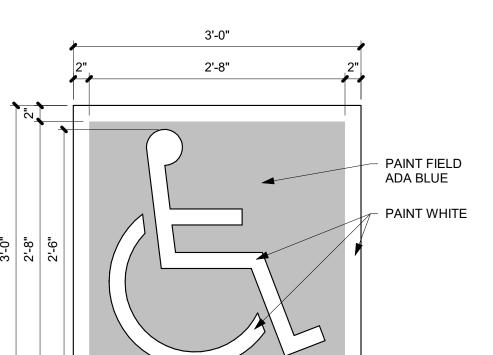

ACCESSIBILITY

BOTTOM OF SIGN

ASPHALT PAVING

AISLE, 4" WIDE, TYP

COLOR: ADA BLUE

INTERNATIONAL

ACCESSIBILITY

SYMBOL OF

Architecture

in Progress

PROJECT

FLUSH WITH

CONCRETE

SIDEWALK

SIGN 6' ABOVE **PAVING TO**

PARKING

OVERHANG

RAMP DN


— 6" CURB — WITH RAMP

9'-0" WIDE

PARKING STALL PARKING STALLACCESSIBLE AISLEPARKING SPACE

	VARIES, SEE SITE PLAN	b
_1/2"	MAXIMUM 2% CROSS-SLOPE	
4 8	COMPACTED SUB-GRADE CONDITION VARIES, LANDSCAPE AREA	



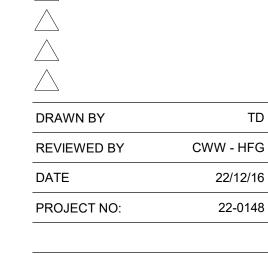

DRB

(Tract A) UNIVERSITY BLVD. SE ALBUQUERQUE, NM 87106

DEL

REVISIONS

ENLARGED SITE PLANS & DETAILS

DRAWING NAME

SHEET NO SDP-1.2

CONDITION VARIES, SEE SITE

ADJACENT PAVEMENT GRADE


PLAN. WHERE LANDSCAPE

MULCH TO 1/2" BELOW

(8A)

PAINTED CROSSWALK CAST-IN-PLACE CONCRETE, LIGHT BROOM FINISH, WITH 1/2" RADIUS ON **EXPOSED EDGES** (2) #4 CONT - #4 @ 48" O.C. VERTICAL CONDITION VARIES EXPANSION JOINT

CONCRETE HEADER CURB

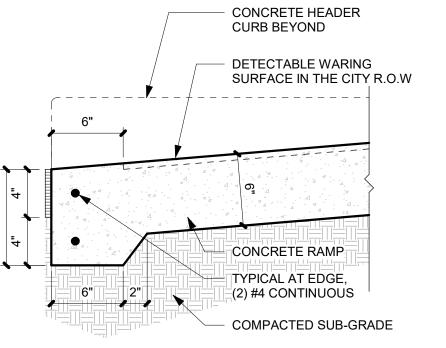

RAMP TRANSITION 1 1/2" = 1'-0"

ASPHALT

RAMP DOWN

1:12 SLOPE MAX.

EXP JOINT

SEE A1/SDP-1.2

SIDEWALK

PAINTED CROSSWALK