CITY OF ALBUQUERQUE

Planning Department Alan Varela, Director



February 3, 2023

Joshua Lutz, P.E. Bohannan Huston Inc. 7500 Jefferson St. NE Courtyard I Albuquerque, NM 87109

RE: Woodbury Apartments

Tract 17 Bulk Land Plat Tracts 1 through 18 Artiste, Mesa del Sol

Conceptual Grading and Drainage Plan

Engineer's Stamp Date: 1/27/2023

Hydrology File: R16D097C

Dear Mr. Lutz:

Based upon the information provided in your submittal received 2/2/2023, the Grading and Drainage Plans are approved for action by the DRB/DFT on Site Plan for Building Permit and SO-19 Permit. Please place this stamp approved Grading & Drainage Plan to the Grading and

PO Box 1293 B

Building Permitting set of construction drawings.

Albuquerque

As a reminder, if the project total area of disturbance (including the staging area and any work within the adjacent Right-of-Way) is 1 acre or more, then an Erosion and Sediment Control (ESC) Plan and Owner's certified Notice of Intent (NOI) is required to be submitted to the Stormwater Quality Engineer (Doug Hughes, PE, jhughes@cabq.gov, 924-3420) 14 days prior to any earth disturbance.

NM 87103

If you have any questions, please contact me at 505-924-3695 or tchen@cabq.gov.

www.cabq.gov

Sincerely,

Tiequan Chen, P.E.

Principal Engineer, Hydrology

Planning Department, Development Review Services

Tieque Cha



City of Albuquerque

Planning Department

Development & Building Services Division

DRAINAGE AND TRANSPORTATION INFORMATION SHEET (REV 11/2018)

Project Title:	Building P	ermit #: Hydrology File #:
		Work Order#:
Legal Description:		
City Address:		
Applicant:		Contact:
Address:		
		E-mail:
Owner:		Contact:
Address:		
		E-mail:
TYPE OF SUBMITTAL: PLA	T (# OF LOTS)	RESIDENCE DRB SITE ADMIN SITE
IS THIS A RESUBMITTAL?:	Yes	No
DEPARTMENT: TRAFFIC/ T	RANSPORTATION _	HYDROLOGY/ DRAINAGE
Check all that Apply: TYPE OF SUBMITTAL: ENGINEER/ARCHITECT CERT PAD CERTIFICATION CONCEPTUAL G & D PLAN GRADING PLAN DRAINAGE MASTER PLAN DRAINAGE REPORT FLOODPLAIN DEVELOPMENT ELEVATION CERTIFICATE CLOMR/LOMR TRAFFIC CIRCULATION LAY TRAFFIC IMPACT STUDY (TI OTHER (SPECIFY) PRE-DESIGN MEETING?	Γ PERMIT APPLIC OUT (TCL) S)	TYPE OF APPROVAL/ACCEPTANCE SOUGHT: BUILDING PERMIT APPROVAL CERTIFICATE OF OCCUPANCY PRELIMINARY PLAT APPROVAL SITE PLAN FOR SUB'D APPROVAL SITE PLAN FOR BLDG. PERMIT APPROVAL FINAL PLAT APPROVAL SIA/ RELEASE OF FINANCIAL GUARANTEE FOUNDATION PERMIT APPROVAL GRADING PERMIT APPROVAL SO-19 APPROVAL PAVING PERMIT APPROVAL GRADING/ PAD CERTIFICATION WORK ORDER APPROVAL CLOMR/LOMR FLOODPLAIN DEVELOPMENT PERMIT OTHER (SPECIFY)
DATE SURMITTED:	Bv·	

COA STAFF: ELECTRONIC SUBMITTAL RECEIVED:

FEE PAID:_____

Bohannan A Huston

January 27, 2023

7500 Jefferson St. NE Albuquerque, NM 87109-4335

www.bhinc.com

voice: 505.823.1000 facsimile: 505.798.7988 toll free: 800.877.5332

Tiequan Chen, PE Principal Engineer, Hydrology Planning Department, DRS 415 Silver Ave SW Albuquerque, NM 87102

Re: Comment Response Letter – Woodbury Apartments tract 17 Bulk Land Plat Tracts 1 through 18 Artiste, Mesa del Sol Conceptual Grading and Drainage Plan (Hydrology File: R16D097C)

Dear Mr. Chen,

Enclosed for your review is a copy of the <u>Mesa del Sol Grading and Drainage</u>
Plan. The revisions are based on comments received in your letter dated, <u>January 23</u>, 2023. Below is a brief description of how the comments were addressed:

- 1. Please insert vicinity map, FEMA FIRM map and change the scales on the plan to 1" = 50' per the DPM Section 6-14(C)(1)2b.
 - Conceptual Grading, Existing & Proposed Drainage Exhibits are changed to scale 1" = 50'. FEMA FIRM map has been included indicating the site location.
- 2. Provide the Benchmark information (location, description, and elevation) for the survey contour information provided.
 - Benchmark information has been included in all three exhibits.
- 3. The existing basins are 13.8 acres, but the development basins are 14.0 acres. Please verify.
 - Existing and developed basins have been updated and they now match
- 4. Add another column for the provided SWQV on the proposed conditions basin data table.
 - New column for SWQV has been added to the proposed conditions basin data table.
- 5. Cross-section A-A on Stryker Road seemed point to opposite direction.
 - Pointing direction of cross-section A-A on Stryker Road has been corrected.

Engineering **A**

Spatial Data A

Advanced Technologies

Hydrology Comment Response Letter Tiequan Chen January 27, 2023 Page 2

- 6. Add proposed SD pipe size on the plan.
 - Labels have been added for SD pipe sizes.
- 7. Is there DI missing at this location of the grading keyed note 4 should be changed to note 1 on sheet 1 of 1.
 - Grading keyed note has been changed to note 1.
- 8. Move this label to show the proposed SD pipe on sheet 1 of 1.
 - Label has been moved.
- 9. Provide pond 4 revised size showing that it can accommodate the discharge generated from this development.
 - Pond 4 expansion information has been included in the Conceptual Grading Exhibit.
- 10. Fix the sheet numbers.
 - Sheet numbers have been updated.

With this resubmittal, we are requesting hydrology approval for Site Plan Building Permit. If you have any questions or require further information, please feel free to contact me.


Sincerely,

Joshua Lutz, PE Project Manager

John Jut

Community Development & Planning

JLL/sms/kdl Enclosures

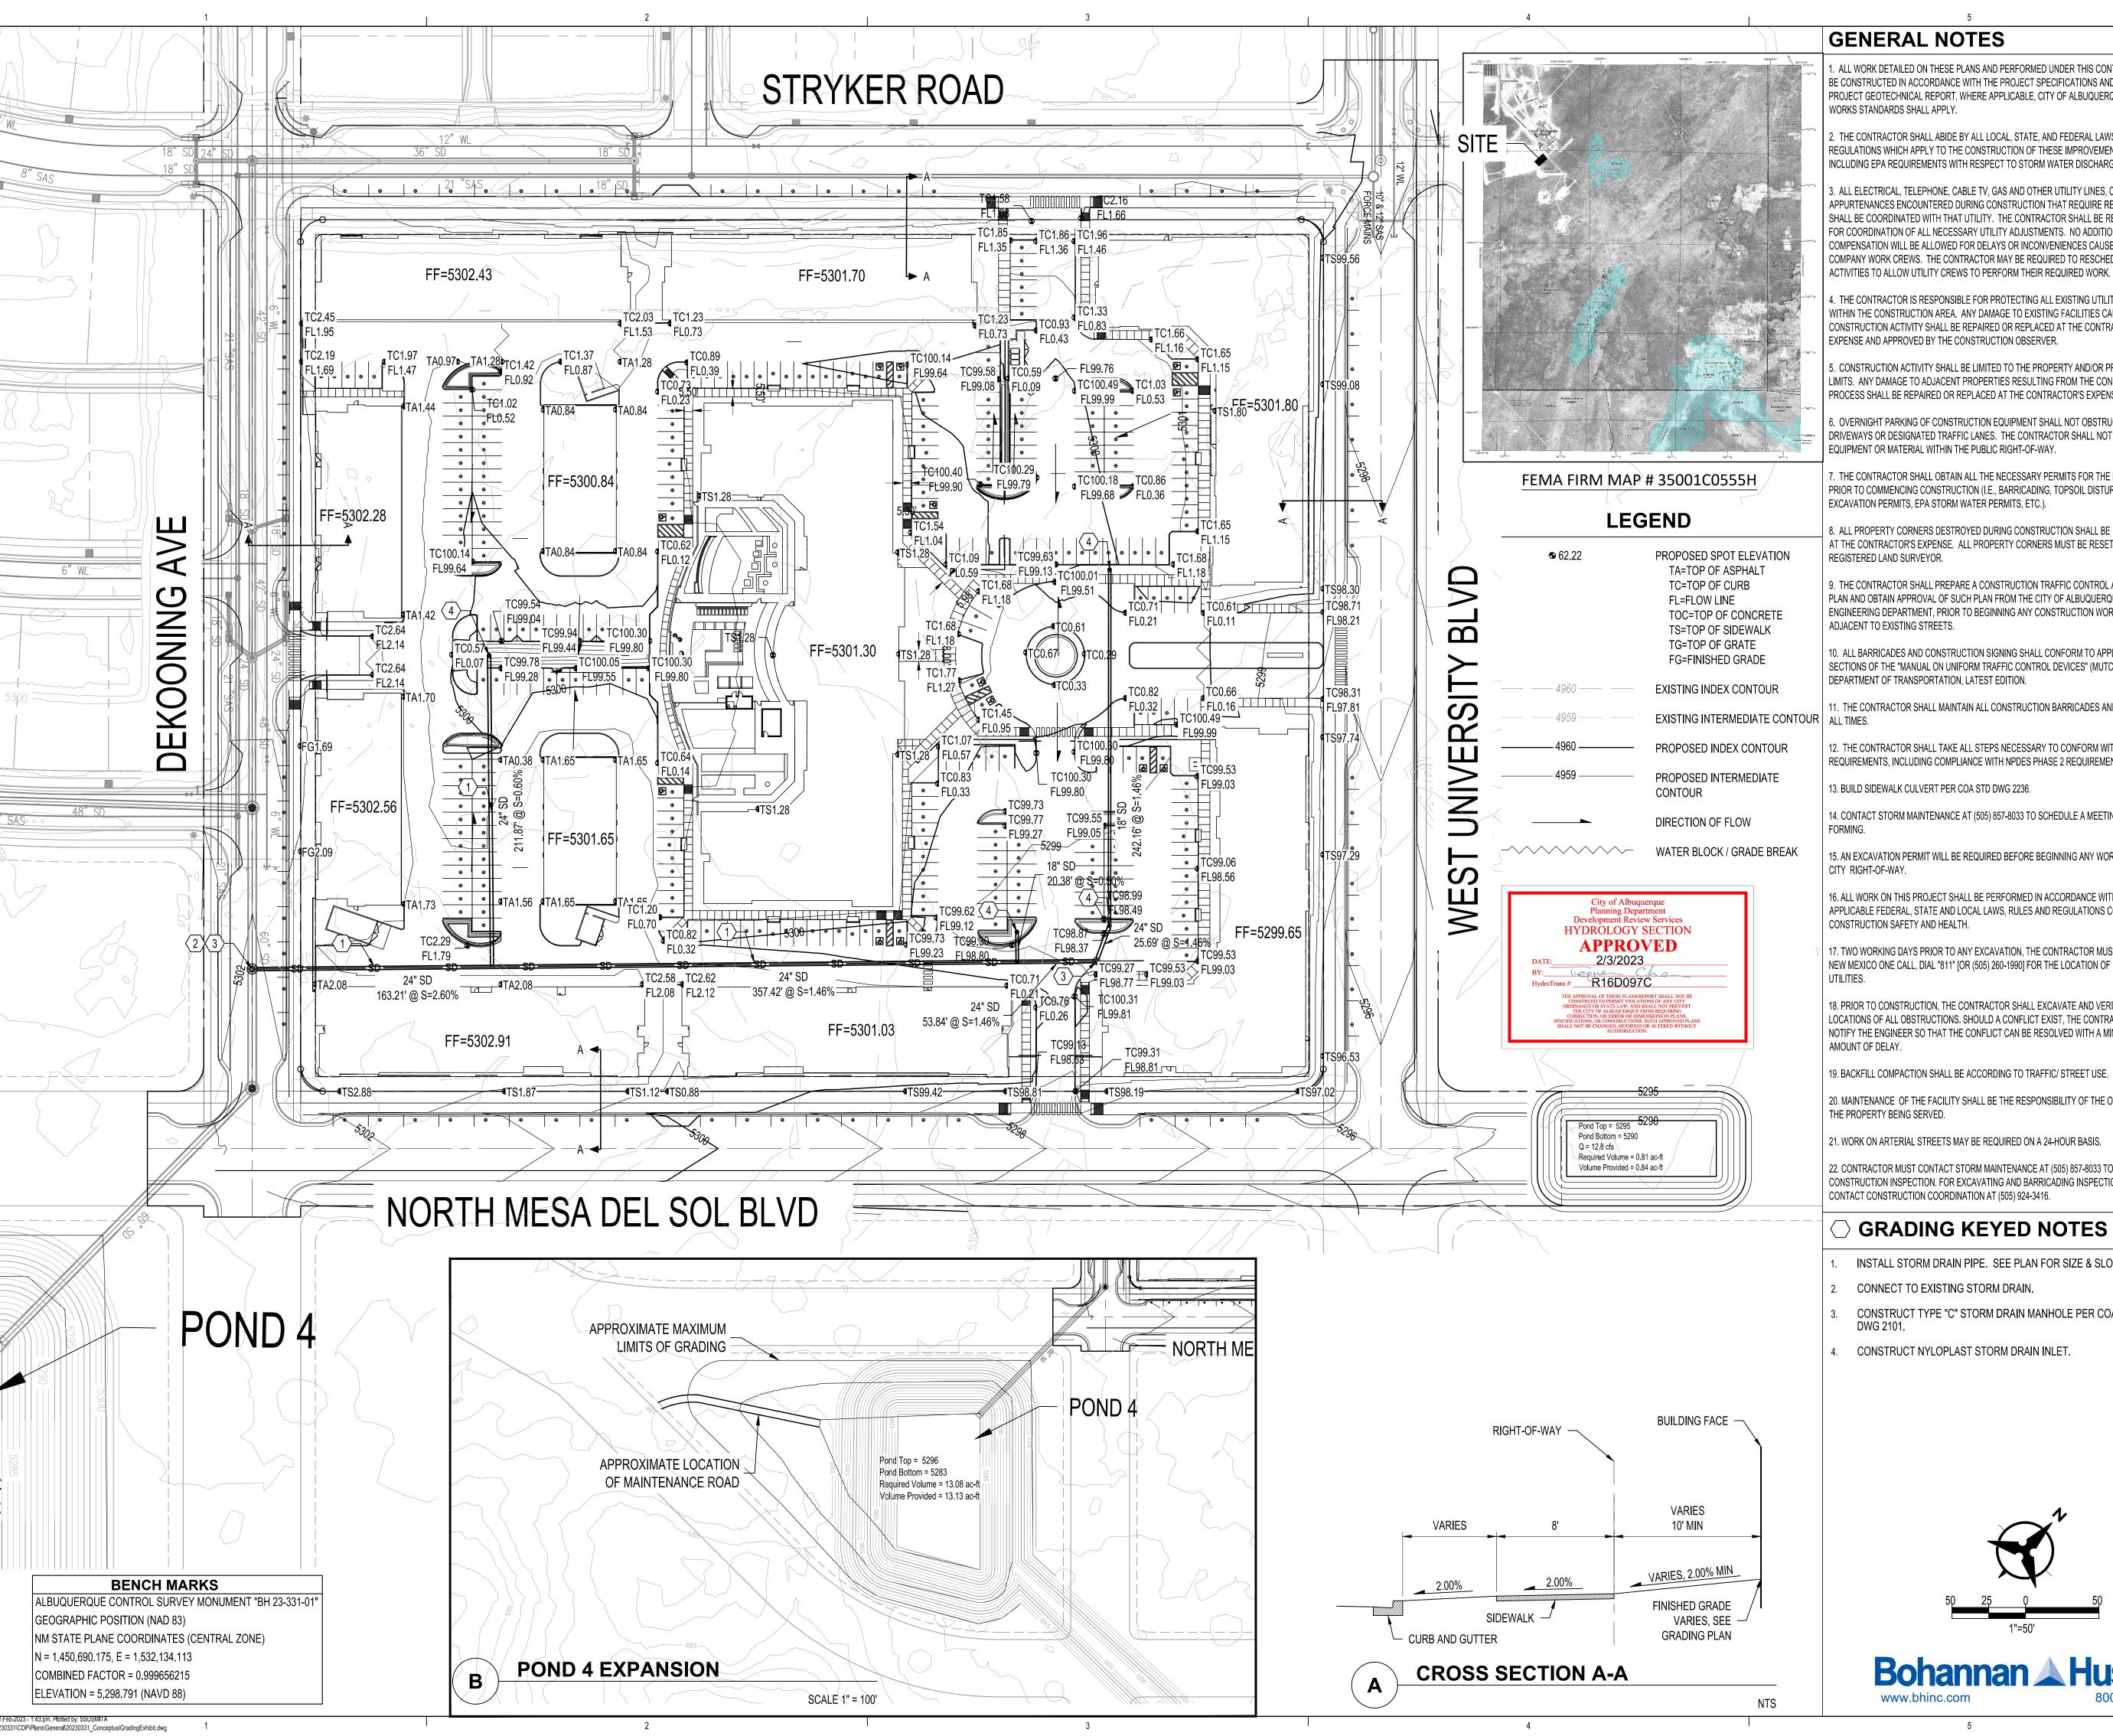

GENERAL NOTES

ALL WORK DETAILED ON THESE PLANS AND PERFORMED UNDER THIS CONTRACT SHALL PROJECT GEOTECHNICAL REPORT. WHERE APPLICABLE, CITY OF ALBUQUERQUE PUBLIC WORKS STANDARDS SHALL APPLY.

. THE CONTRACTOR SHALL ABIDE BY ALL LOCAL, STATE, AND FEDERAL LAWS, RULES AND REGULATIONS WHICH APPLY TO THE CONSTRUCTION OF THESE IMPROVEMENTS,

EXPENSE AND APPROVED BY THE CONSTRUCTION OBSERVER.

. OVERNIGHT PARKING OF CONSTRUCTION EQUIPMENT SHALL NOT OBSTRUCT RIVEWAYS OR DESIGNATED TRAFFIC LANES. THE CONTRACTOR SHALL NOT STORE ANY EQUIPMENT OR MATERIAL WITHIN THE PUBLIC RIGHT-OF-WAY.

. THE CONTRACTOR SHALL OBTAIN ALL THE NECESSARY PERMITS FOR THE PROJECT PRIOR TO COMMENCING CONSTRUCTION (I.E., BARRICADING, TOPSOIL DISTURBANCE, EXCAVATION PERMITS, EPA STORM WATER PERMITS, ETC.).

AT THE CONTRACTOR'S EXPENSE. ALL PROPERTY CORNERS MUST BE RESET BY A

9. THE CONTRACTOR SHALL PREPARE A CONSTRUCTION TRAFFIC CONTROL AND SIGNING PLAN AND OBTAIN APPROVAL OF SUCH PLAN FROM THE CITY OF ALBUQUERQUE, TRAFFIC ENGINEERING DEPARTMENT, PRIOR TO BEGINNING ANY CONSTRUCTION WORK ON OR

ALL BARRICADES AND CONSTRUCTION SIGNING SHALL CONFORM TO APPLICABLE SECTIONS OF THE "MANUAL ON UNIFORM TRAFFIC CONTROL DEVICES" (MUTCD), US DEPARTMENT OF TRANSPORTATION, LATEST EDITION.

11. THE CONTRACTOR SHALL MAINTAIN ALL CONSTRUCTION BARRICADES AND SIGNING AT

12. THE CONTRACTOR SHALL TAKE ALL STEPS NECESSARY TO CONFORM WITH EPA REQUIREMENTS, INCLUDING COMPLIANCE WITH NPDES PHASE 2 REQUIREMENTS

13. BUILD SIDEWALK CULVERT PER COA STD DWG 2236.

14. CONTACT STORM MAINTENANCE AT (505) 857-8033 TO SCHEDULE A MEETING PRIOR TO

15. AN EXCAVATION PERMIT WILL BE REQUIRED BEFORE BEGINNING ANY WORK WITHIN

16. ALL WORK ON THIS PROJECT SHALL BE PERFORMED IN ACCORDANCE WITH APPLICABLE FEDERAL, STATE AND LOCAL LAWS, RULES AND REGULATIONS CONCERNING

17. TWO WORKING DAYS PRIOR TO ANY EXCAVATION, THE CONTRACTOR MUST CONTACT NEW MEXICO ONE CALL, DIAL "811" [OR (505) 260-1990] FOR THE LOCATION OF EXISTING

18. PRIOR TO CONSTRUCTION, THE CONTRACTOR SHALL EXCAVATE AND VERIFY THE LOCATIONS OF ALL OBSTRUCTIONS. SHOULD A CONFLICT EXIST, THE CONTRACTOR SHALL NOTIFY THE ENGINEER SO THAT THE CONFLICT CAN BE RESOLVED WITH A MINIMUM


19. BACKFILL COMPACTION SHALL BE ACCORDING TO TRAFFIC/ STREET USE.

20. MAINTENANCE OF THE FACILITY SHALL BE THE RESPONSIBILITY OF THE OWNER OF

21. WORK ON ARTERIAL STREETS MAY BE REQUIRED ON A 24-HOUR BASIS.


22. CONTRACTOR MUST CONTACT STORM MAINTENANCE AT (505) 857-8033 TO SCHEDULE A CONSTRUCTION INSPECTION. FOR EXCAVATING AND BARRICADING INSPECTIONS, CONTACT CONSTRUCTION COORDINATION AT (505) 924-3416.

- INSTALL STORM DRAIN PIPE. SEE PLAN FOR SIZE & SLOPE.
- CONNECT TO EXISTING STORM DRAIN.
- CONSTRUCT TYPE "C" STORM DRAIN MANHOLE PER COA STD
- CONSTRUCT NYLOPLAST STORM DRAIN INLET.

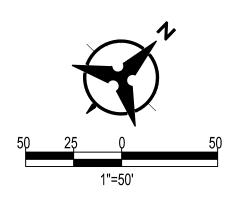

Bohannan A Huston www.bhinc.com

Architecture in Progress

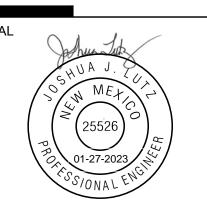

PROJECT

(Tract A) UNIVERSI SE ALBUQUERQUE,

ARC

REVISIONS


DRAWN BY

REVIEWED BY 01/20/2023 PROJECT NO. 22-0148

DRAWING NAME


CONCEPTUAL **GRADING EXHIBIT**

SHEET NO.

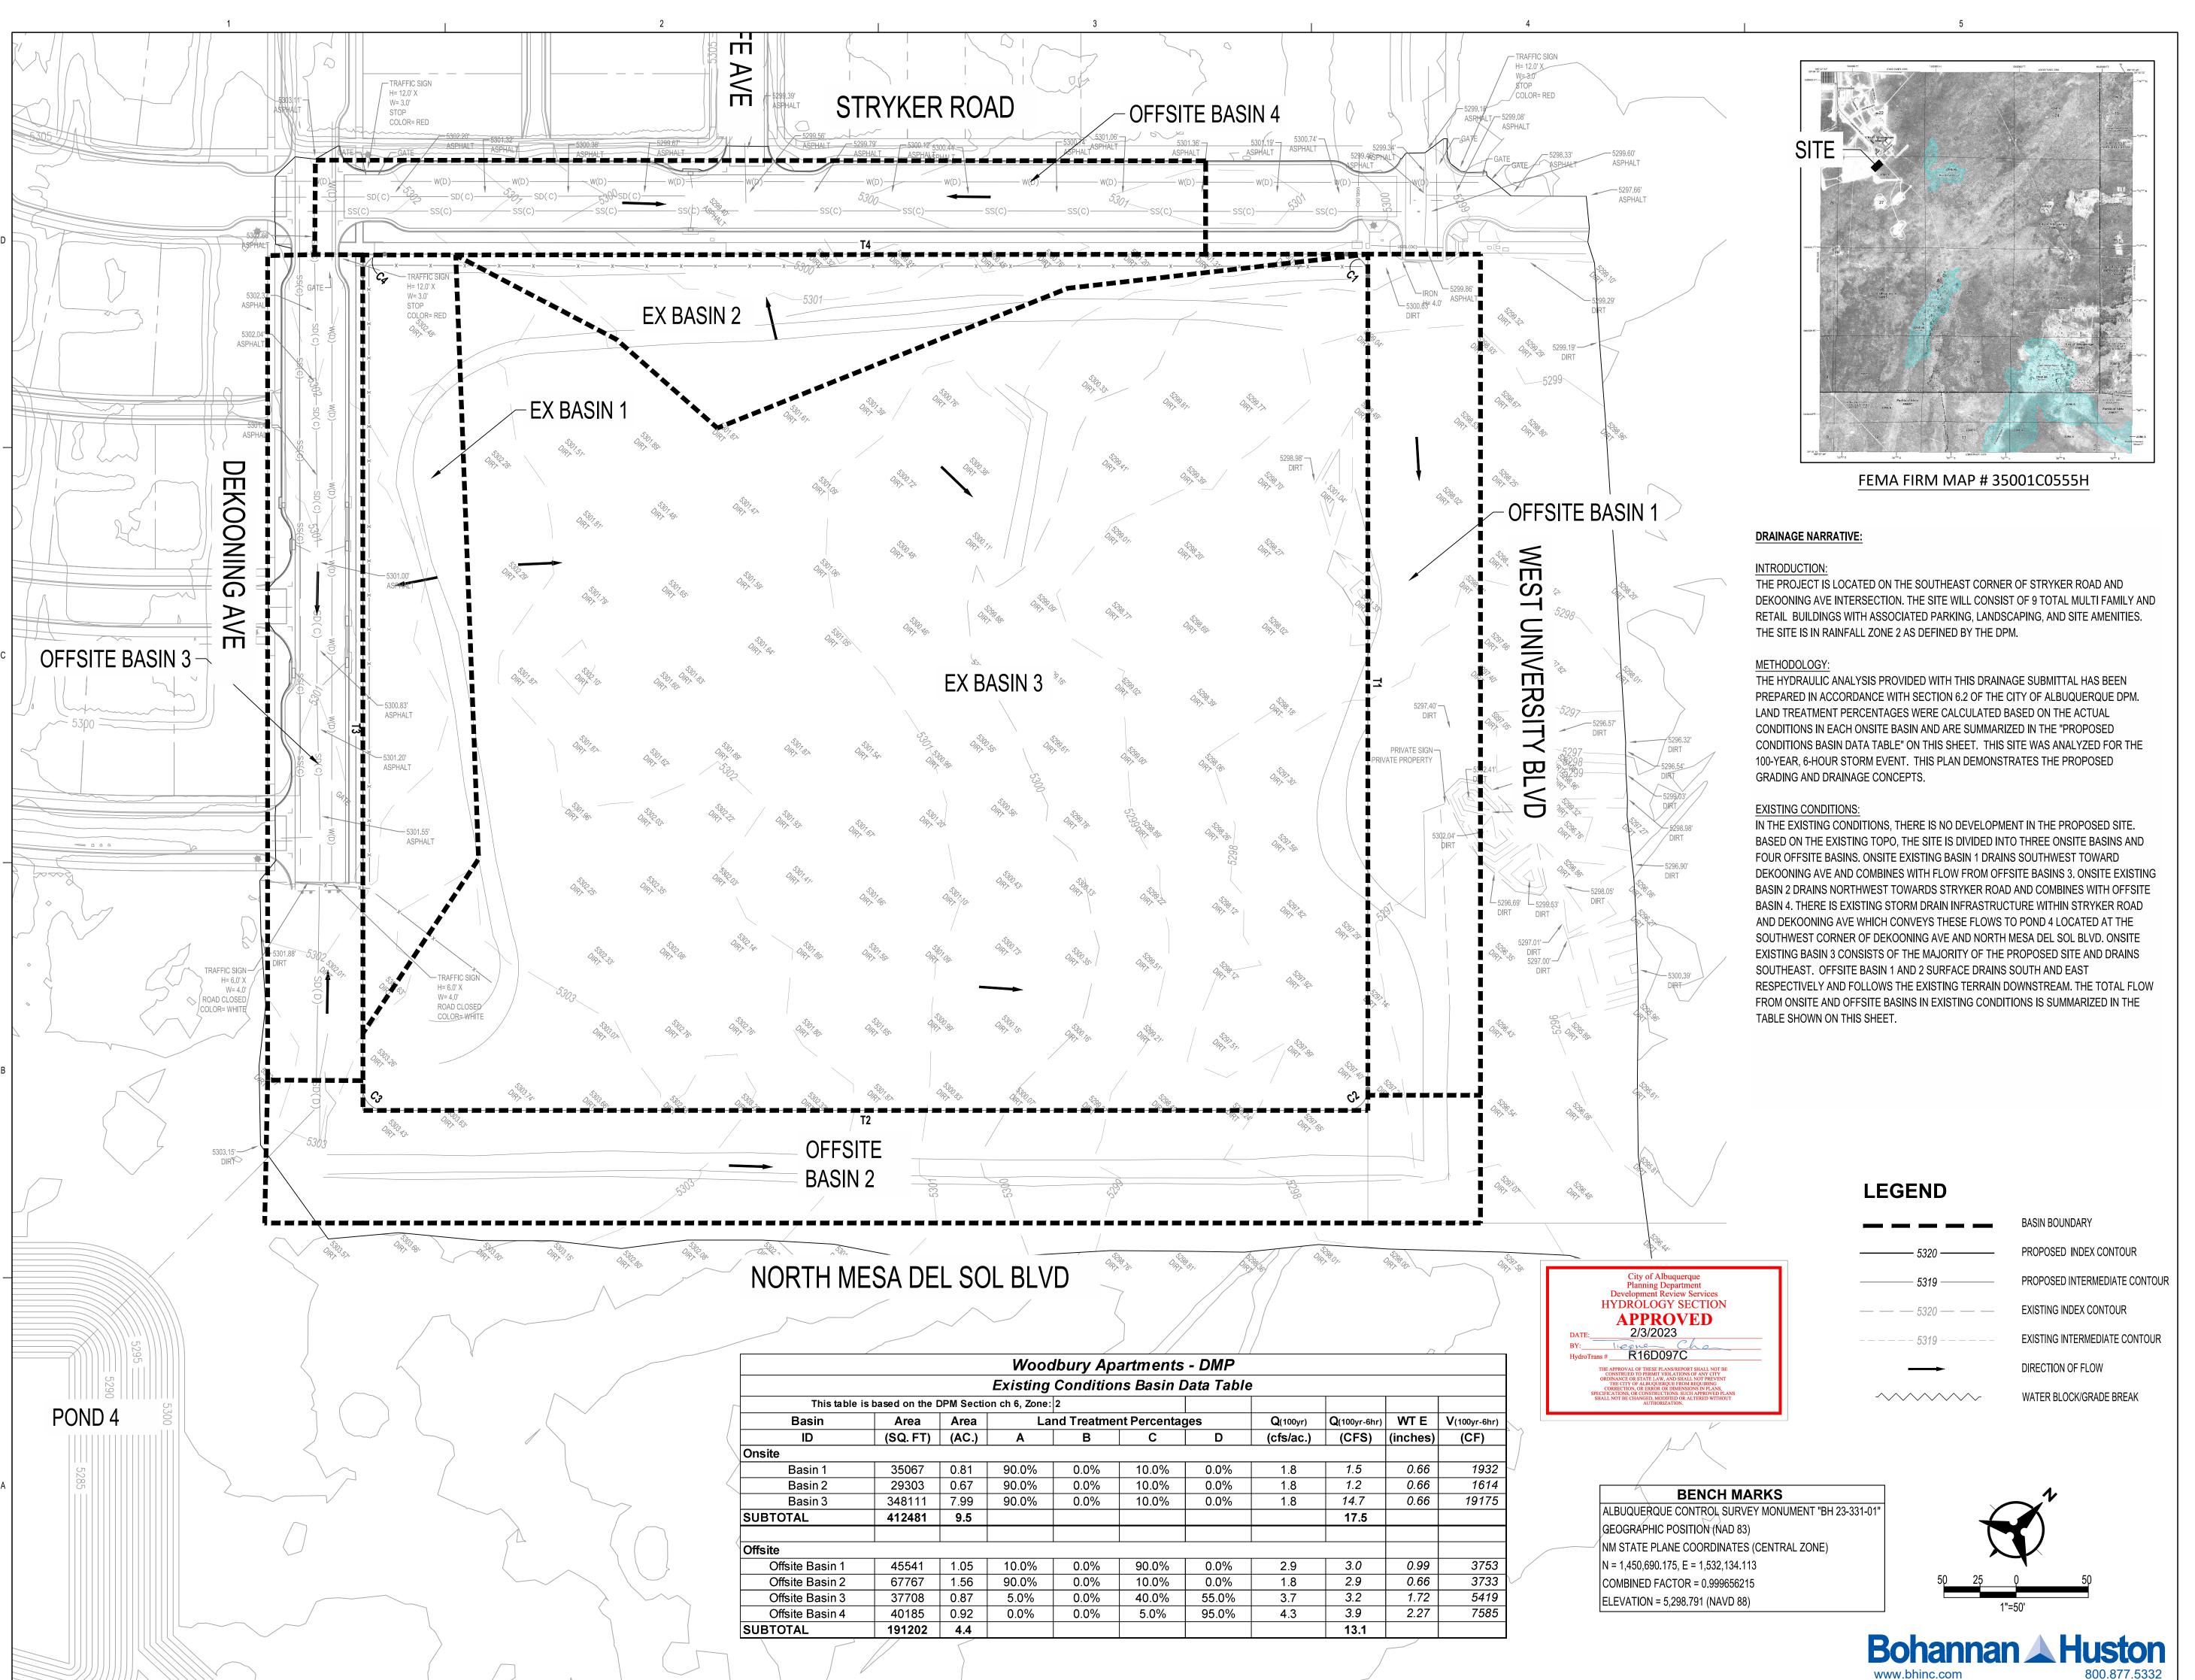

P:\20230331\CDP\Plans\General\20230331_ExistingDrainageExhibit.dwg

Architecture in Progress

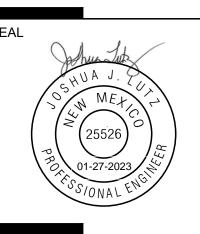

PROJECT

(Tract A) UNIVERSI SE ALBUQUERQUE, SOL **MESA DEL**

ARC REVISIONS

DRAWN BY

REVIEWED BY


01/20/2023 DATE PROJECT NO. 22-0148

DRAWING NAME CONCEPTUAL

EXISTING DRAINAGE EXHIBIT

SHEET NO.

C800

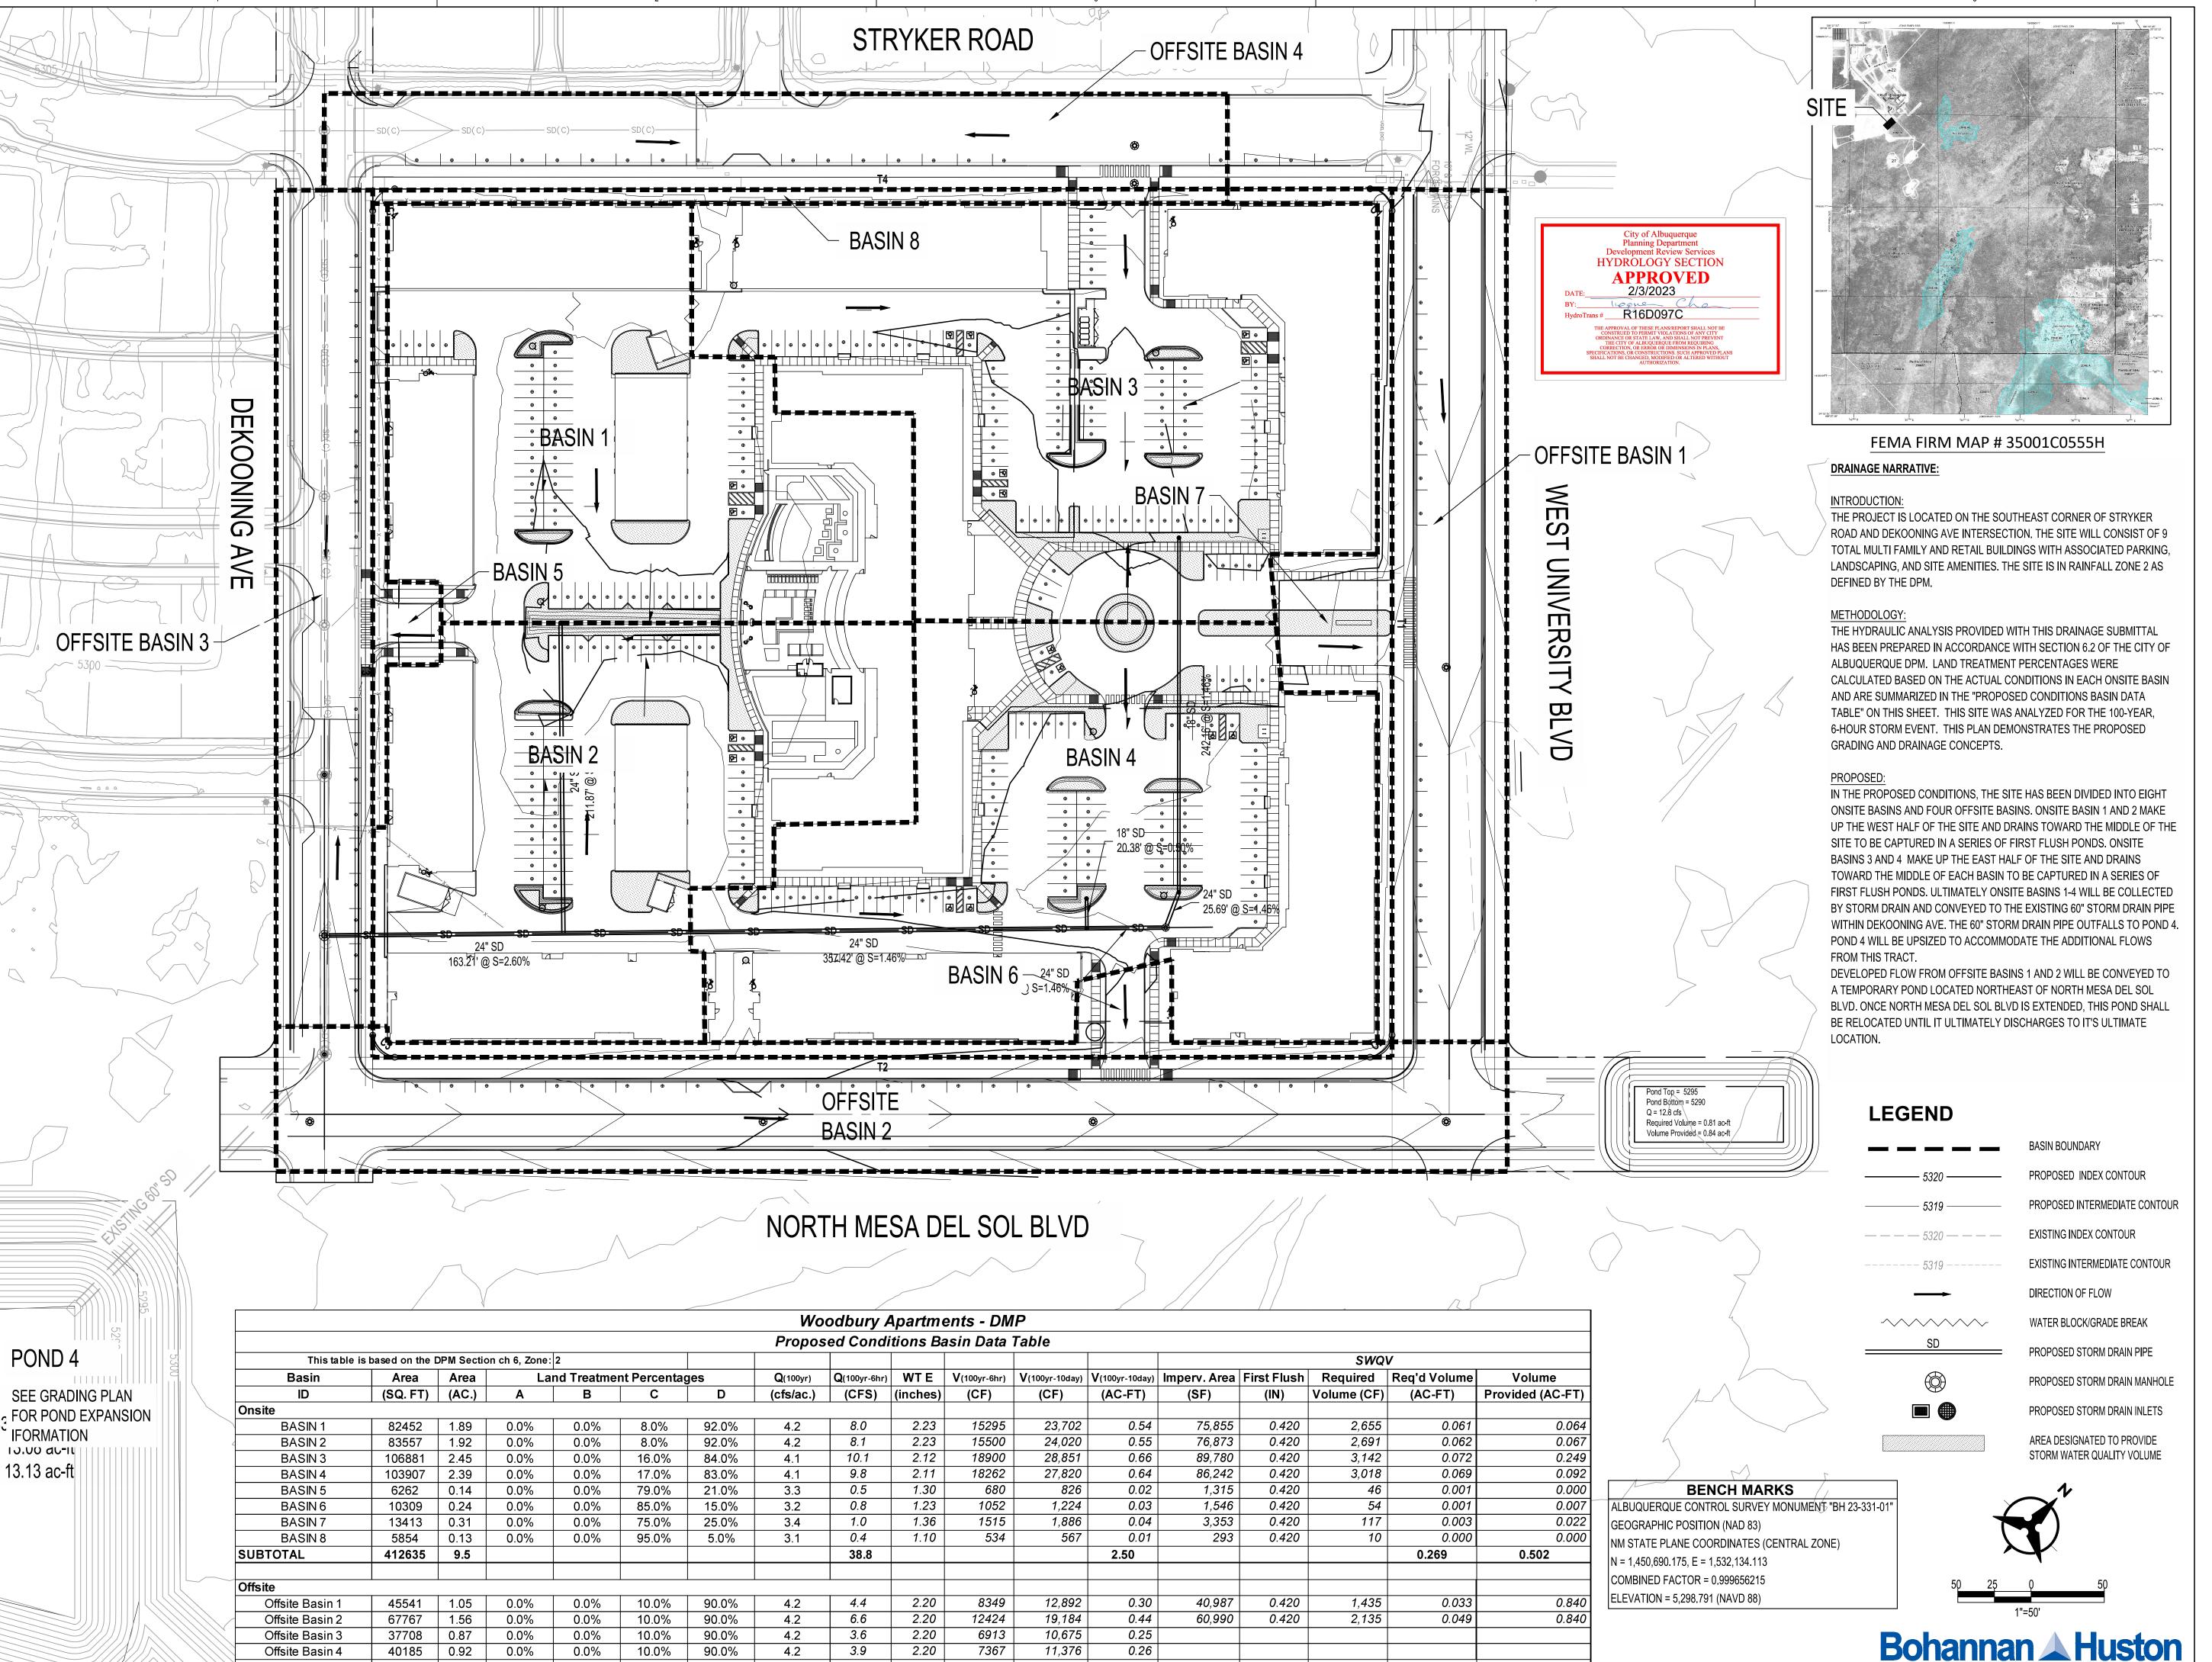

4.2

40185 | 0.92 | 0.0%

191202 4.4

Offsite Basin 4

SUBTOTAL

P:\20230331\CDP\Plans\General\20230331_ProposedDrainageExhibit.dwg

0.0%

10.0%

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3.9

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2.20

7367

11,376

0.26

1.24

Architecture in Progress



PROJECT

(Tract A) UNIVERSI SE ALBUQUERQUE SOL DEL

ARC

REVISIONS

DRAWN BY

REVIEWED BY

DATE 01/20/2023 PROJECT NO. 22-0148

DRAWING NAME

CONCEPTUAL PROPOSED DRAINAGE **EXHIBIT**

SHEET NO.

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C801