
CITY OF ALBUQUERQUE

Planning Department Alan Varela, Director

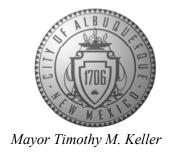

November 12, 2024

David Hickman, RA Jeebs & Zuzu, LLC 5924 Anaheim Ave NE, Ste A Albuquerque, NM 87113

Re: Encanto Building B

2500 Bobby Foster SE

Request for Certificate of Occupancy

Transportation Development Final Inspection Architect's stamped dated 11-4-21 (R16-D101)

Certification dated 11-05-24

Dear Mr. Hickman;

Based upon the information provided in your submittal received 11-05-24, Transportation Development has no objection to a <u>Permanent Certificate of Occupancy</u>. This letter serves as a

"green tag" from Transportation Development for a Permanent Temporary Certificate of

PO Box 1293 Occupancy to be issued by the Building and Safety Division.

If you have any questions, please contact Ernest Armijo at (505) 924-3991or at

Albuquerque <u>earmijo@cabq.qov</u>

NM 87103 Sincerely,

www.cabq.gov Ernest Armijo, PE

Principal Engineer, Planning Dept.

Development Review Services

C: Laurie Elliot, Desiree Gonzales, Wendi Alcala, James Broomfield, Carlos Conroy



City of Albuquerque

Planning Department

Development & Building Services Division

DRAINAGE AND TRANSPORTATION INFORMATION SHEET

| Project Title: Encanto - Building B Building I | Permit # BP-2021-49123 Hydrology File # | | |
|---|---|--|--|
| DRB# SI-2021-0057; PR-2020-004138 | EPC# | | |
| Legal Description: Mesa del Sol Innovation Park | City Address OR Parcel 2500 Eastman Crossing Building E | | |
| | • | | |
| Applicant/Agent: Jeebs & Zuzu, LLC | Contact: Dave Hickman | | |
| Address: 5924 Anaheim Ave., NE Ste A; Albuquerque, NM 87113 | Phone: 505-797-1318 | | |
| Email: dave@jeebsandzuzu.com | _ | | |
| Applicant/Owner: Encanto QOZB, LLC | Contact: Clayton Damron | | |
| Address: 3021 Citrus Circle, Suite 130, Walnut Creek, CA 94598 | Phone: 435-571-0404 | | |
| Email: cdamron@cruachancapital.com | | | |
| DEPARTMENT: TRANSPORTATION For the check all that apply: | HYDROLOGY/DRAINAGE | | |
| TYPE OF SUBMITTAL: | OF APPROVAL/ACCEPTANCE SOUGHT: | | |
| ✓ENGINEER/ARCHITECT CERTIFICATION | BUILDING PERMIT APPROVAL | | |
| PAD CERTIFICATION | ✓ CERTIFICATE OF OCCUPANCY | | |
| CONCEPTUAL G&D PLAN | CONCEPTUAL TCL DRB APPROVAL | | |
| GRADING PLAN | PRELIMINARY PLAT APPROVAL | | |
| DRAINAGE REPORT | SITE PLAN FOR SUB'D APPROVAL | | |
| DRAINAGE MASTER PLAN | SITE PLAN FOR BLDG PERMIT APPROVAL | | |
| FLOOD PLAN DEVELOPMENT PERMIT APP. | FINAL PLAT APPROVAL | | |
| ELEVATION CERTIFICATE | SIA/RELEASE OF FINANCIAL GUARANTEE | | |
| CLOMR/LOMR | FOUNDATION PERMIT APPROVAL | | |
| TRAFFIC CIRCULATION LAYOUT (TCL) | GRADING PERMIT APPROVAL | | |
| ADMINISTRATIVE | SO-19 APPROVAL | | |
| TRAFFIC CIRCULATION LAYOUT FOR DRB APPROVAL | PAVING PERMIT APPROVAL | | |
| TRAFFIC IMPACT STUDY (TIS) | GRADING PAD CERTIFICATION | | |
| STREET LIGHT LAYOUT | WORK ORDER APPROVAL | | |
| OTHER (SPECIFY) | CLOMR/LOMR FLOOD PLAN DEVELOPMENT PERMIT | | |
| PRE-DESIGN MEETING? | OTHER (SPECIFY) | | |
| | | | |

DATE SUBMITTED: 11/5/24

November 5, 2024

Ernest Armijo, PE
Transportation Development
Planning Department
City of Albuquerque
P.O. Box 1293
Albuquerque, NM 87103

RE: Request for Certificate of Occupancy – DRB for TCL

Project No: PR-2020-004138; SI-2021-00574

BP-2021-49123

Dear Mr. Armijo,

Please find a completed request for final inspection of Encanto at Mesa Del Sol, Building B in request of Certificate of Occupancy for that building.

The construction of Building B is now complete and ready for inspection.

I have attached with this letter the certification, the Approved DRB Site Plan, and the Drainage and Transportation Information Sheet.

Please contact me if you have any questions or concerns. We certainly appreciate your help!

J. David Hickman,

Architect

I, J. DAVID HICKMAN, A REGISTERED ARCHITECT IN THE STATE OF NEW MEXICO, OF THE FIRM JEEBS & ZUZU, LLC., HEREBY CERTIFY THAT THIS PROJECT, ENCANTO AT MESA DEL SOL, 2500 EASTMAN CROSSING – BUILDING B, IS IN SUBSTANTIAL COMPLIANCE WITH AND IN ACCORDANCE WITH THE DESIGN INTENT OF THE AMENDED DRB, AA OR TCL APPROVED PLAN DATED 11/4/21. I FURTHER CERTIFY THAT I HAVE PERSONALLY VISITED THE PROJECT SITE ON OCTOBER 29, 2024 AND HAVE DETERMINED BY VISUAL INSPECTION THAT THE SURVEY DATA PROVIDED IS REPRESENTATIVE OF ACTUAL SITE CONDITIONS AND IS TRUE AND CORRECT TO THE BEST OF MY KNOWLEDGE AND BELIEF. THIS CERTIFICATION IS SUBMITTED IN SUPPORT OF A REQUEST FOR CERTIFICATION OF OCCUPANCY.

OF NEW METO

J. DAVID


HICKMAN NO. 3340

THO TERED ARCHI

Architect

11/5/24

Date:

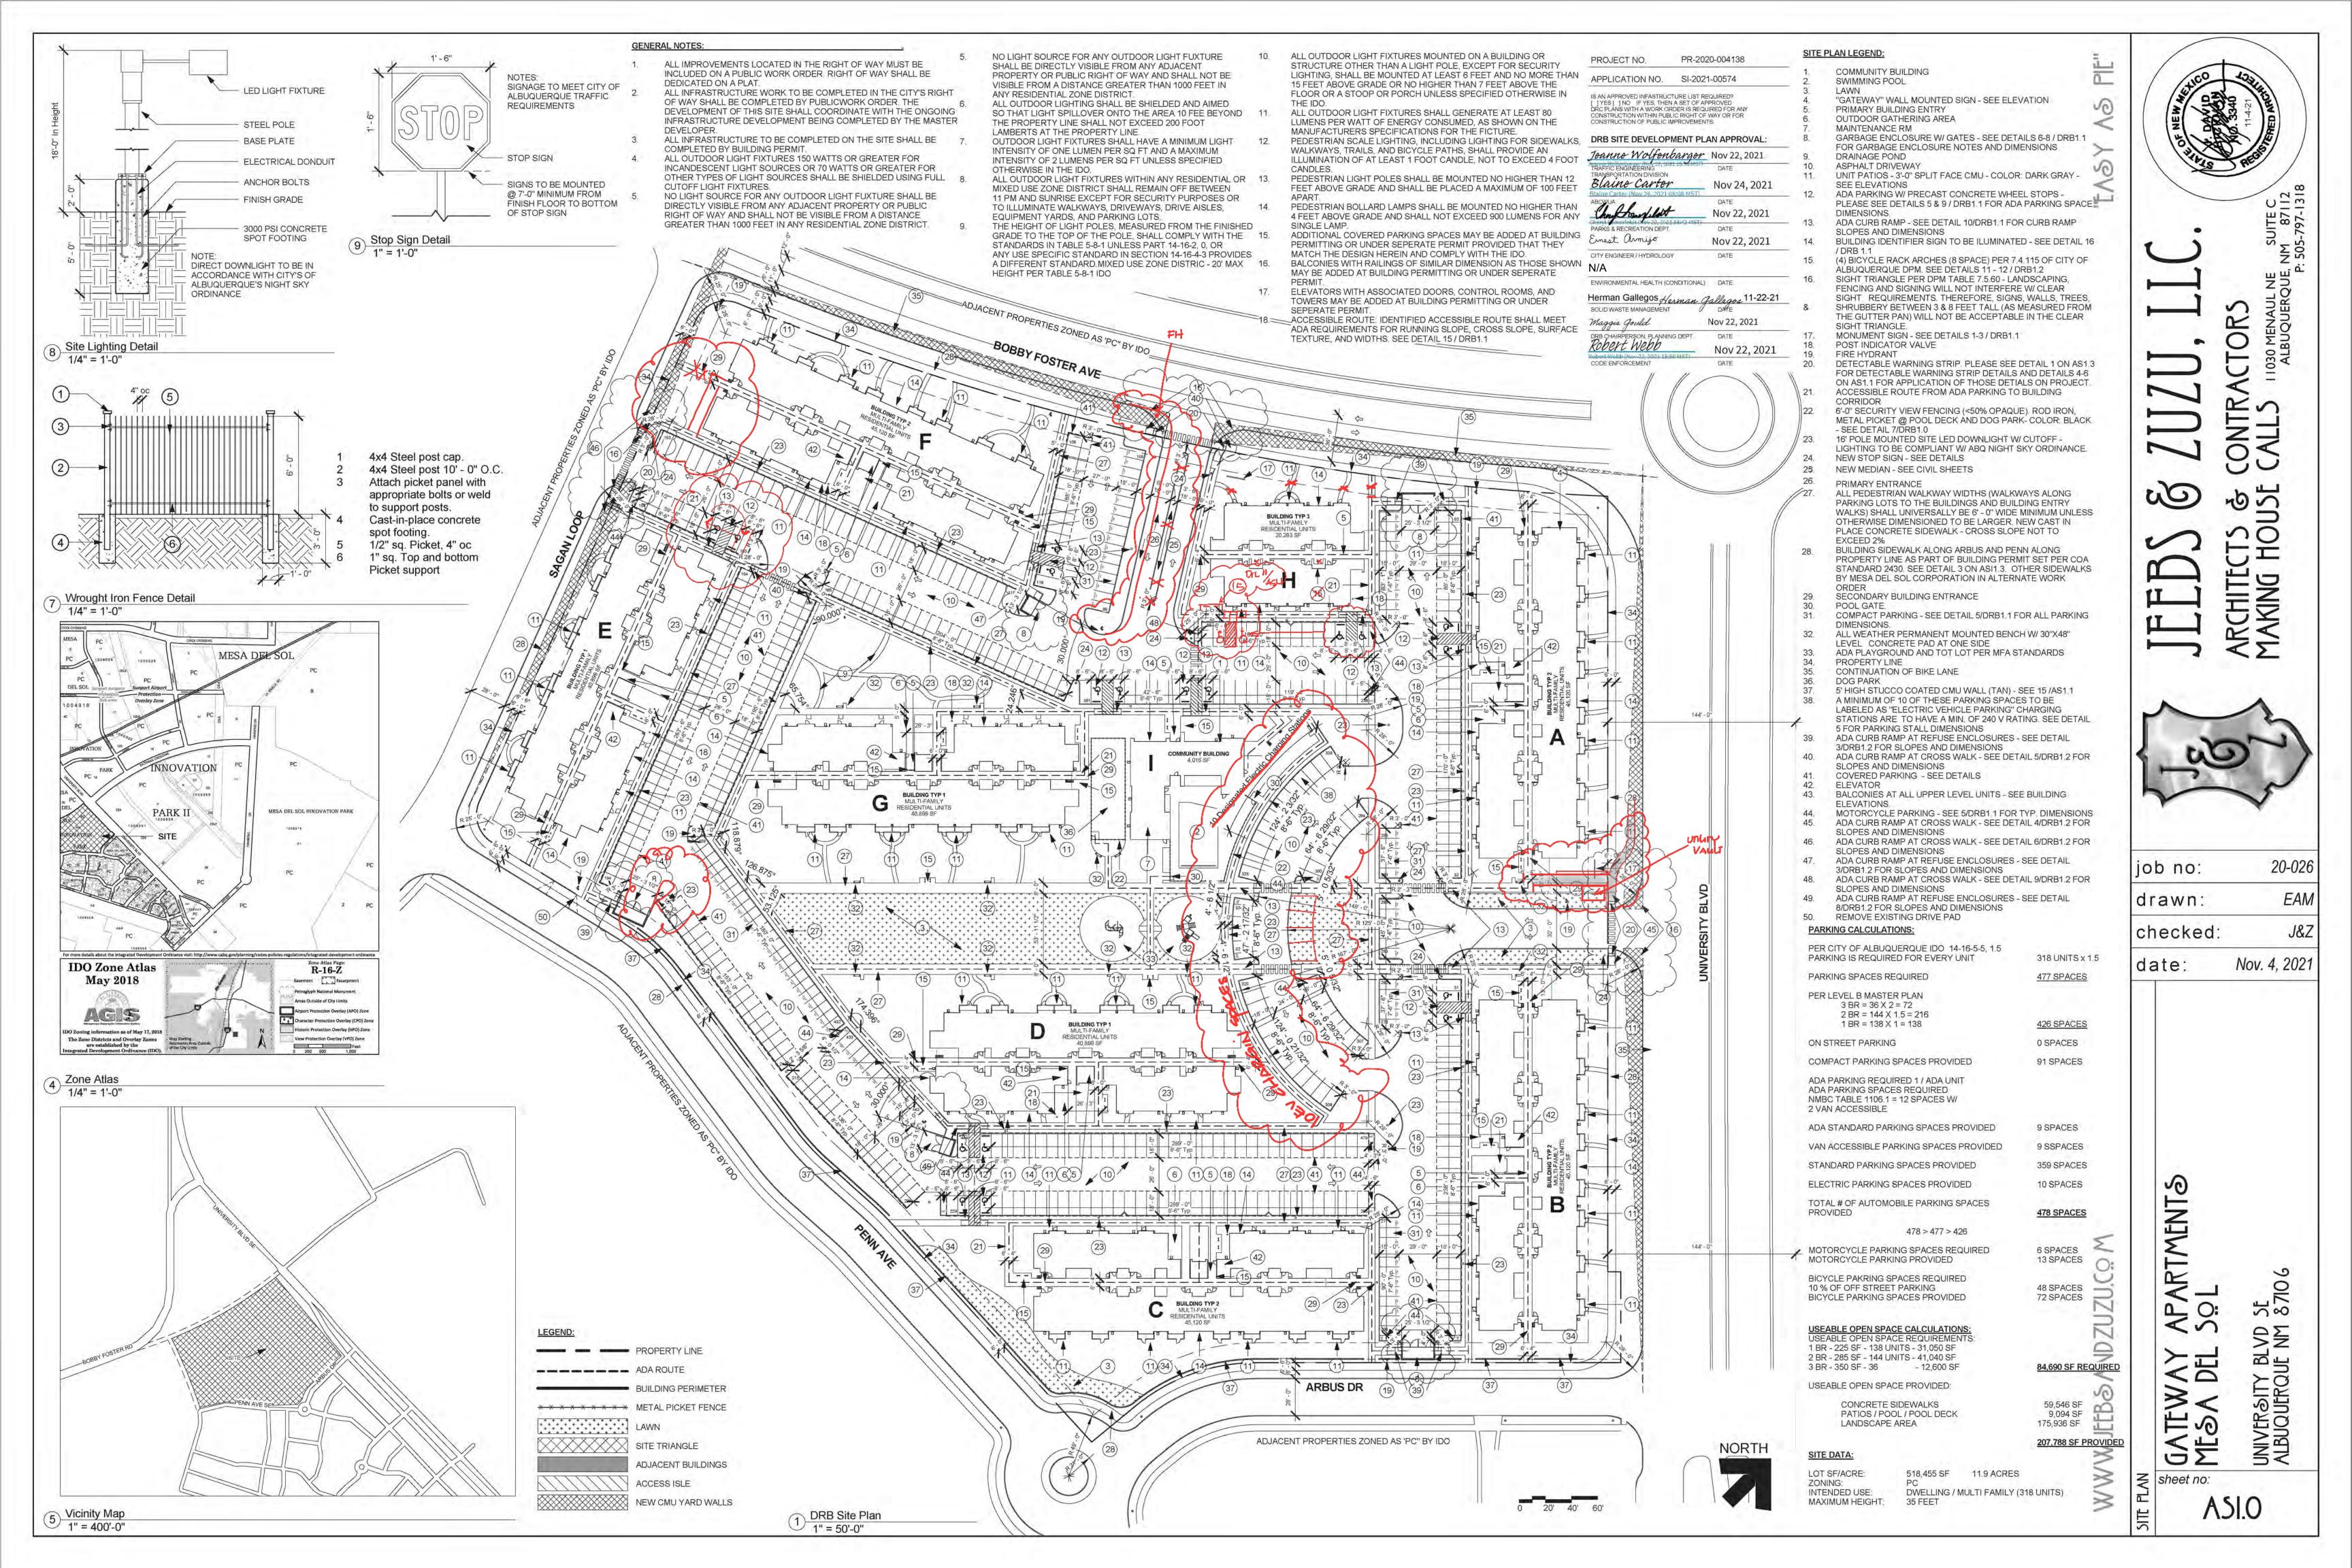


| PARKING REQUIREMENTS PER PHASE: | | | | |
|---------------------------------|--|--|---|--|
| # OF UNITS | # OF SPACES REQUIRED | SPACES PROVIDED | | |
| 42 | + 63 | 89 | | |
| 24 | 99 | 114 | | |
| 42 | 135 | 179 | | |
| 42 | 198 | 205 | | |
| 42 | 261 | 269 | | |
| 0 | 0 | 269 | | |
| 42 | 324 | 358 | | |
| 42 | 387 | 431 | | |
| 42 | 450 | 479 | | |
| | # OF UNITS 42 24 42 42 42 42 42 42 42 | # OF UNITS # OF SPACES REQUIRED 42 + 63 24 99 42 135 42 198 42 261 0 0 42 324 42 387 | # OF UNITS # OF SPACES REQUIRED SPACES PROVIDED 42 + 63 89 24 99 114 42 135 179 42 198 205 42 261 269 0 0 269 42 324 358 42 387 431 | |

| BUILDING | AREAS |
|----------|-----------|
| A | 40,686 SF |
| В | 40,686 SF |
| С | 40,686 SF |
| D | 36,435 SF |
| E | 36,435 SF |
| F | 40,686 SF |
| G | 36,435 SF |
| Н | 17,880 SF |
| 1 | 3,989 SF |
| J | 3,474 SF |

| PHASE | AREAS |
|---------|------------|
| 1 (a&h) | 27,671 SF |
| 2 (f) | 17,984 SF |
| 3 (g) | 21,468 SF |
| 4 (e) | 11,010 SF |
| 5 (i&j) | 14,826 SF |
| 6 (d) | 17,727 SF |
| 7 (c) | 21,295 SF |
| 8 (b) | 17,137 SF |
| TOTAL | 149,118 SF |

LANDSCAPE AREAS:

| FILAGE | ANLAS |
|---------|------------|
| 1 (a&h) | 27,671 SF |
| 2 (f) | 17,984 SF |
| 3 (g) | 21,468 SF |
| 4 (e) | 11,010 SF |
| 5 (i&j) | 14,826 SF |
| 6 (d) | 17,727 SF |
| 7 (c) | 21,295 SF |
| 8 (b) | 17,137 SF |
| TOTAL | 149,118 SF |

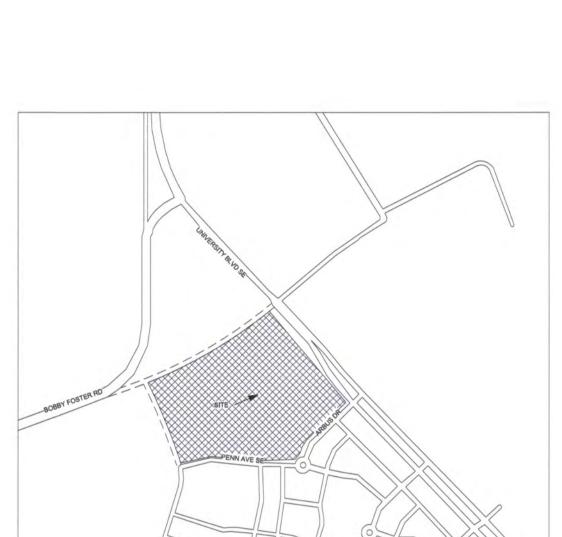

1 Zone Atlas 1/4" = 1'-0"

2 Vicinity Map 1" = 400'-0"

⇒ PHASE 1 PHASE 5 PHASE 8 PHASE 7 ARBUS DR

PARKING CALCULATIONS: PER CITY OF ALBUQUERQUE IDO 14-16-5-5, 1.5 PARKING IS REQUIRED FOR EVERY UNIT 318 UNITS x 1.5 PARKING SPACES REQUIRED 477 SPACES TOTAL # OF AUTOMOBILE PARKING SPACES 481 SPACES OFF STREET STANDARD PARKING ON STREET PARKING COMPACT PARKING SPACES PROVIDED EV PARKING 384 SPACES 0 SPACES 69 SPACES 10 SPACES ADA PARKING REQUIRED 1 / ADA UNIT ADA PARKING SPACES REQUIRED NMBC TABLE 1106.1 = 12 SPACES W/ 2 VAN ACCESSIBLE 17 SPACES ADA PARKING SPACES PROVIDED 18 SPACES VAN ACCESSIBLE PARKING SPACES PROVIDED 9 SSPACES COVERED PARKING SPACES PROVIDED 0 SPACES MOTORCYCLE PARKING SPACES REQUIRED MOTORCYCLE PARKING PROVIDED 12 SPACES BICYCLE PARKING SPACES REQUIRED 10% OF OFF STREET PARKING BICYCLE PARKING SPACES PROVIDED TOTAL # OF AUTOMOBILE PARKING SPACES PROVIDED 48 SPACES 72 SPACES 479 SPACES

PR-2020-004138

No design change since 8/15/23 Minor Amendment.

Updated phasing consistent with original 9/22/21 (signed 11/22/21) DRB approval.

USEABLE OPEN SPACE CALCULATIONS: USEABLE OPEN SPACE REQUIREMENTS: 1 BR - 225 SF - 138 UNITS - 31,050 SF 2 BR - 285 SF - 144 UNITS - 41,040 SF 3 BR - 350 SF - 36 - 12,600 SF USEABLE OPEN SPACE PROVIDED: CONCRETE SIDEWALKS PATIOS / POOL / POOL DECK LANDSCAPE AREA

SITE DATA: LOT SF/ACRE: ZONING: INTENDED USE: MAXIMUM HEIGHT:

510,919.60 SF 11.729 ACRES DWELLING / MULTI FAMILY (318 UNITS) 35 FEET

84,690 SF REQUIRED

248,186 SF PROVIDED

79,560 SF 19,508 SF 149,118 SF

WWW.JEEBSANDZUZU.Co

CANTO SA DEL

(M)

job no:

drawn

checked:

20-026

Author

Checker

4/24/24

SE 8710

sheet no: