CITY OF ALBUQUERQUE

Planning Department Alan Varela, Director



Mayor Timothy M. Keller

December 26, 2023

Joshua Lutz, P.E. Bohannan Huston Inc. 7500 Jefferson St. NE Courtyard I Albuquerque, NM 87109

RE: Golden Eagle, 99999 University Blvd. UPC: 101605026829920101 A portion of Tract 18 Artiste, Mesa del Sol Conceptual Grading and Drainage Plan Engineer's Stamp Date: 12/15/2023 Hydrology File: S17D001

Dear Mr. Lutz:

Based upon the information provided in your submittal received 12/20/2023, the Conceptual Grading & Drainage Plan is not approved for action by the DRB/DHO on Site Plan for Building Permit. The following comments need to be addressed for approval of the above referenced project:

 Please insert vicinity map and FEMA FIRM map.

- Albuquerque 2. Provide the Benchmark information (location, description and elevation) for the survey contour information provided.
- NM 87103
 Please verify the 100yr-24hr and 100yr-10day ponding volume calculations for basins 3, 4, 5 and 6 in the basin data table on sheet 7 (Drawing No. C-00-S-10-05). I applied the equations and tables from section 6-2(A) in the DMP, I got the same weighted E values, but my 100yr-24hr and 100yr-10day volume numbers are slightly different than Jocobs.

	Basin ID	Area (AC)	V 100yr, 24hr (CF)	Jacobs	V 100-yr, 10-day (CF)	Jacobs	V 100-yr, 10-d (AC-FT)	Jacobs
ĺ	1A	11.7	72681	72968	90180	96252	2.1	2.2
	1B	19.9	141187	141317	182601	196257	4.2	4.5
	2	7.8	52381	52570	66651	71553	1.5	1.6
	3	40	331521	37397	446414	189723	10.2	4.4
	4	34.9	290937	32981	392299	167320	9.0	3.8
	5	3.8	30761	3351	41189	17001	0.9	0.4
	6	7.5	65419	7702	89123	39071	2.0	0.9
	7	6.9	52714	53086	69567	75579	1.6	1.7

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4. Add proposed SD pipe size on the plan.

If you have any questions, please contact me at 505-924-3695 or tchen@cabq.gov.

Sincerely,

Tieque Che

Tiequan Chen, P.E. Principal Engineer, Hydrology Planning Department, Development Review Services

PO Box 1293

Albuquerque

NM 87103

www.cabq.gov




City of Albuquerque


Planning Department Development & Building Services Division


DRAINAGE AND TRANSPORTATION INFORMATION SHEET (DTIS)

Project Title: Golden Eagle	Hydrology File #					
Legal Description:A portion of Tract 18 Artiste. The Golden Eag	gle tract will be platted in the near future. (See zone atlas map).					
City Address, UPC, OR Parcel: Address: 99999 Univer	rsity Blvd. UPC: 101605026829920101					
Applicant/Agent: Bohannan Huston Inc. Address: 7500 Jefferson St. NE Albuquerque, NM 87109 Email: jlutz@bhinc.com	Contact: Josh Lutz, PE Phone: (505)823-1000					
Applicant/Owner: Maxeon Address: 5700 University Blvd SE Suite 200 Email: donald.foldenauer@maxeon.com	Contact: Don Foldenaur Phone: +1 419-918-9741					
(Please note that a DFT SITE is one that needs Site Plan 4	Approval & ADMIN SITE is one that does not need it.)					
TYPE OF DEVELOPMENT: PLAT (#of lots)	RESIDENCE ADMIN SITE					
DEPARTMENT: TRANSPORTATION	HYDROLOGY/DRAINAGE					
Check all that apply under Both the Type of Submitta	l and the Type of Approval Sought:					
TYPE OF SUBMITTAL:	TYPE OF APPROVAL SOUGHT:					
ENGINEER/ARCHITECT CERTIFICATION	BUILDING PERMIT APPROVAL					
PAD CERTIFICATION	CERTIFICATE OF OCCUPANCY					
CONCEPTUAL G&D PLAN	CONCEPTUAL TCL DFT APPROVAL					
GRADING & DRAINAGE PLAN	PRELIMINARY PLAT APPROVAL					
DRAINAGE REPORT	FINAL PLAT APPROVAL					
DRAINAGE MASTER PLAN	SITE PLAN FOR BLDG PERMIT DFT					
CLOMR/LOMR TRAFFIC CIRCULATION LAYOUT (TCL) ADMINISTRATIVE	SIA/RELEASE OF FINANCIAL GUARANTEE					
TRAFFIC CIRCULATION LAYOUT FOR DFT APPROVAL	GRADING PERMIT APPROVAL					
TRAFFIC IMPACT STUDY (TIS)	SO-19 APPROVAL					
STREET LIGHT LAYOUT	PAVING PERMIT APPROVAL					
OTHER (SPECIFY)	GRADING PAD CERTIFICATION					
	WORK ORDER APPROVAL					
	CLOMR/LOMR					
	OTHER (SPECIFY)					


DATE SUBMITTED: December 15, 2023

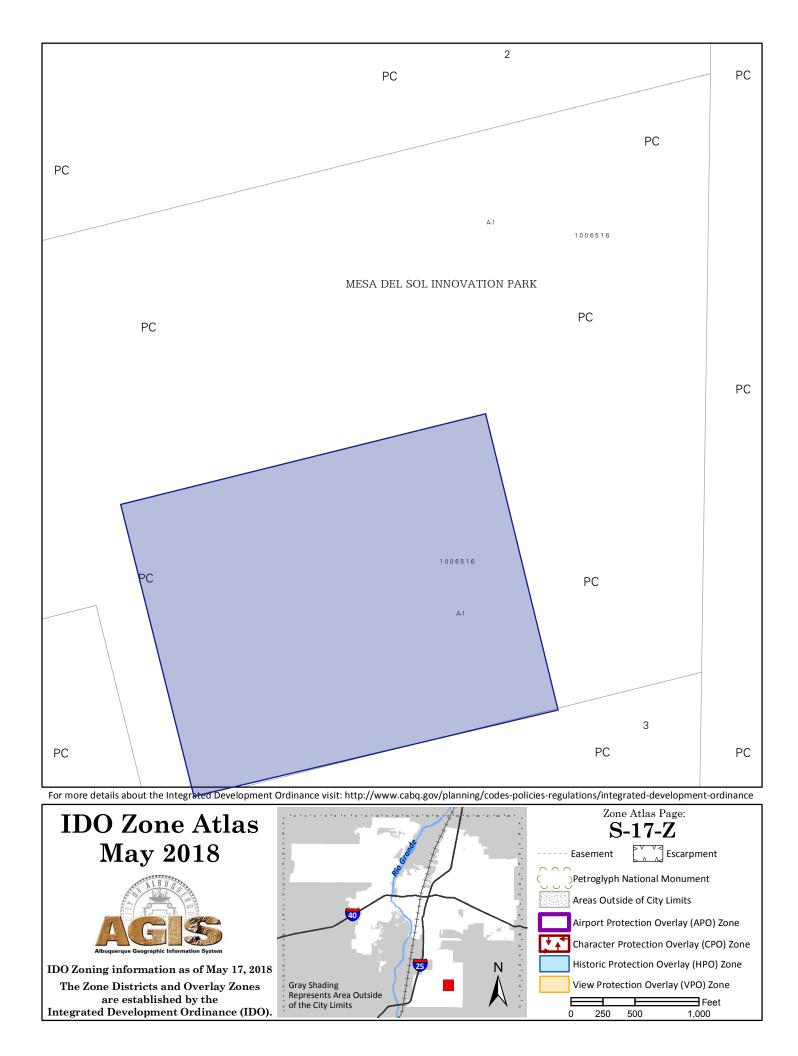


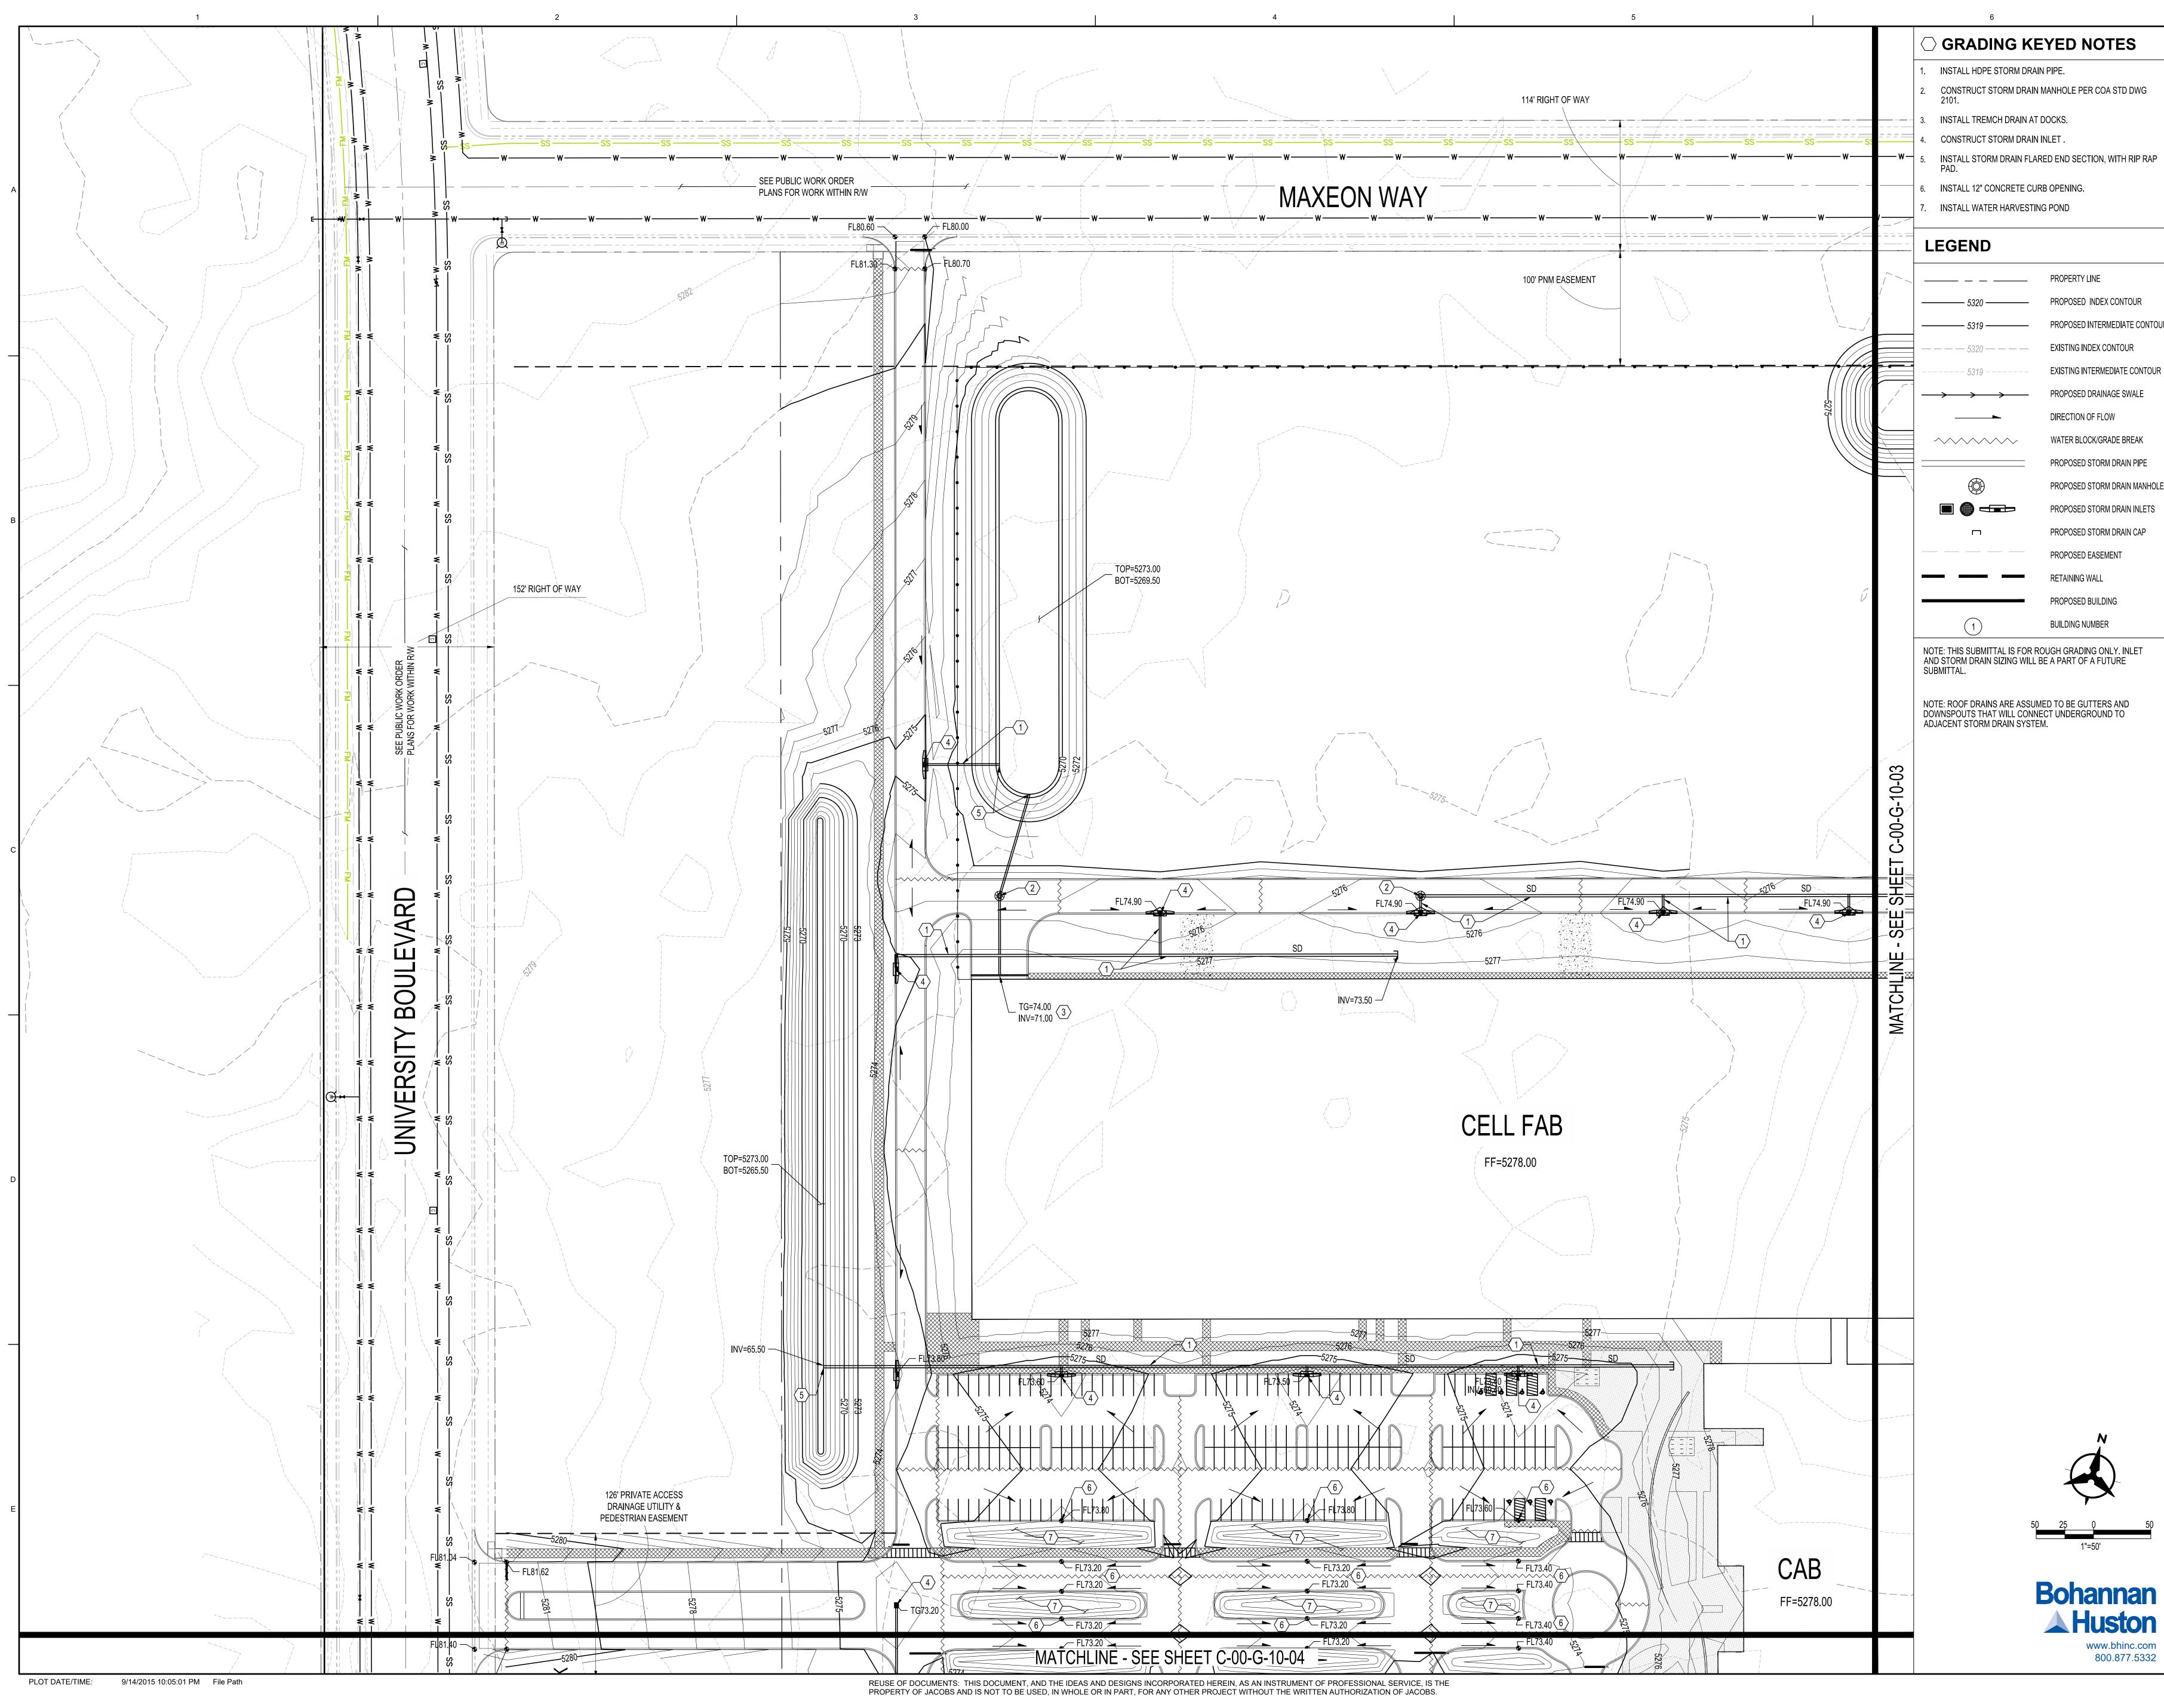

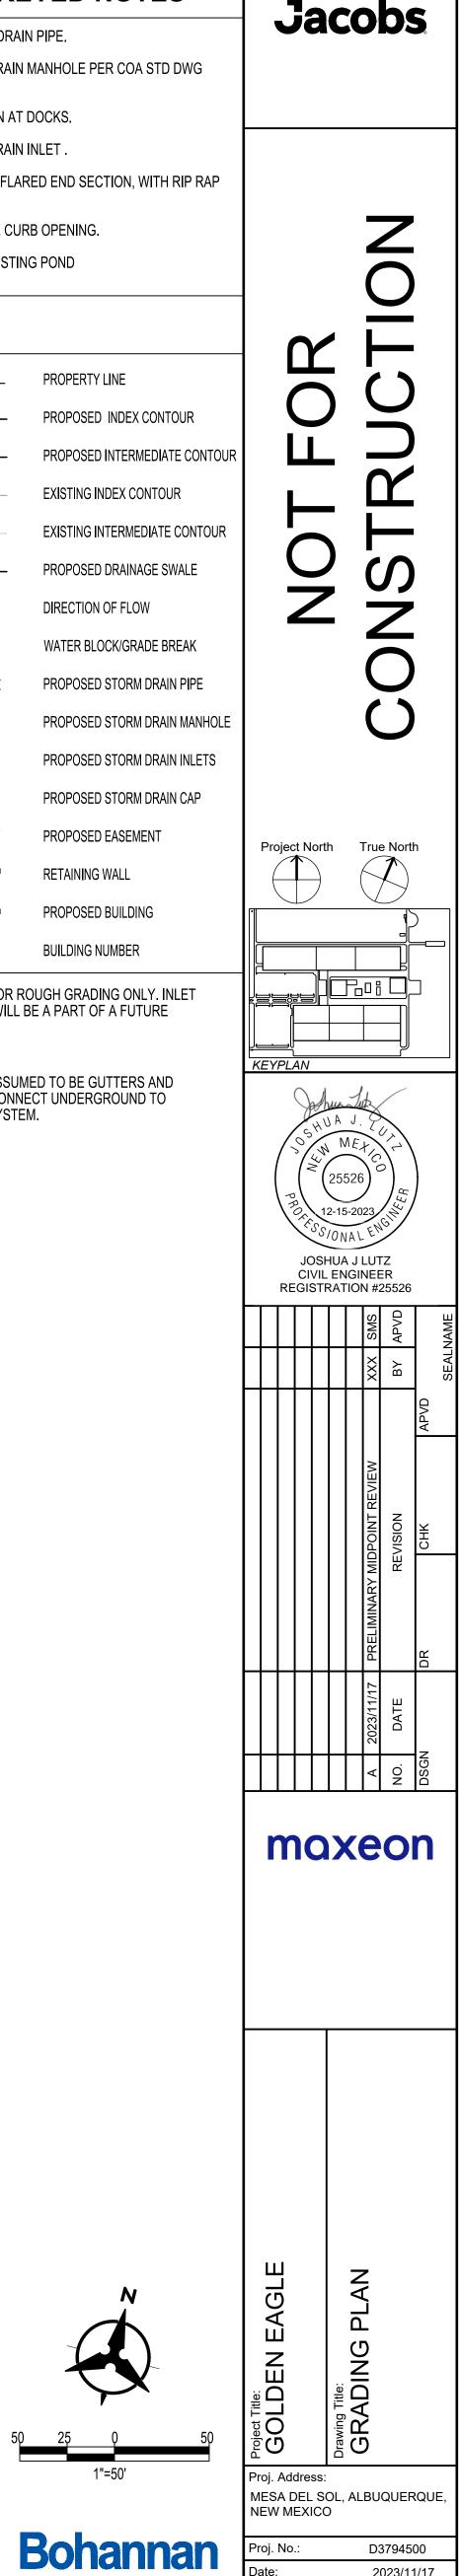



2023/11/17 1" = 50' Drawing No.: C-00-G-10-02

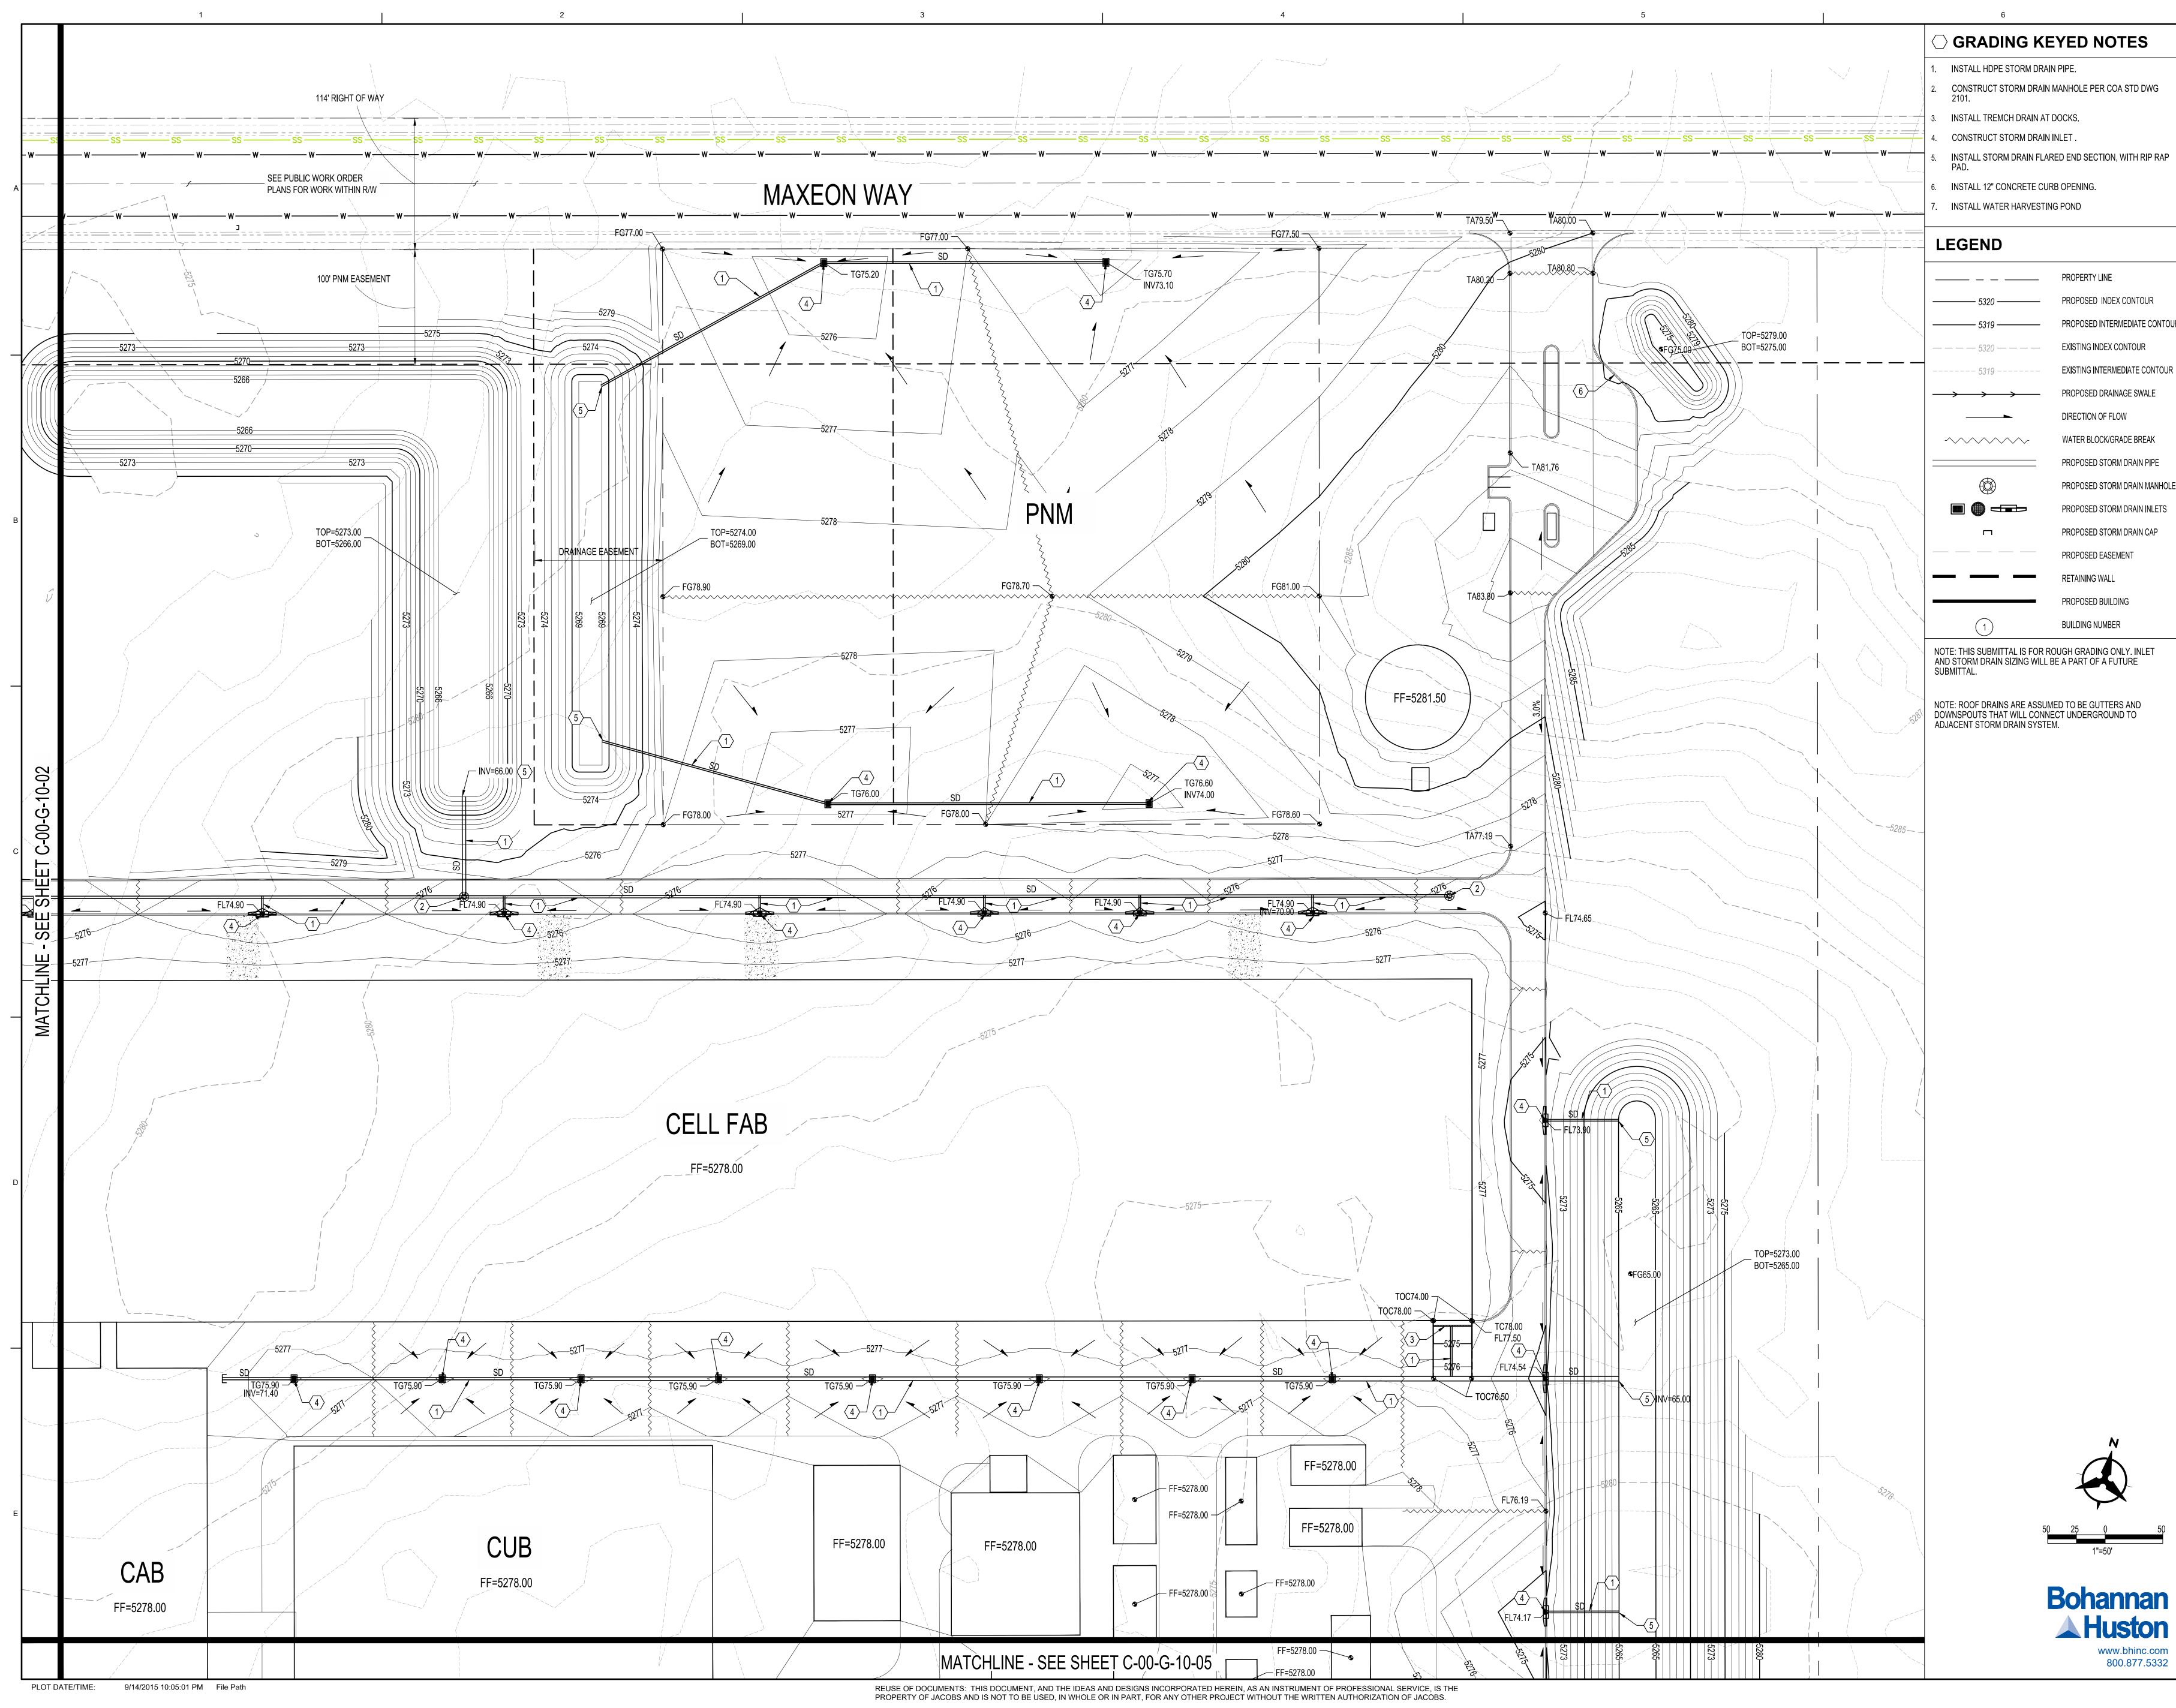

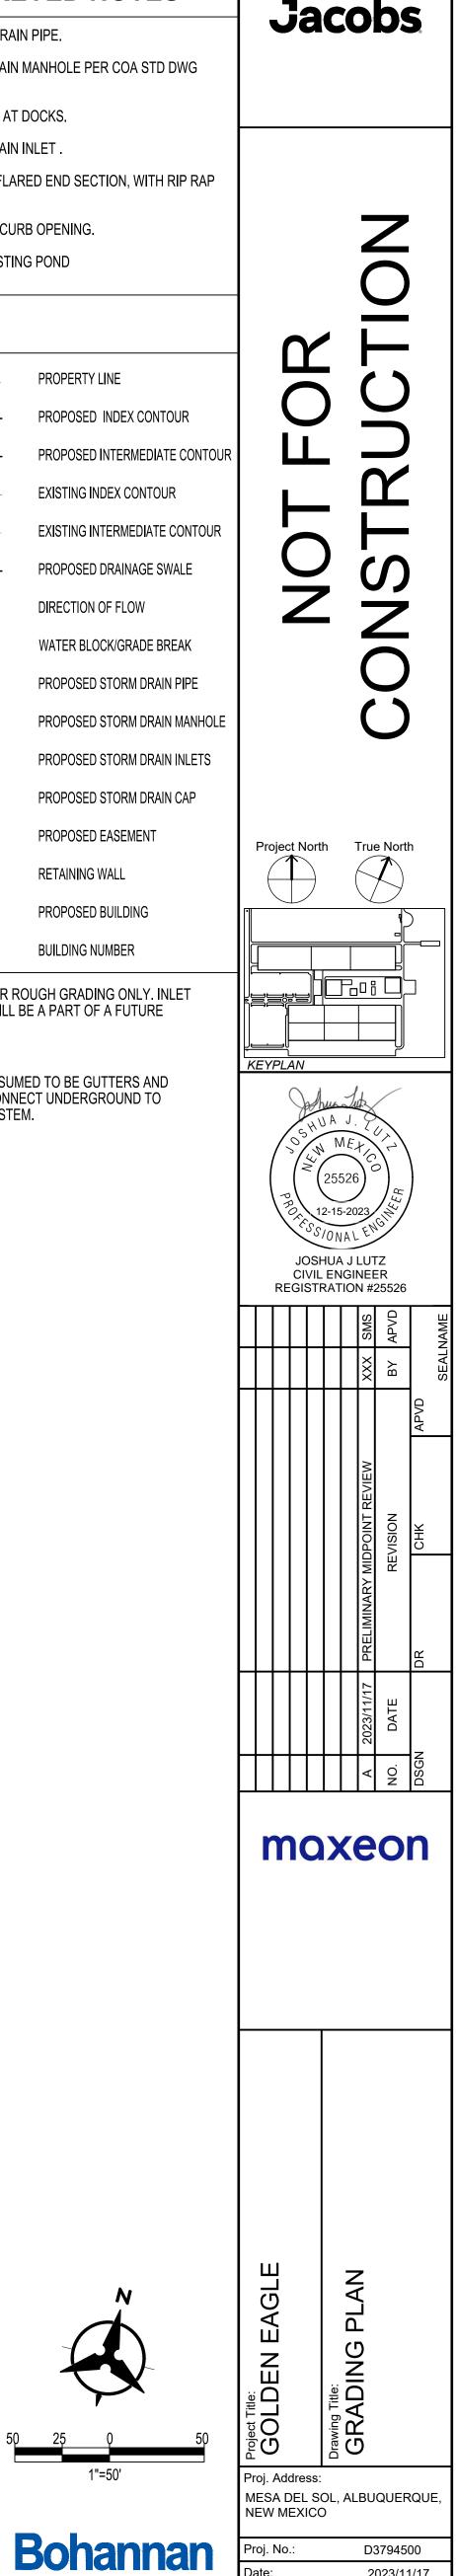



2023/11/17 1" = 50' Drawing No.: C-00-G-10-03

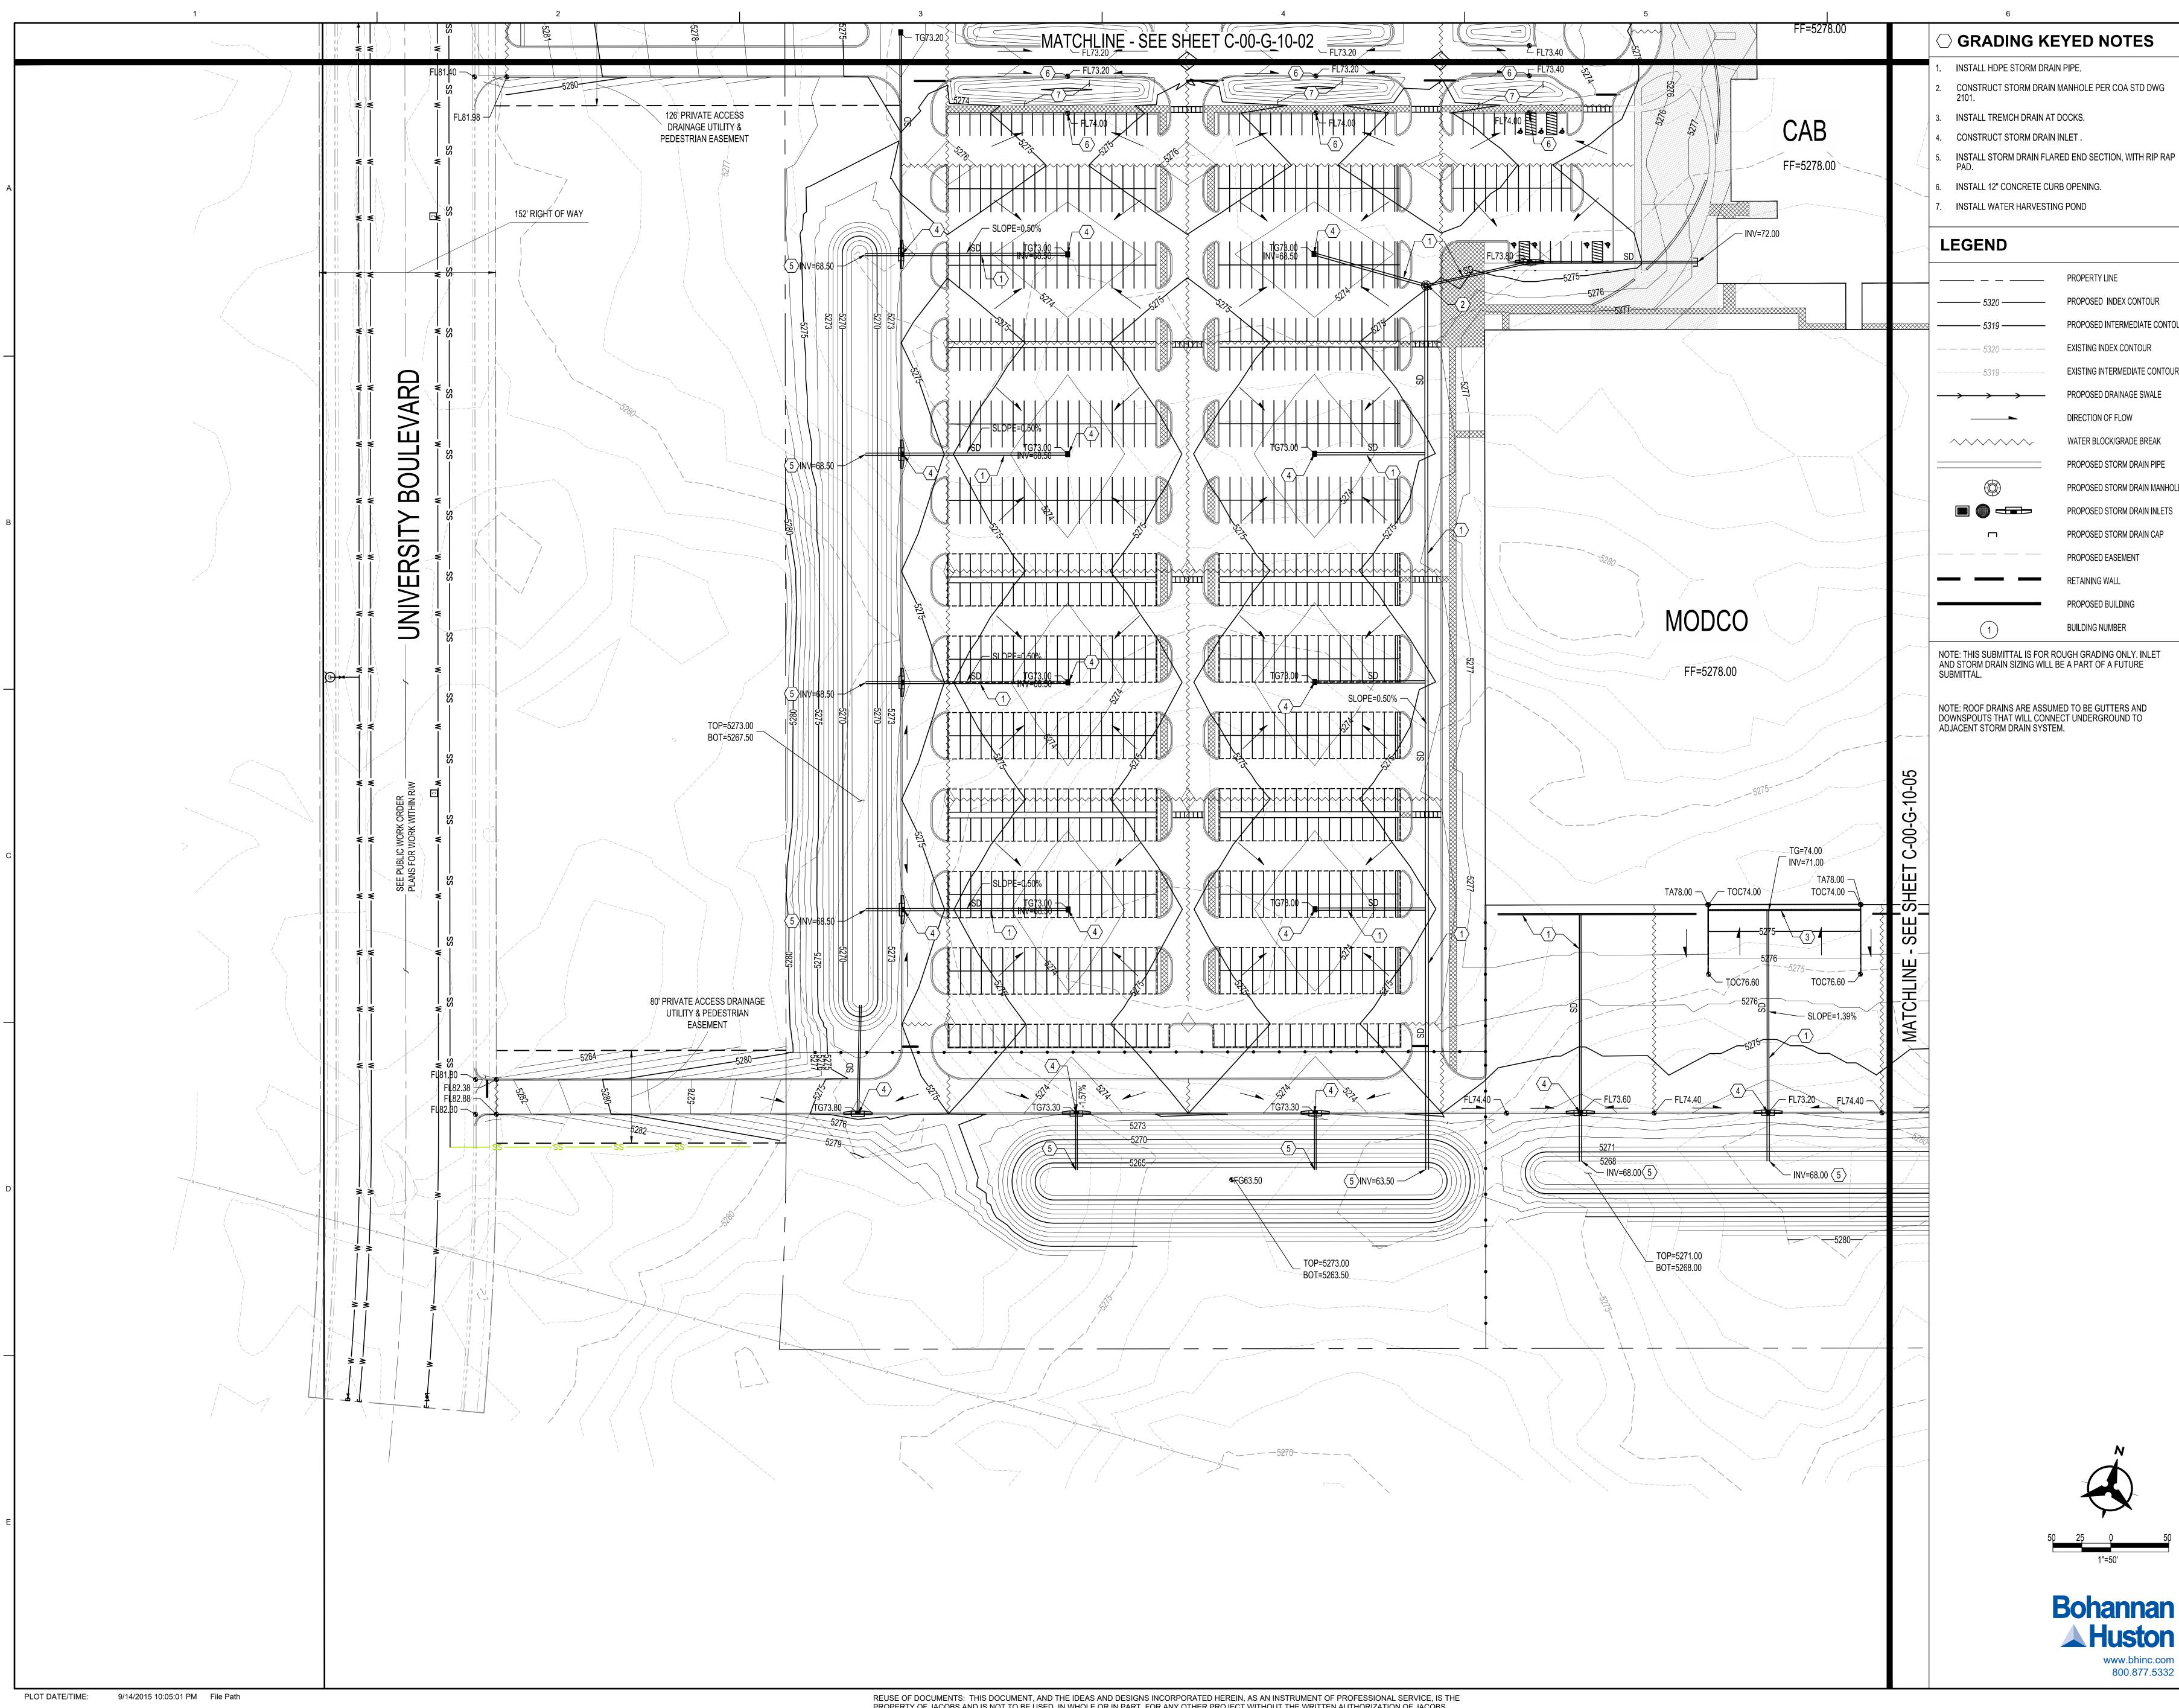

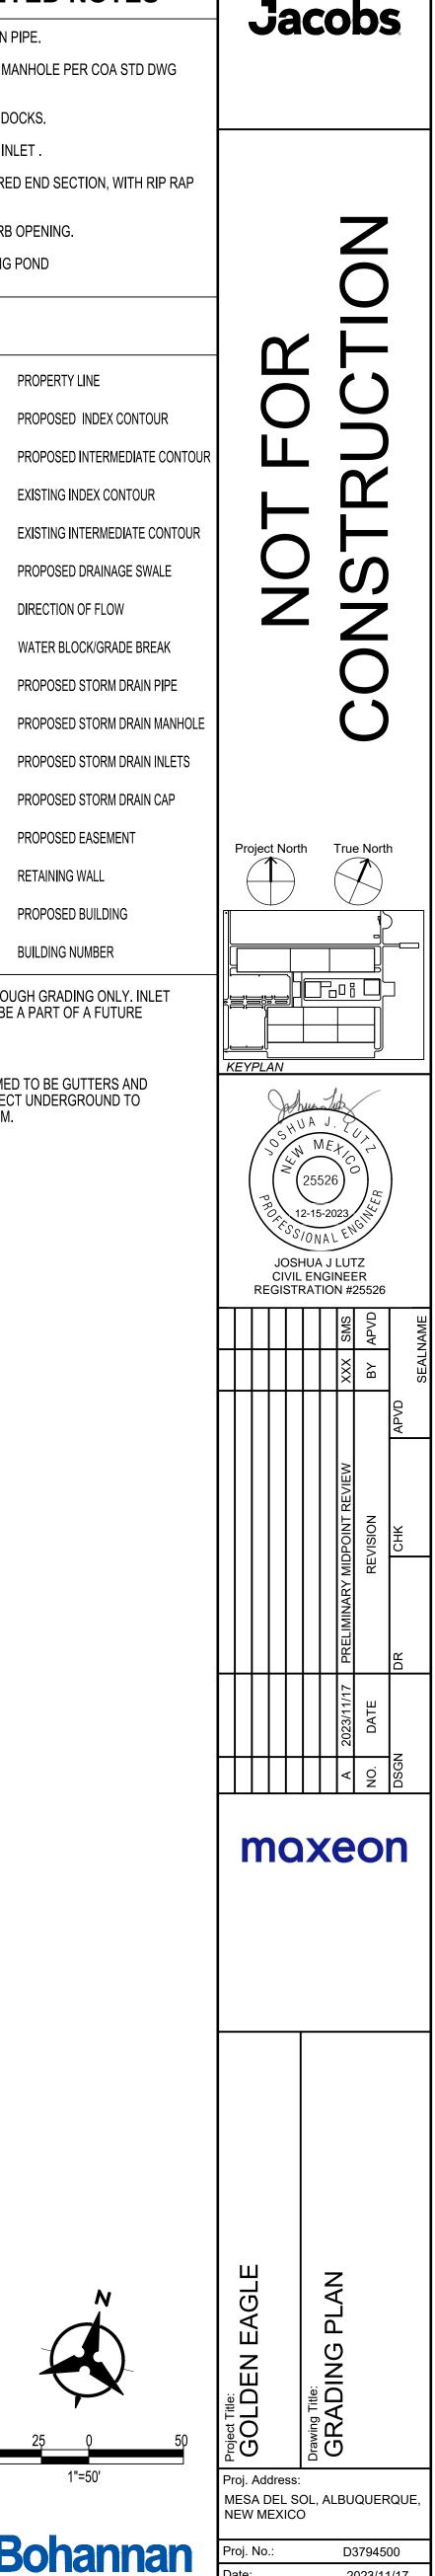


2023/11/17 1" = 50' wina No C-00-G-10-04

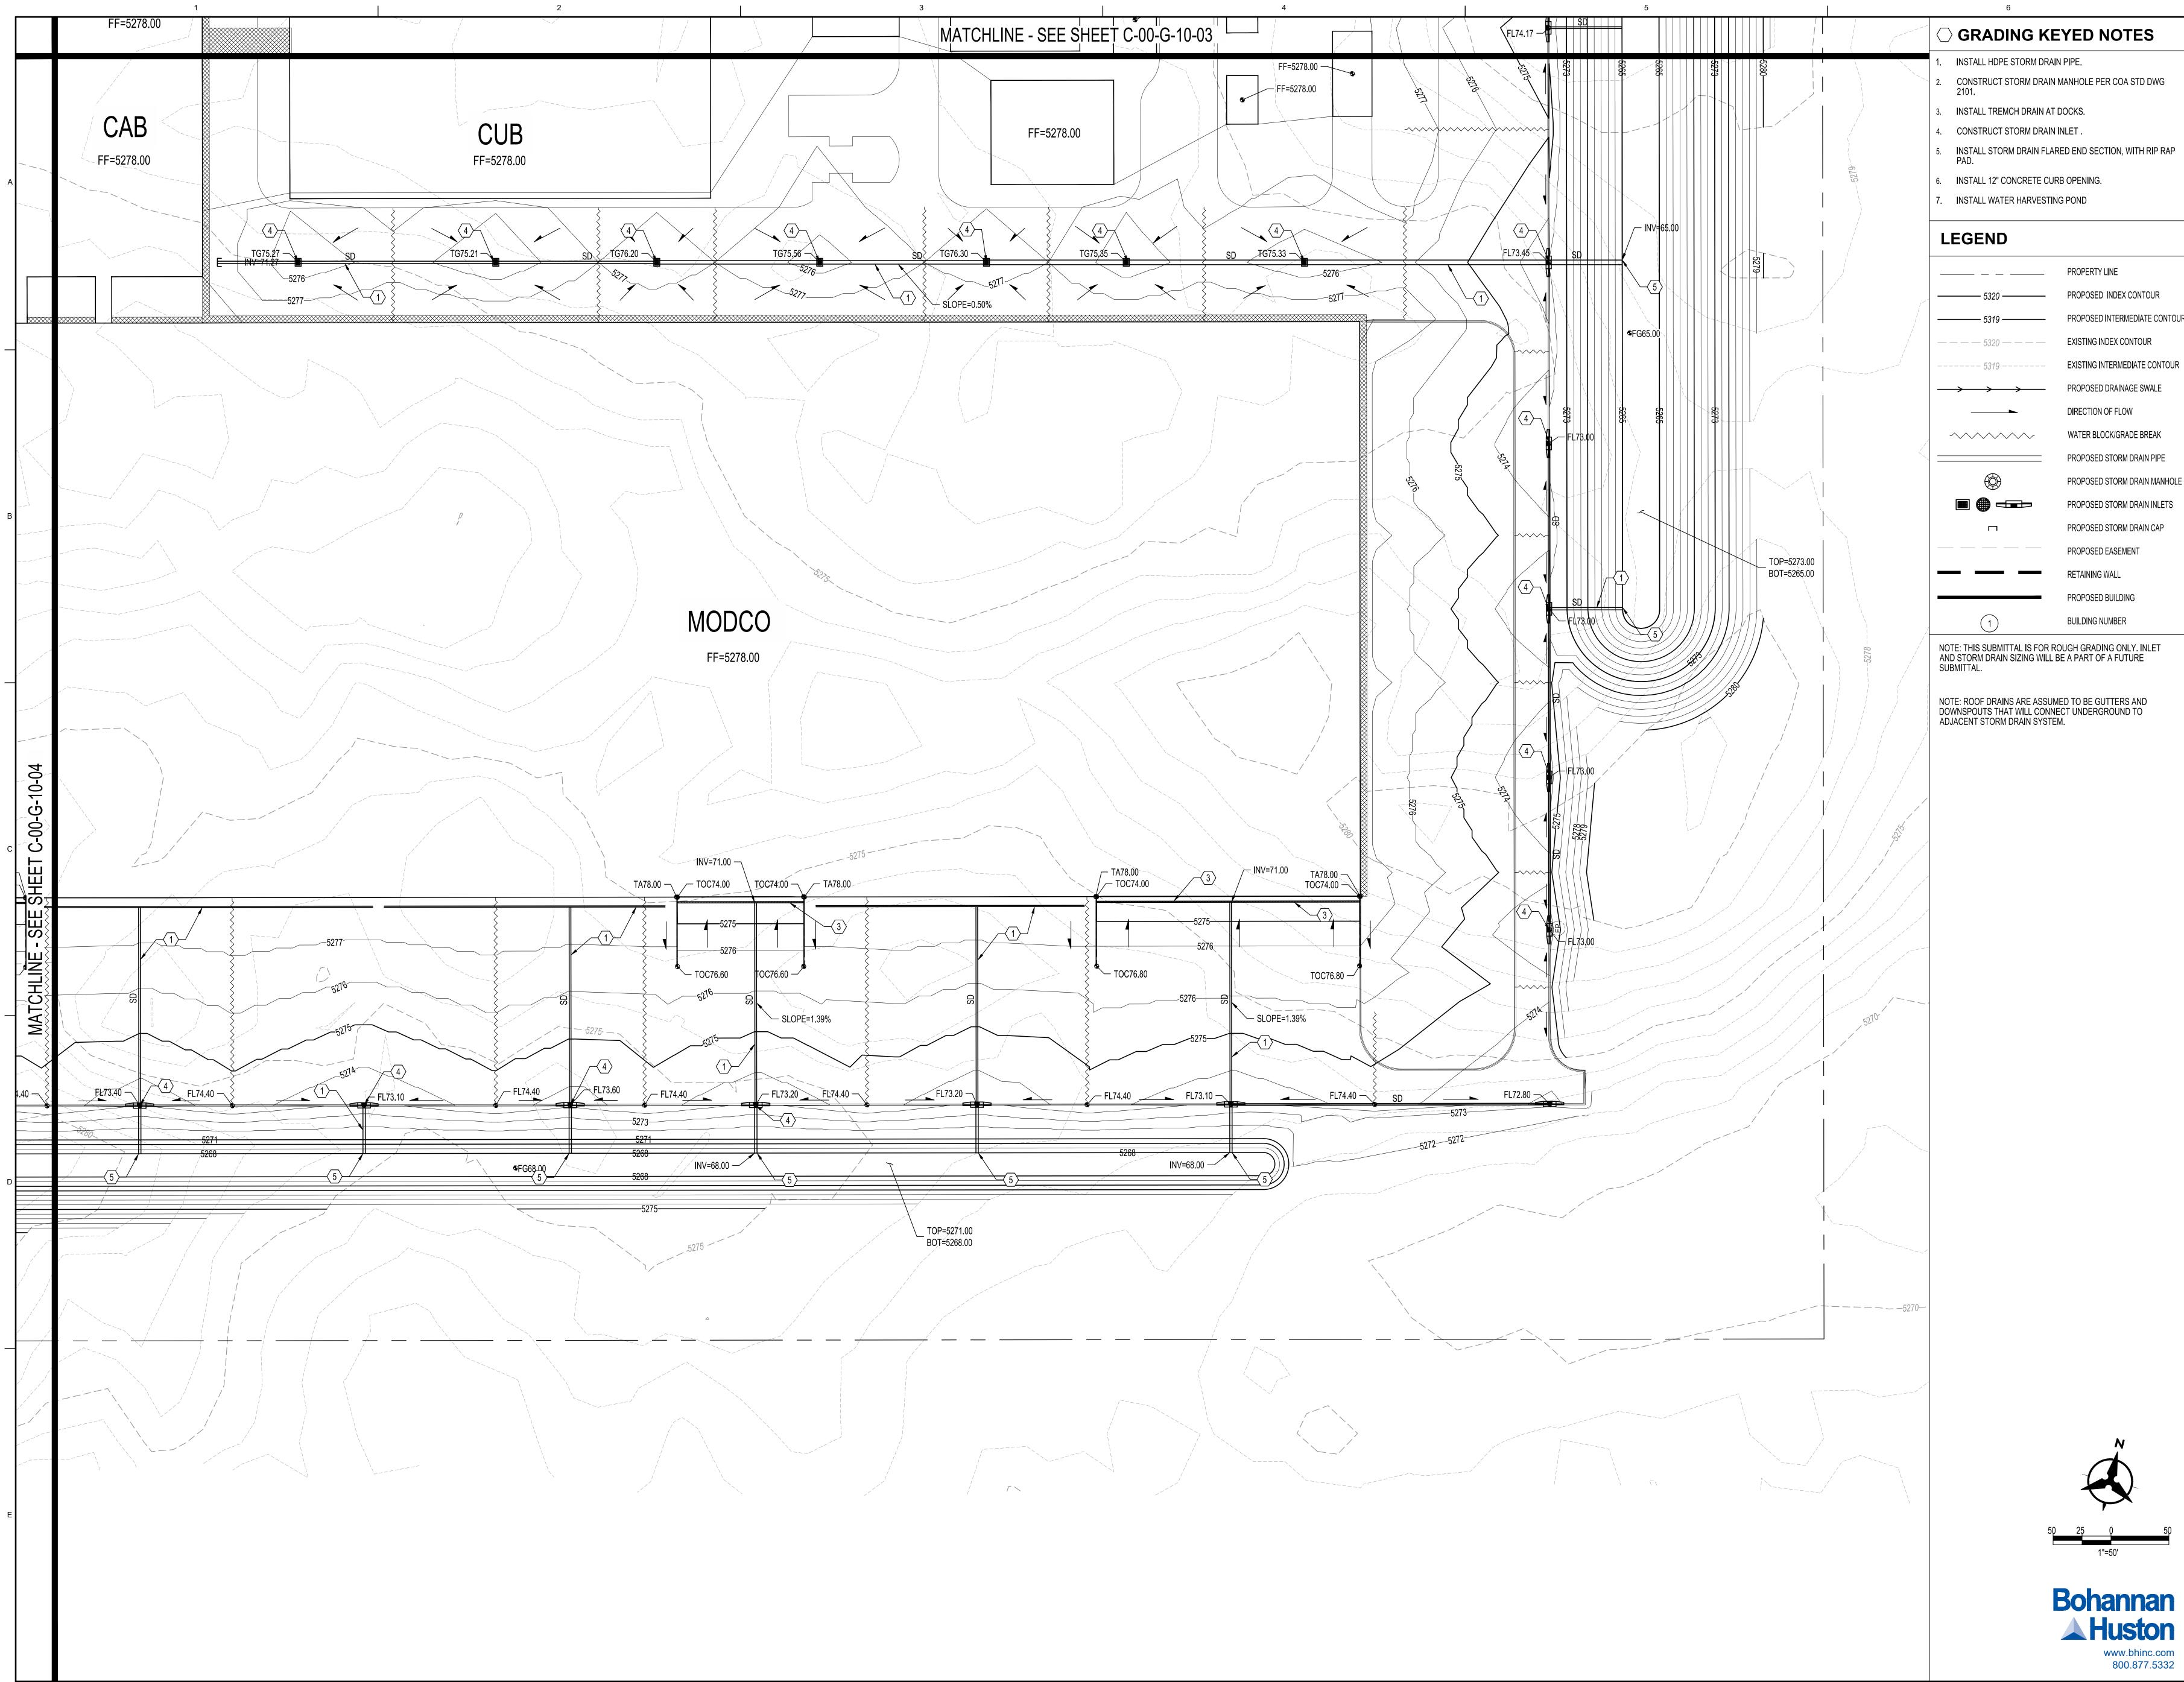

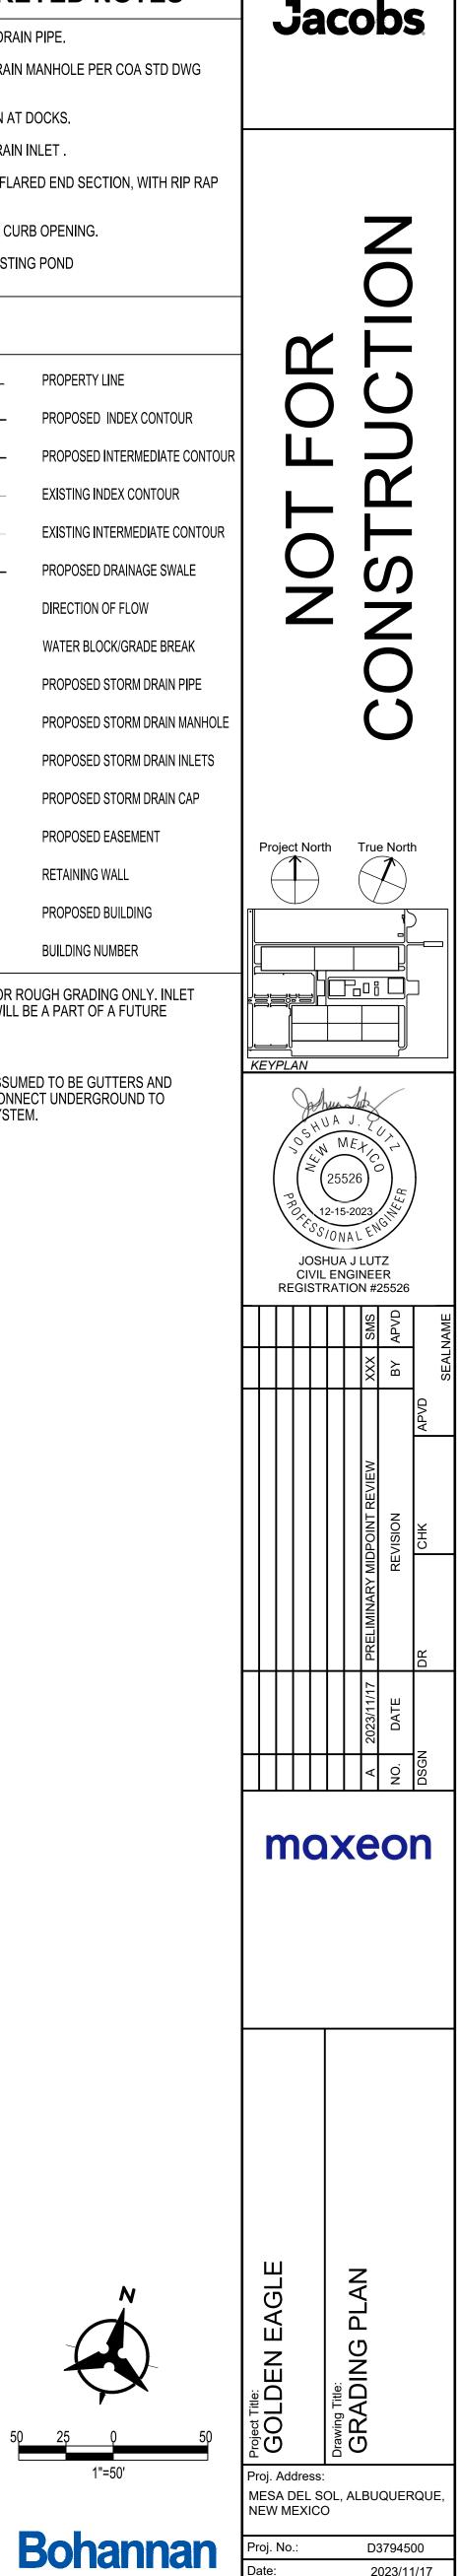

2023/11/17 1" = 50' C-00-G-10-05

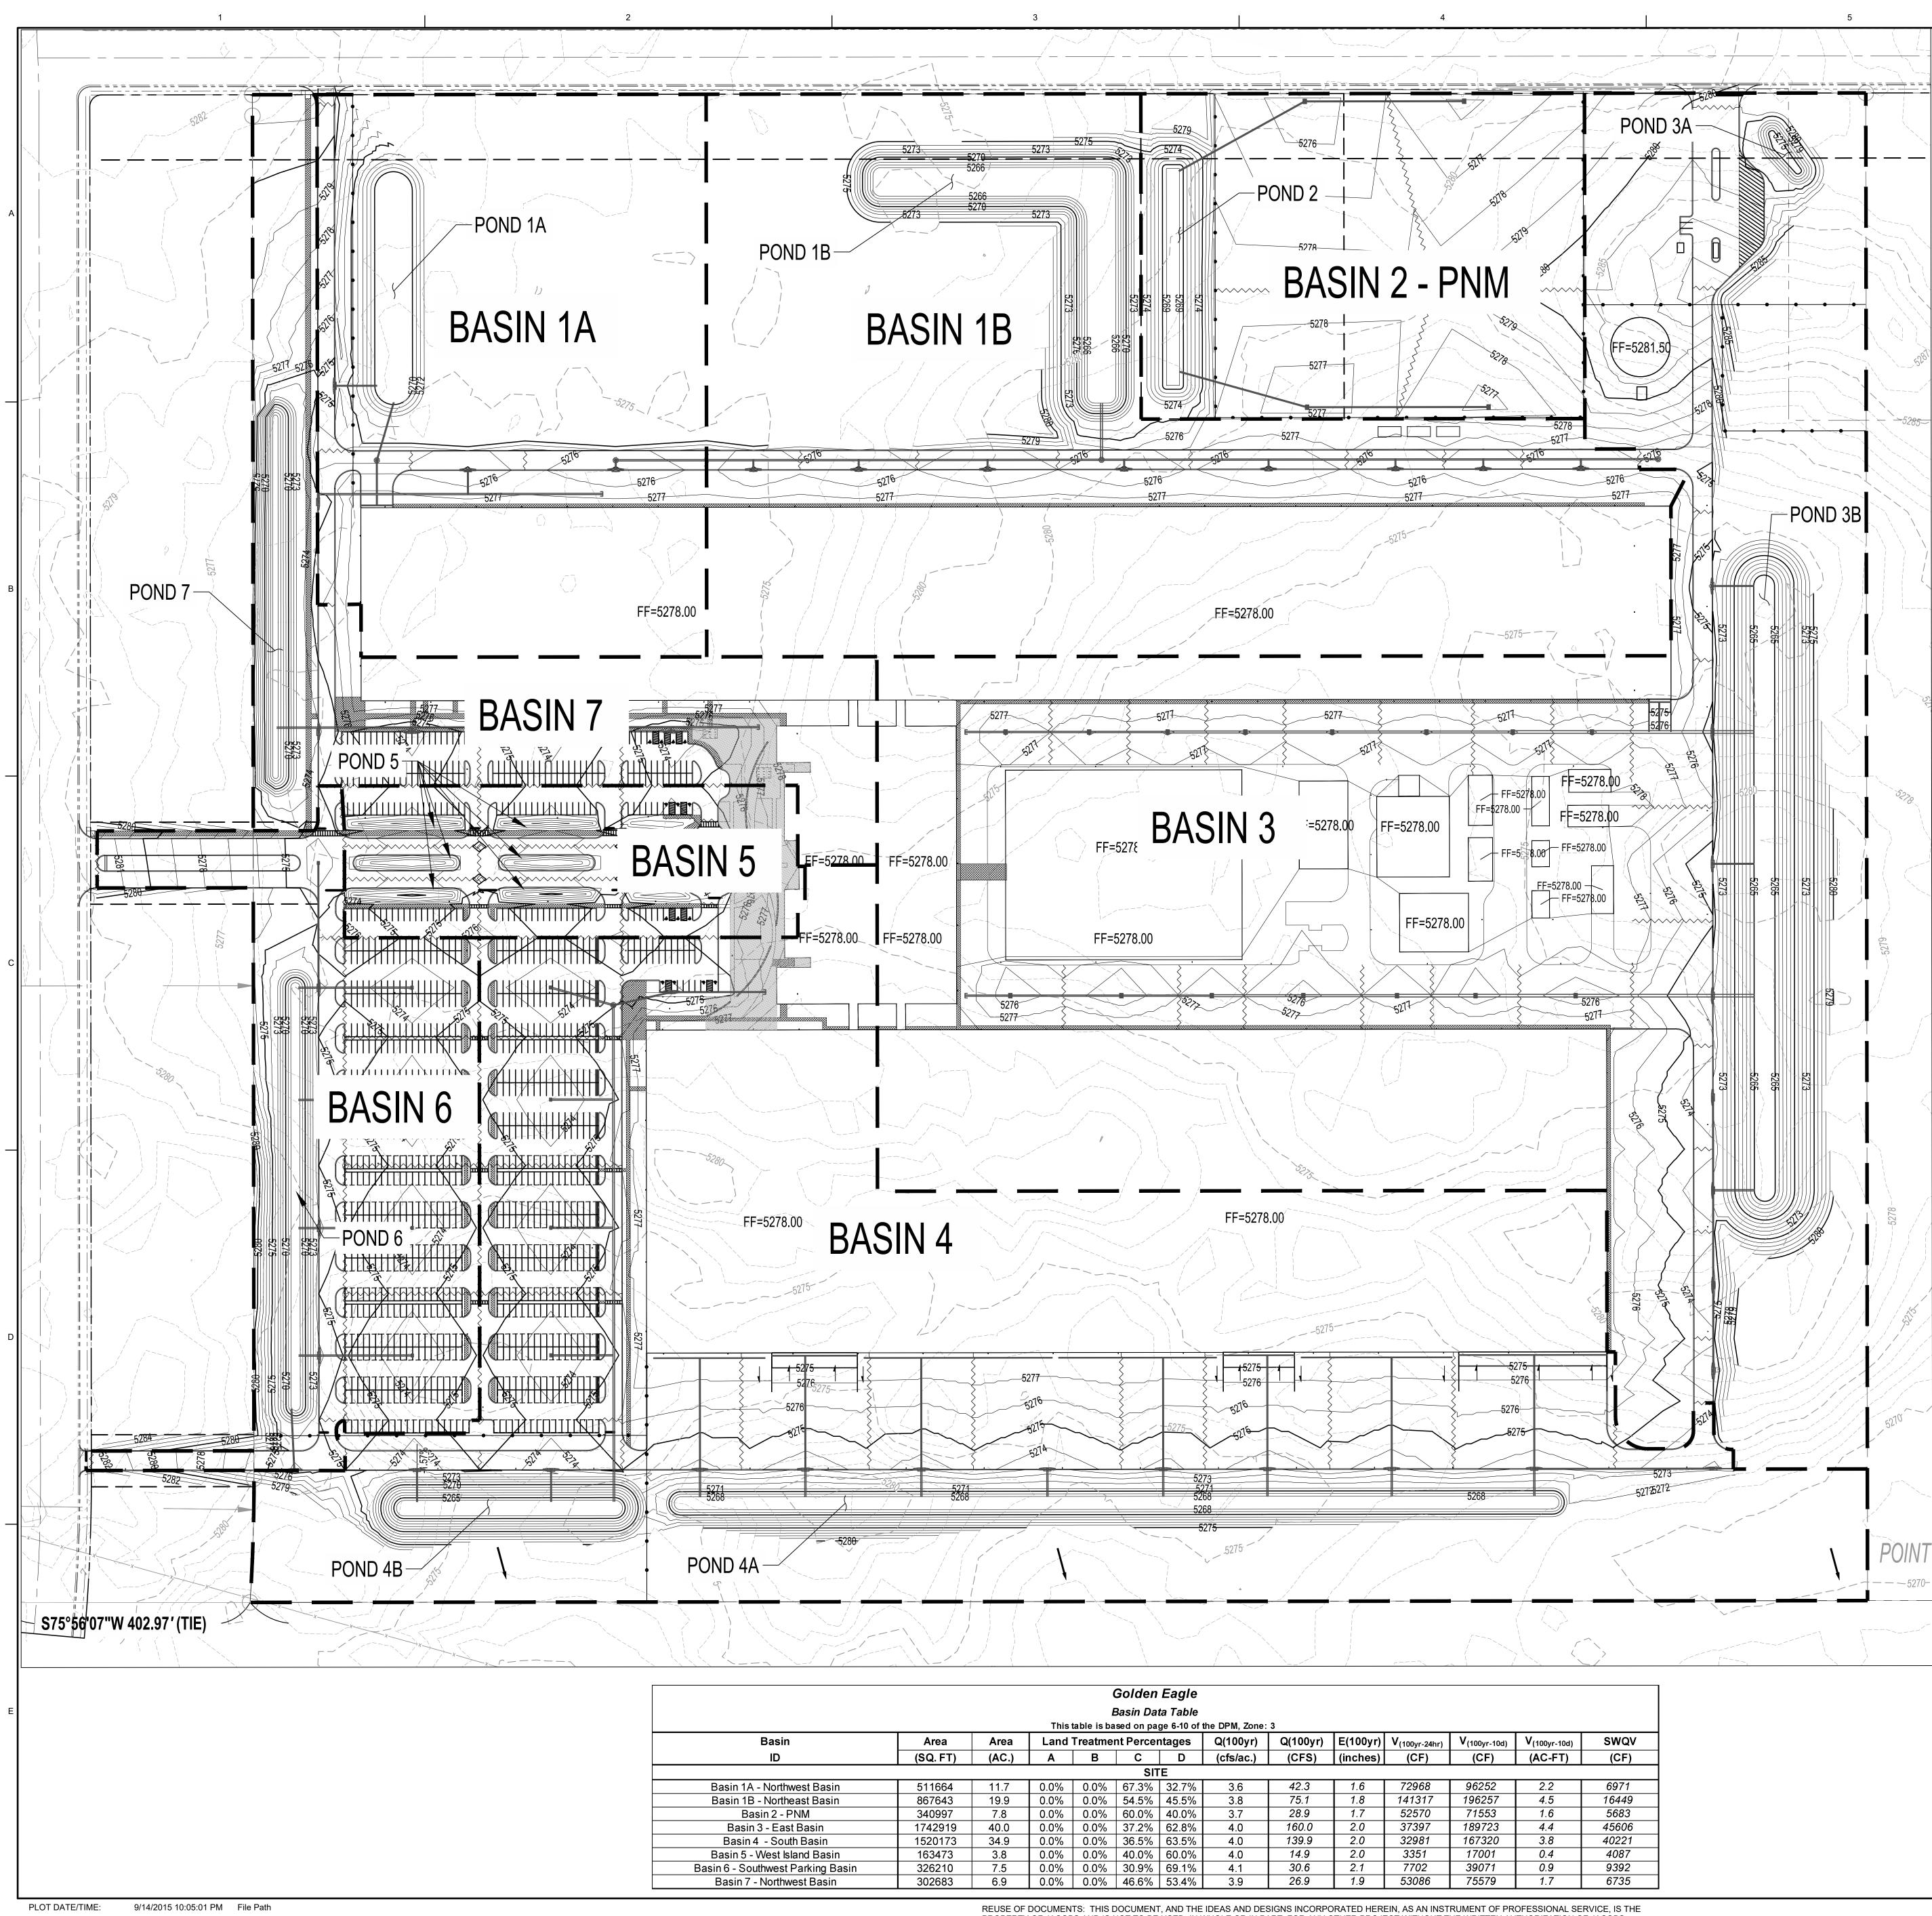

			, i	Joiden	Layle							
			E	Basin Dat	ta Table							
This table is based on page 6-10 of the DPM, Zone: 3												
Basin Area Area Land Trea		reatment Percentages		Q(100yr) Q(100	Q(100yr)	0yr) E(100yr)	V _(100yr-24hr)	V _(100yr-10d)	V _(100yr-10d)	SWQV		
(SQ. FT)	(AC.)	Α	В	С	D	(cfs/ac.)	(CFS)	(inches)	(CF)	(CF)	(AC-FT)	(CF)
				SIT	E							
511664	11.7	0.0%	0.0%	67.3%	32.7%	3.6	42.3	1.6	72968	96252	2.2	6971
867643	19.9	0.0%	0.0%	54.5%	45.5%	3.8	75.1	1.8	141317	196257	4.5	16449
340997	7.8	0.0%	0.0%	60.0%	40.0%	3.7	28.9	1.7	52570	71553	1.6	5683
1742919	40.0	0.0%	0.0%	37.2%	62.8%	4.0	160.0	2.0	37397	189723	4.4	45606
1520173	34.9	0.0%	0.0%	36.5%	63.5%	4.0	139.9	2.0	32981	167320	3.8	40221
163473	3.8	0.0%	0.0%	40.0%	60.0%	4.0	14.9	2.0	3351	17001	0.4	4087
326210	7.5	0.0%	0.0%	30.9%	69.1%	4.1	30.6	2.1	7702	39071	0.9	9392
302683	6.9	0.0%	0.0%	46.6%	53.4%	3.9	26.9	1.9	53086	75579	1.7	6735
	(SQ. FT) 511664 867643 340997 1742919 1520173 163473 326210	(SQ. FT) (AC.) 511664 11.7 867643 19.9 340997 7.8 1742919 40.0 1520173 34.9 163473 3.8 326210 7.5	Area Area Land (SQ. FT) (AC.) A 511664 11.7 0.0% 867643 19.9 0.0% 340997 7.8 0.0% 1742919 40.0 0.0% 1520173 34.9 0.0% 163473 3.8 0.0% 326210 7.5 0.0%	Area Area Land Treatment (SQ.FT) (AC.) A B 511664 11.7 0.0% 0.0% 511664 19.9 0.0% 0.0% 340997 7.8 0.0% 0.0% 1742919 40.0 0.0% 0.0% 1520173 34.9 0.0% 0.0% 163473 3.8 0.0% 0.0% 326210 7.5 0.0% 0.0%	Basin Data This table is based on page Area Area Land Treatment Percent (SQ.FT) (AC.) A B C 511664 11.7 0.0% 0.0% 67.3% 867643 19.9 0.0% 0.0% 54.5% 340997 7.8 0.0% 0.0% 60.0% 1742919 40.0 0.0% 0.0% 35.5% 1520173 34.9 0.0% 0.0% 36.5% 163473 3.8 0.0% 0.0% 30.9%	Area Area Land Treatment Percentages (SQ.FT) (AC.) A B C D 511664 11.7 0.0% 0.0% 67.3% 32.7% 511664 11.7 0.0% 0.0% 54.5% 45.5% 340997 7.8 0.0% 0.0% 60.0% 40.0% 1742919 40.0 0.0% 0.0% 36.5% 63.5% 1520173 34.9 0.0% 0.0% 40.0% 60.0% 163473 3.8 0.0% 0.0% 30.9% 69.1%	Basin Data Table Basin Data Table This table is based on page 6-10 of the DPM, Zone: Area Area Land Treatment Percentages Q(100yr) (SQ.FT) (AC.) A B C D (cfs/ac.) SITE Site	Basin Data Table Basin Data Table This table is based on page 6-10 of the DPM, Zone: 3 Area Area Land Treatment Percentages Q(100yr) Q(100yr) (SQ. FT) (AC.) A B C D (cfs/ac.) (CFS) 511664 11.7 0.0% 0.0% 67.3% 32.7% 3.6 42.3 867643 19.9 0.0% 0.0% 60.0% 45.5% 3.8 75.1 340997 7.8 0.0% 0.0% 37.2% 62.8% 4.0 160.0 1520173 34.9 0.0% 0.0% 36.5% 63.5% 4.0 139.9 163473 3.8 0.0% 0.0% 30.9% 69.1% 4.1 30.6	Basin Data Table This table is based on page 6-10 of the DPM, Zone: 3 Area Area Land Treatment Percentages Q(100yr) Q(100yr) E(100yr) (SQ.FT) (AC.) A B C D (cfs/ac.) (CFS) (inches) SITE 511664 11.7 0.0% 0.0% 67.3% 32.7% 3.6 42.3 1.6 867643 19.9 0.0% 0.0% 54.5% 45.5% 3.8 75.1 1.8 340997 7.8 0.0% 0.0% 37.2% 62.8% 4.0 160.0 2.0 1742919 40.0 0.0% 0.0% 36.5% 63.5% 4.0 139.9 2.0 1520173 34.9 0.0% 0.0% 30.9% 69.1% 4.1 30.6 2.1	Basin Data Table Basin Data Table This table is based on page 6-10 of the DPM, Zone: 3 Area Area Land Treatment Percentages Q(100yr) Q(100yr) E(100yr) V(100yr.24hr) (SQ.FT) (AC.) A B C D (cfs/ac.) (CFS) (inches) (CF) SITE 511664 11.7 0.0% 0.0% 67.3% 32.7% 3.6 42.3 1.6 72968 867643 19.9 0.0% 0.0% 54.5% 45.5% 3.8 75.1 1.8 141317 340997 7.8 0.0% 0.0% 40.0% 3.7 28.9 1.7 52570 1742919 40.0 0.0% 36.5% 63.5% 4.0 160.0 2.0 37397 1520173 34.9 0.0% 0.0% 60.0% 4.0 14.9 2.0 3251 163473 3.8 0.0% 0.0% 60.0% 4.0	Jasin Data Table This table is based on page 6-10 of the DPM, Zone: 3 Area Area Land Treatment Percentages Q(100yr) Q(100yr) E(100yr) V _(100yr-24hr) V _(100yr-10d) (SQ. FT) (AC.) A B C D (cfs/ac.) (CFS) (inches) (CF) (CF) 511664 11.7 0.0% 0.0% 67.3% 32.7% 3.6 42.3 1.6 72968 96252 867643 19.9 0.0% 0.0% 54.5% 3.8 75.1 1.8 141317 196257 340997 7.8 0.0% 0.0% 62.8% 4.0 160.0 2.0 37397 189723 1742919 40.0 0.0% 36.5% 63.5% 4.0 139.9 2.0 32981 167320 1520173 34.9 0.0% 0.0% 60.0% 4.0 14.9 2.0 3351 17001 163473 3.8 0.0% 0.0% 30.9%	Basin Data Table This table is based on page 6-10 of the DPM, Zone: 3 Area Area Land Treatment Percentages Q(100yr) Q(100yr) E(100yr) V(100yr-24hr) V(100yr-10d) V(100yr-10d) (SQ. FT) (AC.) A B C D (cfs/ac.) (CFS) (inches) C(F) (CF) (AC.FT) 511664 11.7 0.0% 0.0% 67.3% 32.7% 3.6 42.3 1.6 72968 96252 2.2 867643 19.9 0.0% 0.0% 45.5% 3.8 75.1 1.8 141317 196257 4.5 340997 7.8 0.0% 0.0% 62.8% 4.0 160.0 2.0 37397 189723 4.4 1520173 34.9 0.0% 0.0% 63.5% 4.0 160.0 2.0 32981 167320 3.8 163473 3.8 0.0% 0.0% 60.0% 4.0 14.9 2.0 3351 17001

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DRAINAGE MANAGEMENT PLAN/WATER HARVESTING PLAN

I. INTRODUCTION THE PURPOSE OF THIS SUBMITTAL IS TO PRESENT A GRADING AND DRAINAGE PLAN IN CONJUNCTION WITH THE WATER HARVESTING PLAN FOR THE PROPOSED GOLDEN EAGLE DEVELOPMENT SITE. GOLDEN EAGLE SITS ON A FUTURE TRACT L OF THE FUTURE BULK PLAT TO BE SUBMITTED, APPROXIMATELY 130 ACRES, AND CONSISTS OF MULTIPLE INDUSTRIAL BUILDINGS, SUPPORT FACILITIES, ASSOCIATED PARKING AND A SEPARATE PNM TRACT. IT EXPECTED THAT THE SITE WILL GO THROUGH THE PERMITTING PROCESS AS ONE PHASE BU COULD REQUEST SEPERATE CERTIFICATES OF OCCUPANCY WHICH WILL BE DETAILED AT SUBSEQUENT HYDROLOGY BUILDING PERMIT APPROVALS. THIS GRADING AND DRAINAGE PLAN AND DRAINAGE MANAGEMENT/WATER HARVESTING PLAN HAS BEEN PREPARED I SUPPORT OF CITY OF ALBUQUERQUE DFT APPROVAL, AND ROUGH GRADING PERMIT

APPROVAL.

II. EXISTING HYDROLOGIC CONDITIONS THE SITE IS APPROXIMATELY 130 ACRES (INCLUDE A 6 ACRE PNM TRACT) AND IS CURRENTLY UNDEVELOPED. THE LAND IS RELATIVELY FLAT THROUGHOUT, WITH SLOPES RANGING FROM 0.3% TO 5% WITH A GENERAL TREND SLOPING FROM THE NORTH TO THE SOUTH. SPARSE VEGETATION COVER CAN BE SEEN ONSITE. ACCORDING TO FEMA COMMUNITY MAP PANEL

#35001C0555H THE SITE IS NOT LOCATED WITHIN A FLOOD PLAIN HOWEVER IS IN CLOSE BE UTILIZED TO ENSURE THEY HAVE NO IMPACT ON OUR SITE.

PROXIMITY TO FLOOD ZONES LABELED MESA DEL SOL PLAYA 1 AND MESA DEL SOL PLAYA 3 RESPECTIVELY. THESE ZONES HAVE BEEN IDENTIFIED AND PRECAUTIONARY MEASURES WIL III. PROPOSED HYDROLOGIC CONDITIONS

THE 100 YR. 10 DAY DEVELOPED FLOWS FROM THE ENTIRE 130 ACRE SITE ARE RETAINED ONSITE WITHIN RETENTION/WATER HARVESTING PONDS THAT HAVE BEEN PLACED STRATEGICALLY THROUGHOUT. THE SITE WAS DIVIDED INTO MULTIPLE BASINS AND DRAINS BOTH OVERLAND OR THROUGH A SYSTEM OF STORM DRAINS TO RETENTION PONDS. EACH BASIN HAS A PONDING LOCATION WHICH IS DESIGNED TO RETAIN THE VOLUME OF THE 100 YR. 10 DAY STORM. THE STORM WATER QUALITY VOLUME IS CALCULATED USING 0.5" EVENT.

IV. OFFSITE FLOWS

IN EXISTING CONDITIONS, THE SITE IS IMPACTED BY SIGNIFICANT OFFSITE FLOWS COMING FROM THE WEST, NORTH, AND EAST DIRECTIONS. THESE FLOWS SHALL BE DIVERTED AROUND OUR SITE BY WAY OF REGIONAL INFRASTRUCTURE DEVELOPED THROUGH OTHER PROJECTS

AND SHALL NOT IMPACT THE SITE. V. CONCLUSION

THE TOTAL FLOW GENERATED ON SITE WILL BE RETAINED ON SITE. THESE FLOWS WERE COMPUTED IN ACCORDANCE WITH SECTION 6-10 OF THE DEVELOPMENT PROCESS MANUAL THIS DRAINAGE MANAGEMENT PLAN/WATER HARVESTING PLAN IS CAPABLE OF SAFELY MITIGATING THE 100 YEAR 10 DAY STORM AND MEETS CITY REQUIREMENTS AND MEETS MESA DEL SOL LEVEL B REQUIREMENTS FOR STORM WATER HARVESTING.

LEGEND	
BASIN 1	BASIN ID
POND 1	POND ID
	BASIN BOUNDARY
	MANHOLE
	CURB INLET
	GRATE INLET
	STORM DRAIN PIP

Retention Pond ID	Contributing Basins	Req'd Volume (V100, 10day) (acre-feet)	Provided Vo (acre-fee	
Pond 1A	Basin 1A	2.2	2.6	
Pond 1B	Basin 1B	4.5	8.3	
Pond 2	Basin 2	1.6	2.1	
Pond 3A	Basin 3	0.3	0.3	
Pond 3B	Basin 3	4.2	14.9	
Pond 4A	Basin 4	2.9	3.3	
Pond 4B	Basin 4	0.9	4.9	
Pond 5	Basin 5	0.4	0.4	
Pond 6	Basin 6	0.9	2.8	
Pond 7	Basin 7	1.7	3.1	





